


# ASHBOURNE SOUTHERN SOLAR FARM FOR MATAMATA DEVELOPMENTS LTD

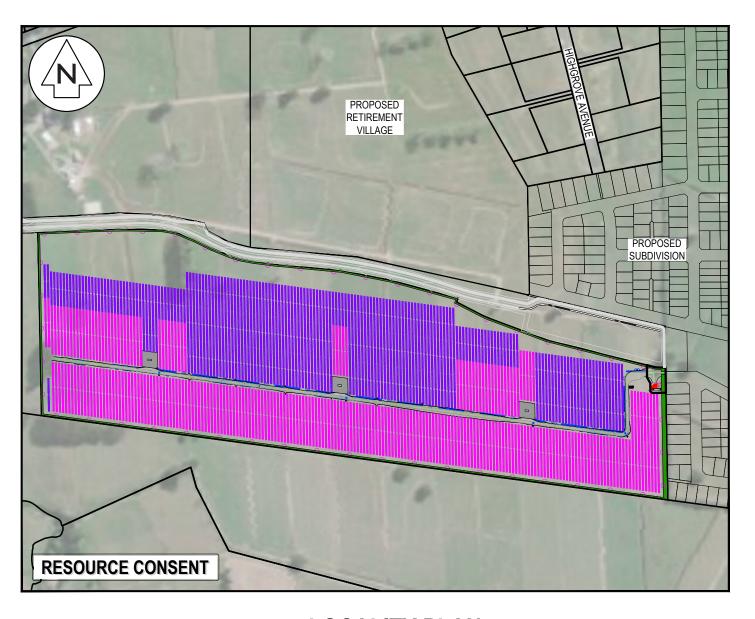

SHT.NO.	SHEET TITLE	REVISION
C000	COVER SHEET & INDEX	E
C090	EXISTING FEATURES AND REMOVAL PLAN	В
C200	EXISTING CONTOURS	В
C210	PROPOSED CONTOURS	E
C220	CUT-FILL PLAN	D
C230	SEDIMENT & EROSION CONTROL PLAN	E
C240	SEDIMENT & EROSION CONTROL DETAILS	А
C300	ROADING LAYOUT PLAN	E
C320	ROADING LONGSECTIONS	A
C340	ROADING TYPICAL SECTIONS	A
C380	ROADING STANDARD DETAILS	A
C480	STORM WATER DETAILS	A
C700	SERVICES LAYOUT PLAN	E
C720	SUBSTATION CONNECTION PLAN	D


**LOCALITY PLAN** 

**PROJECT NUMBER: 289001** 

ISSUED DATE: JUNE 2025 ISSUE FOR: FAST TRACK APPLICATION







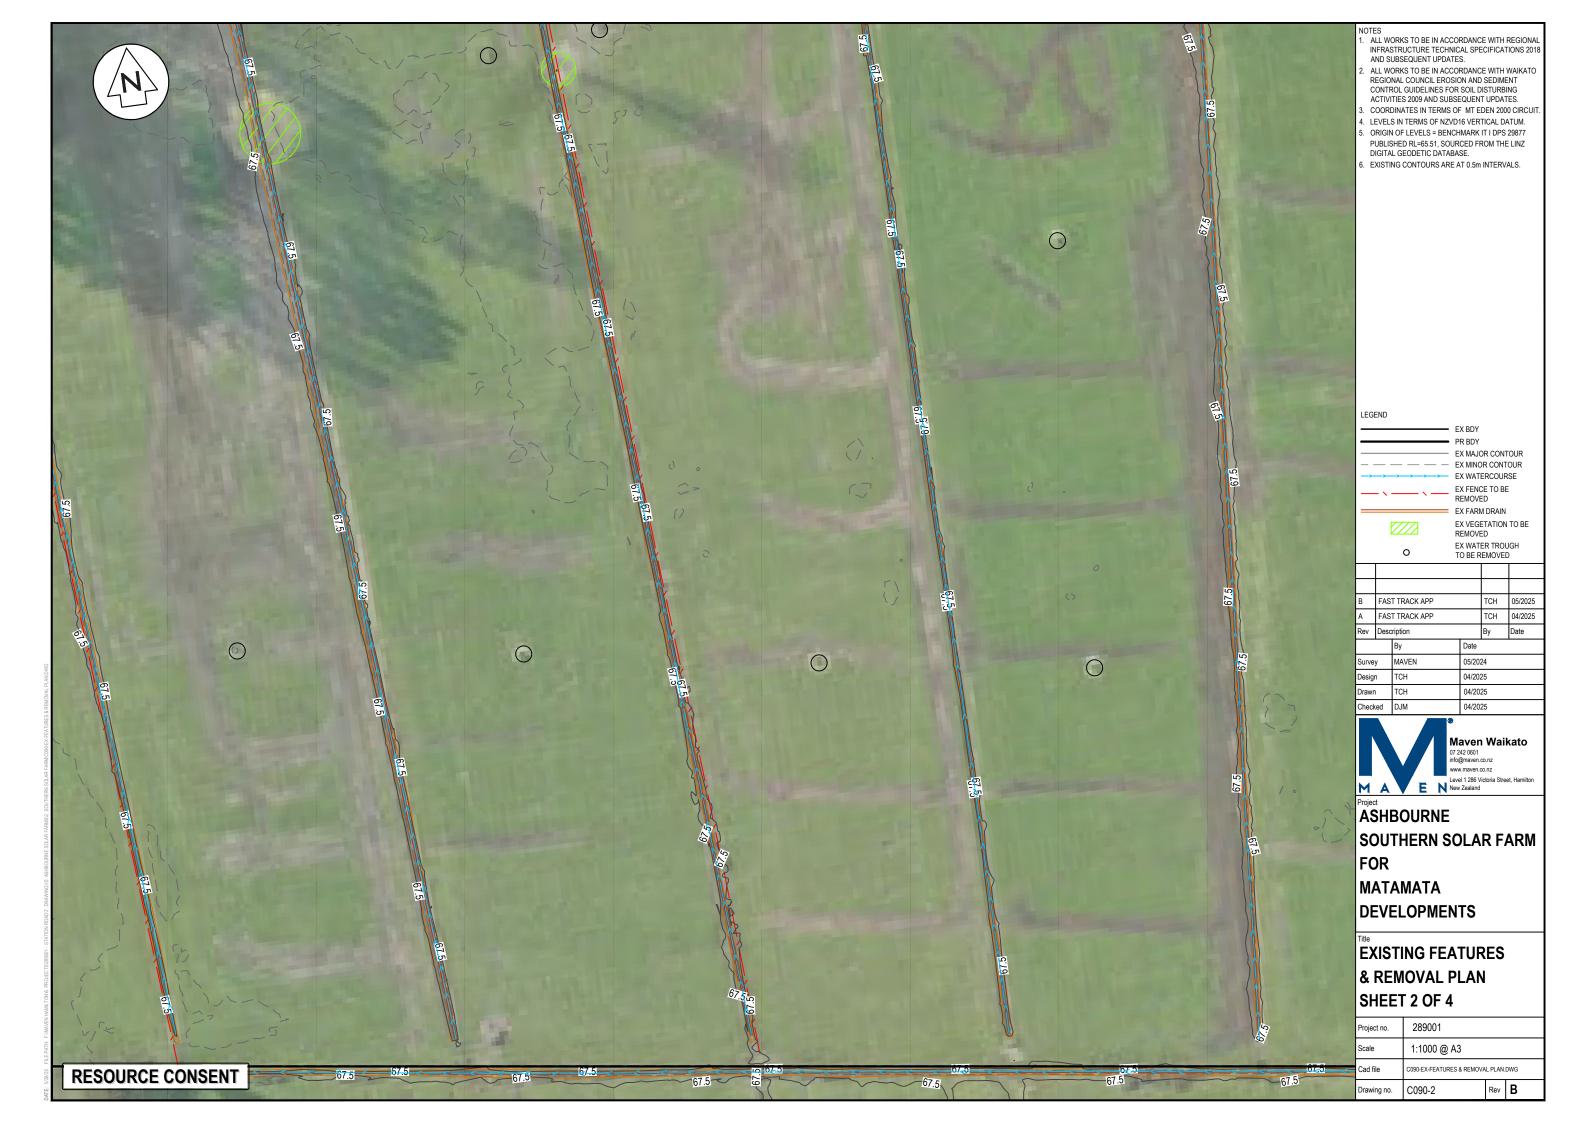







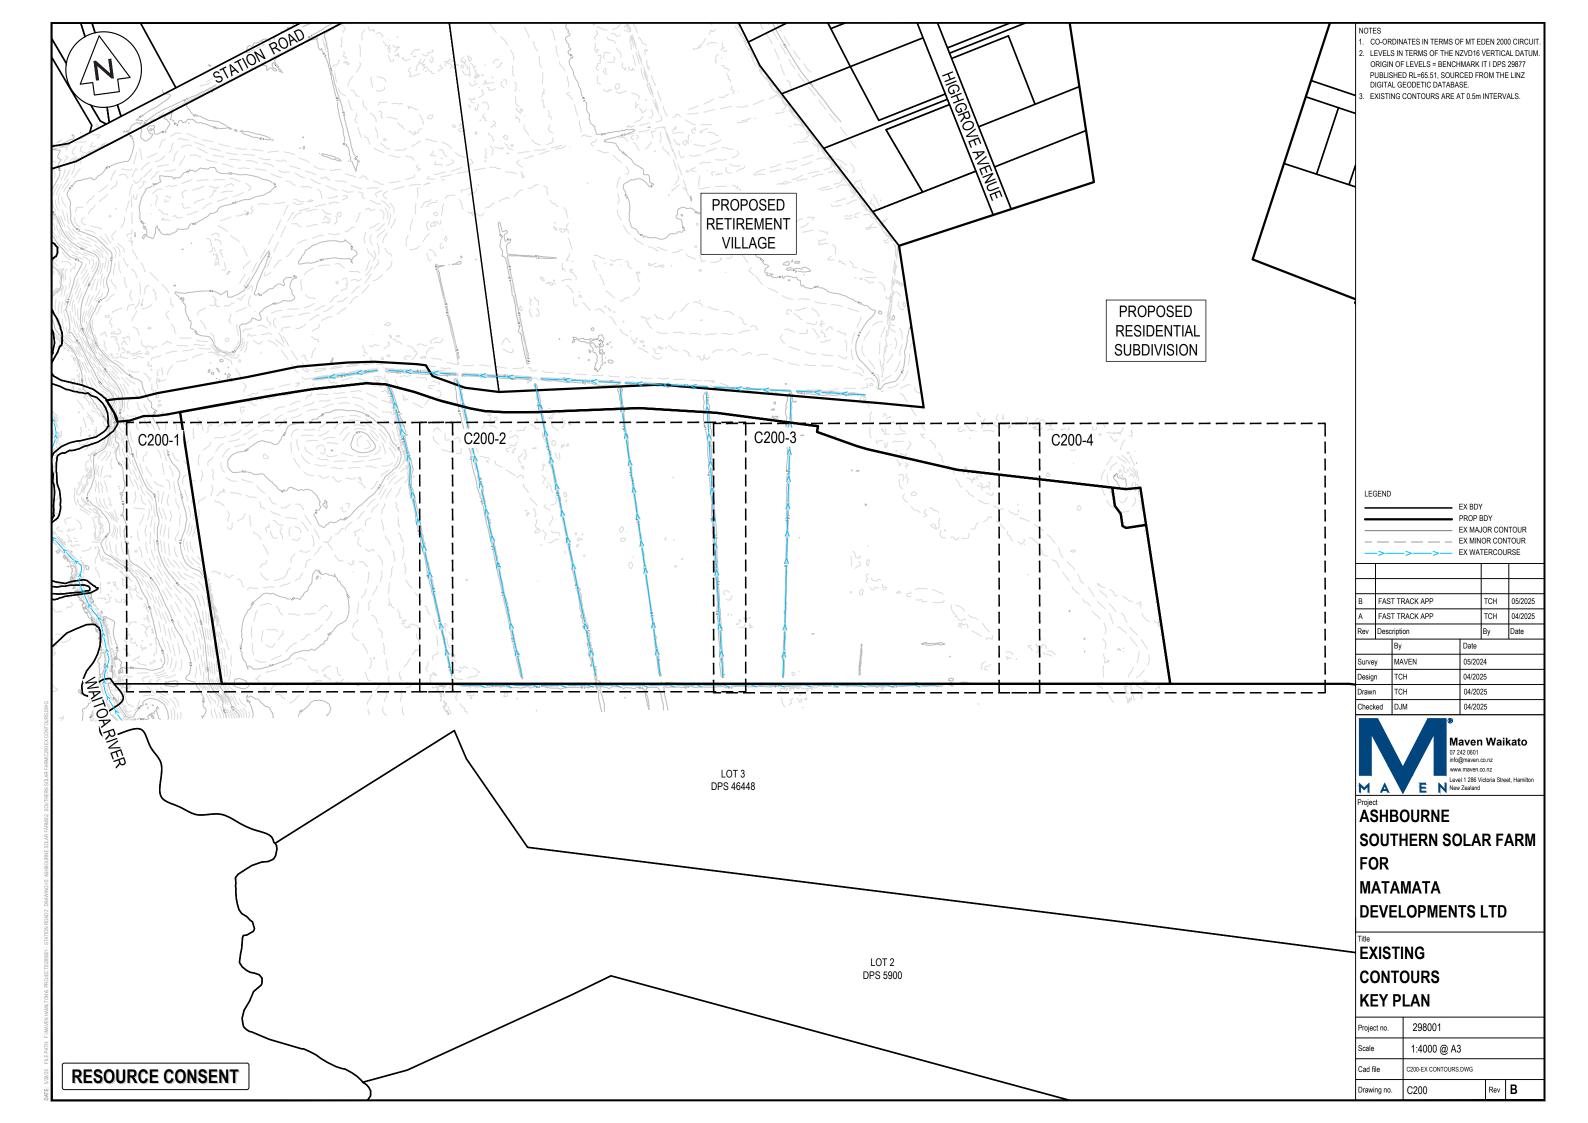

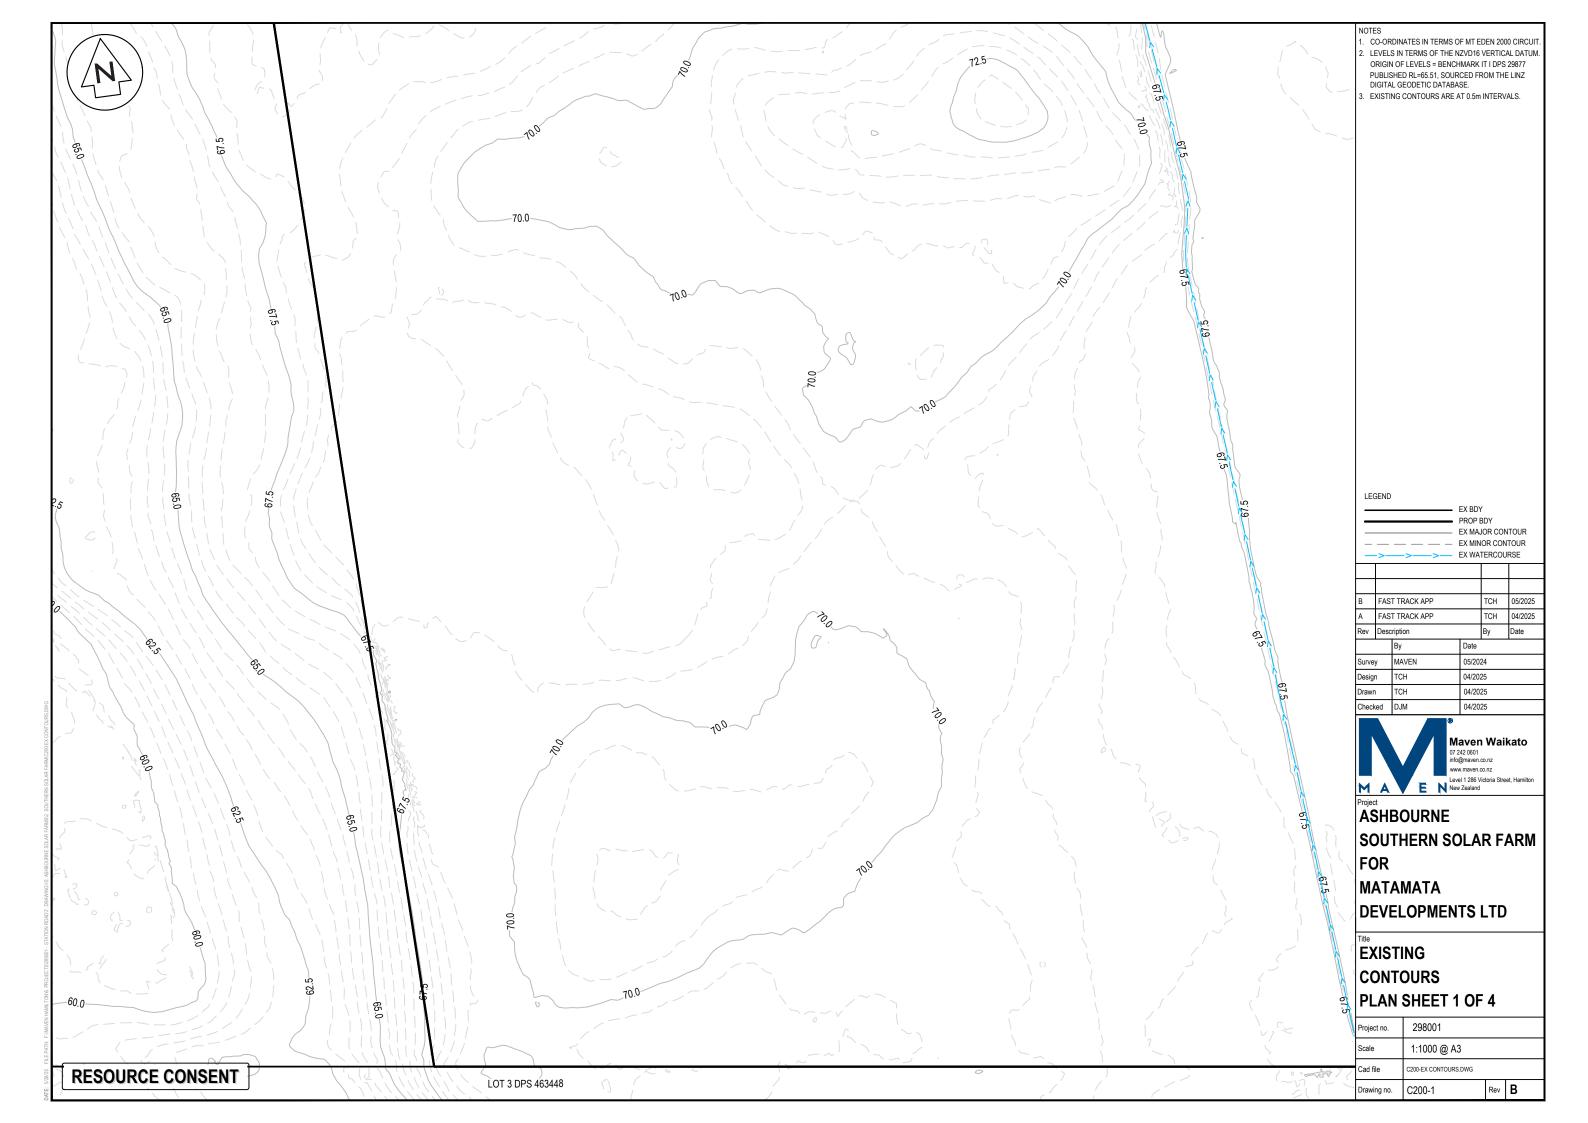


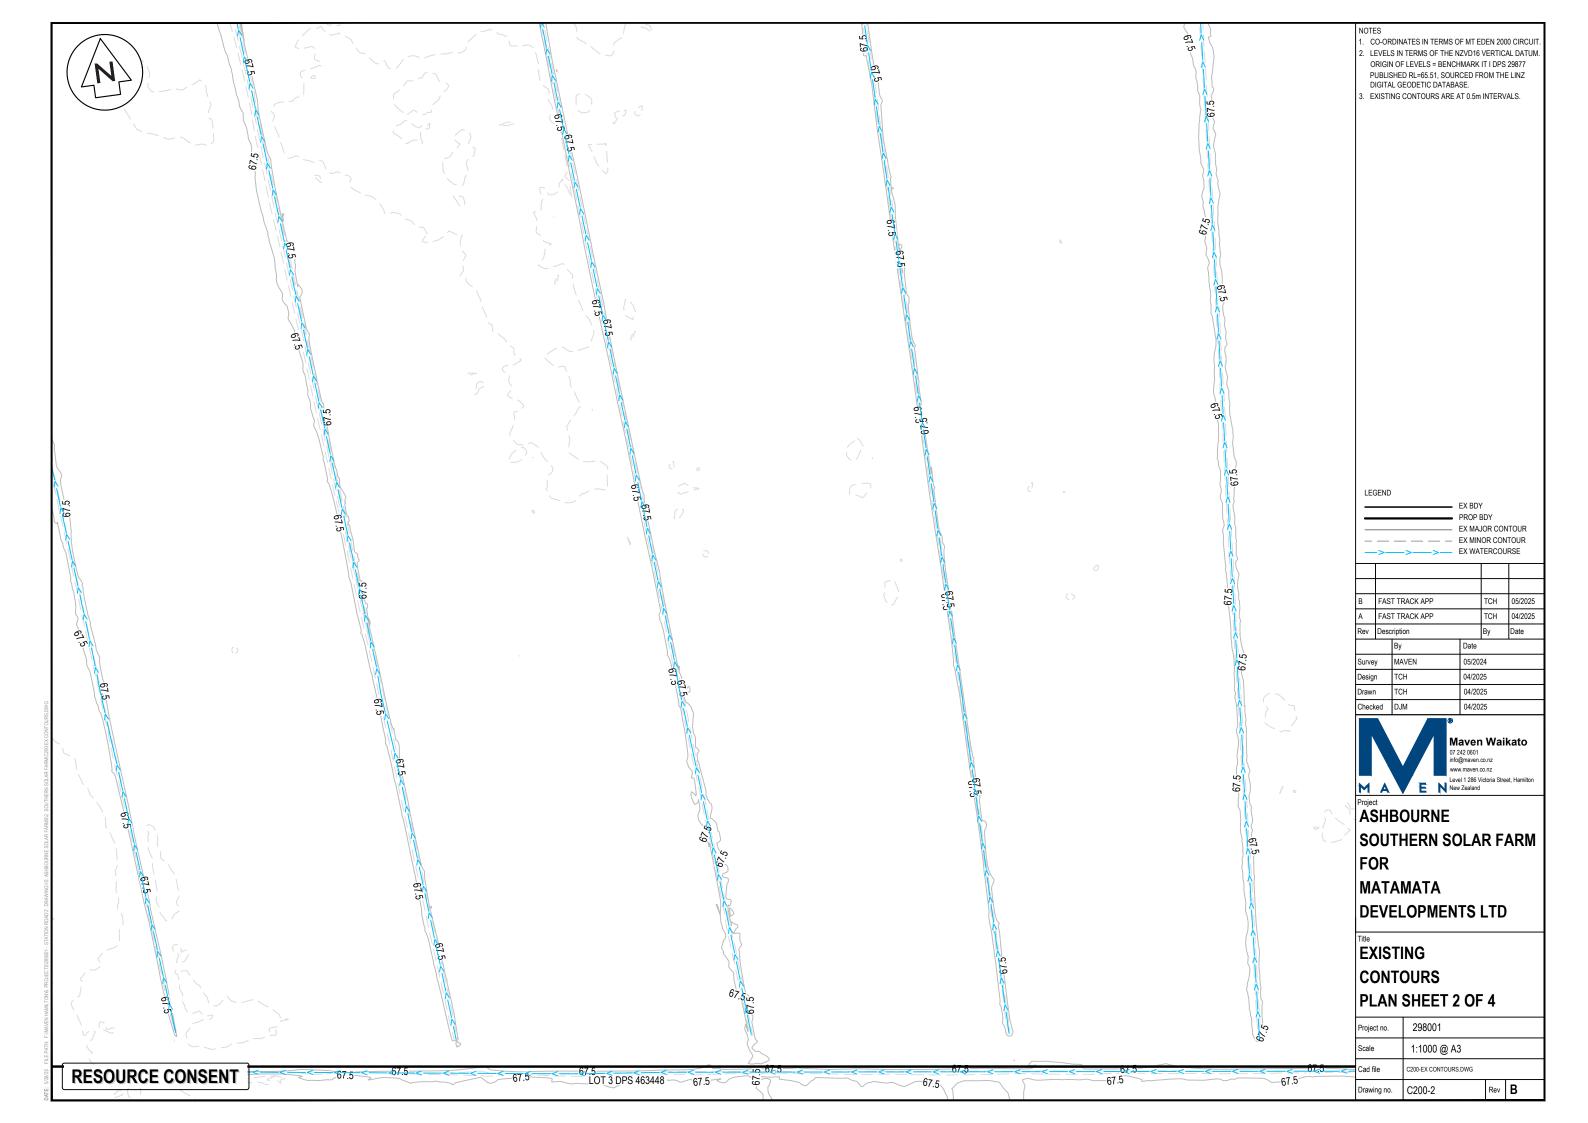


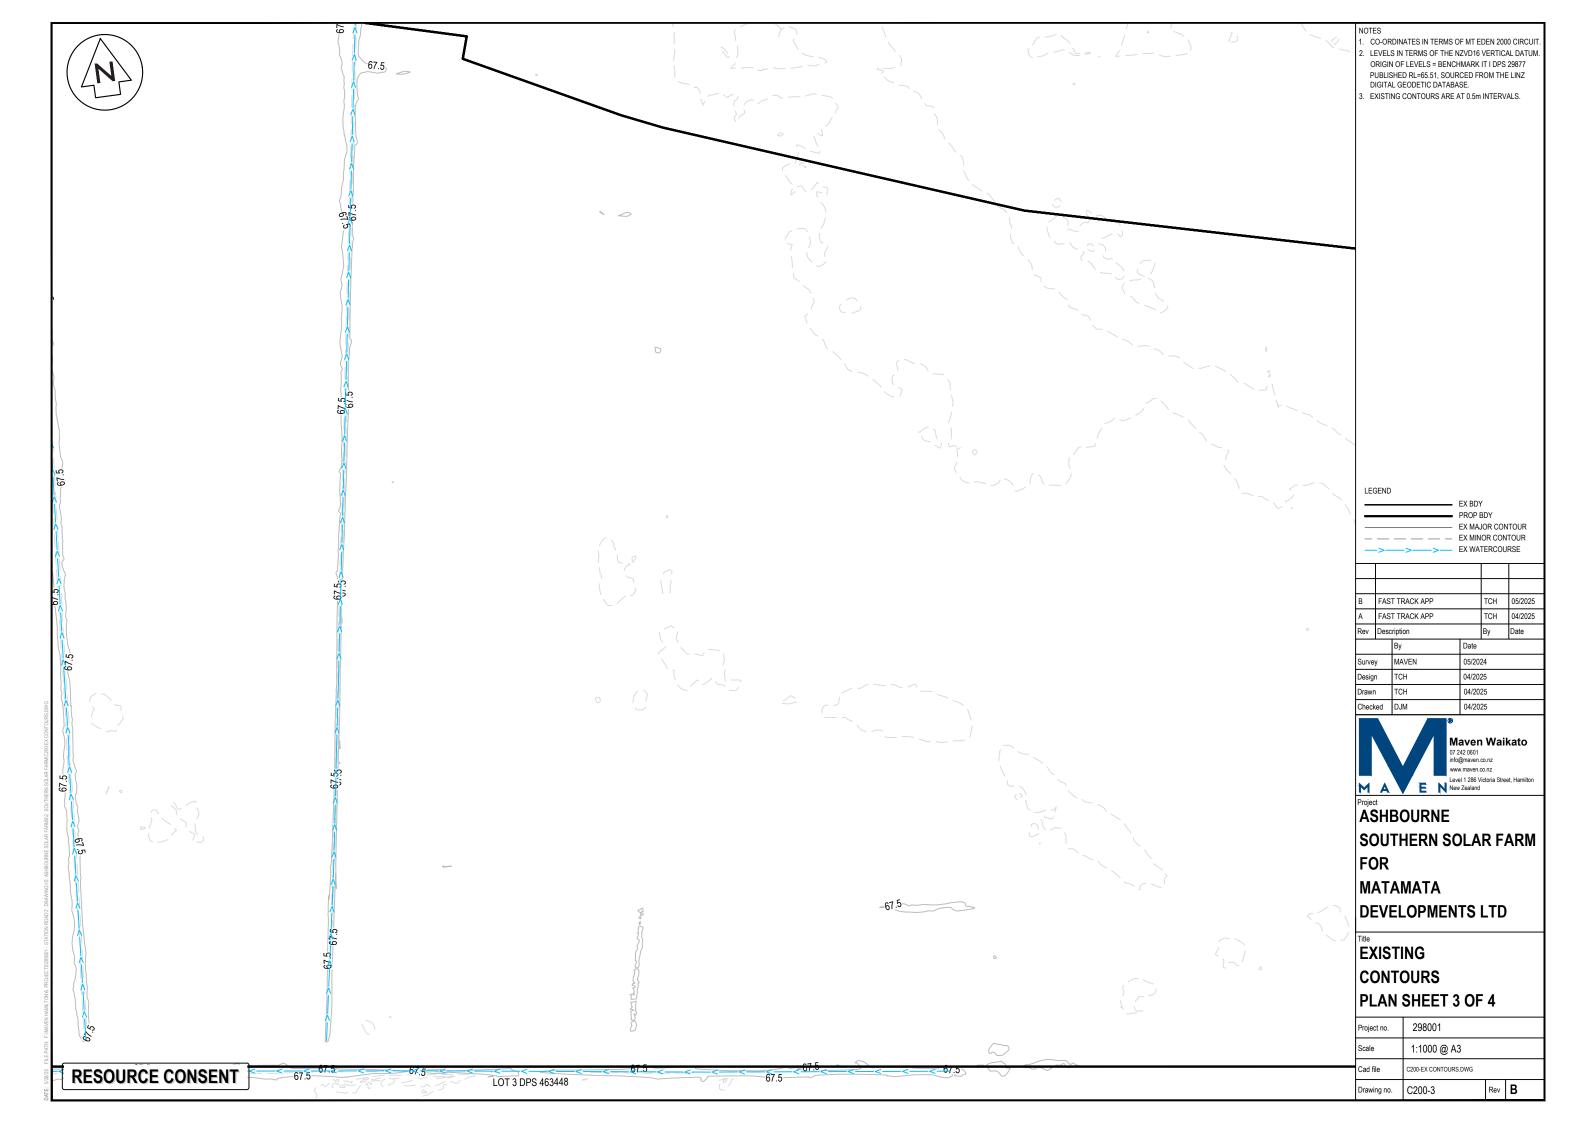






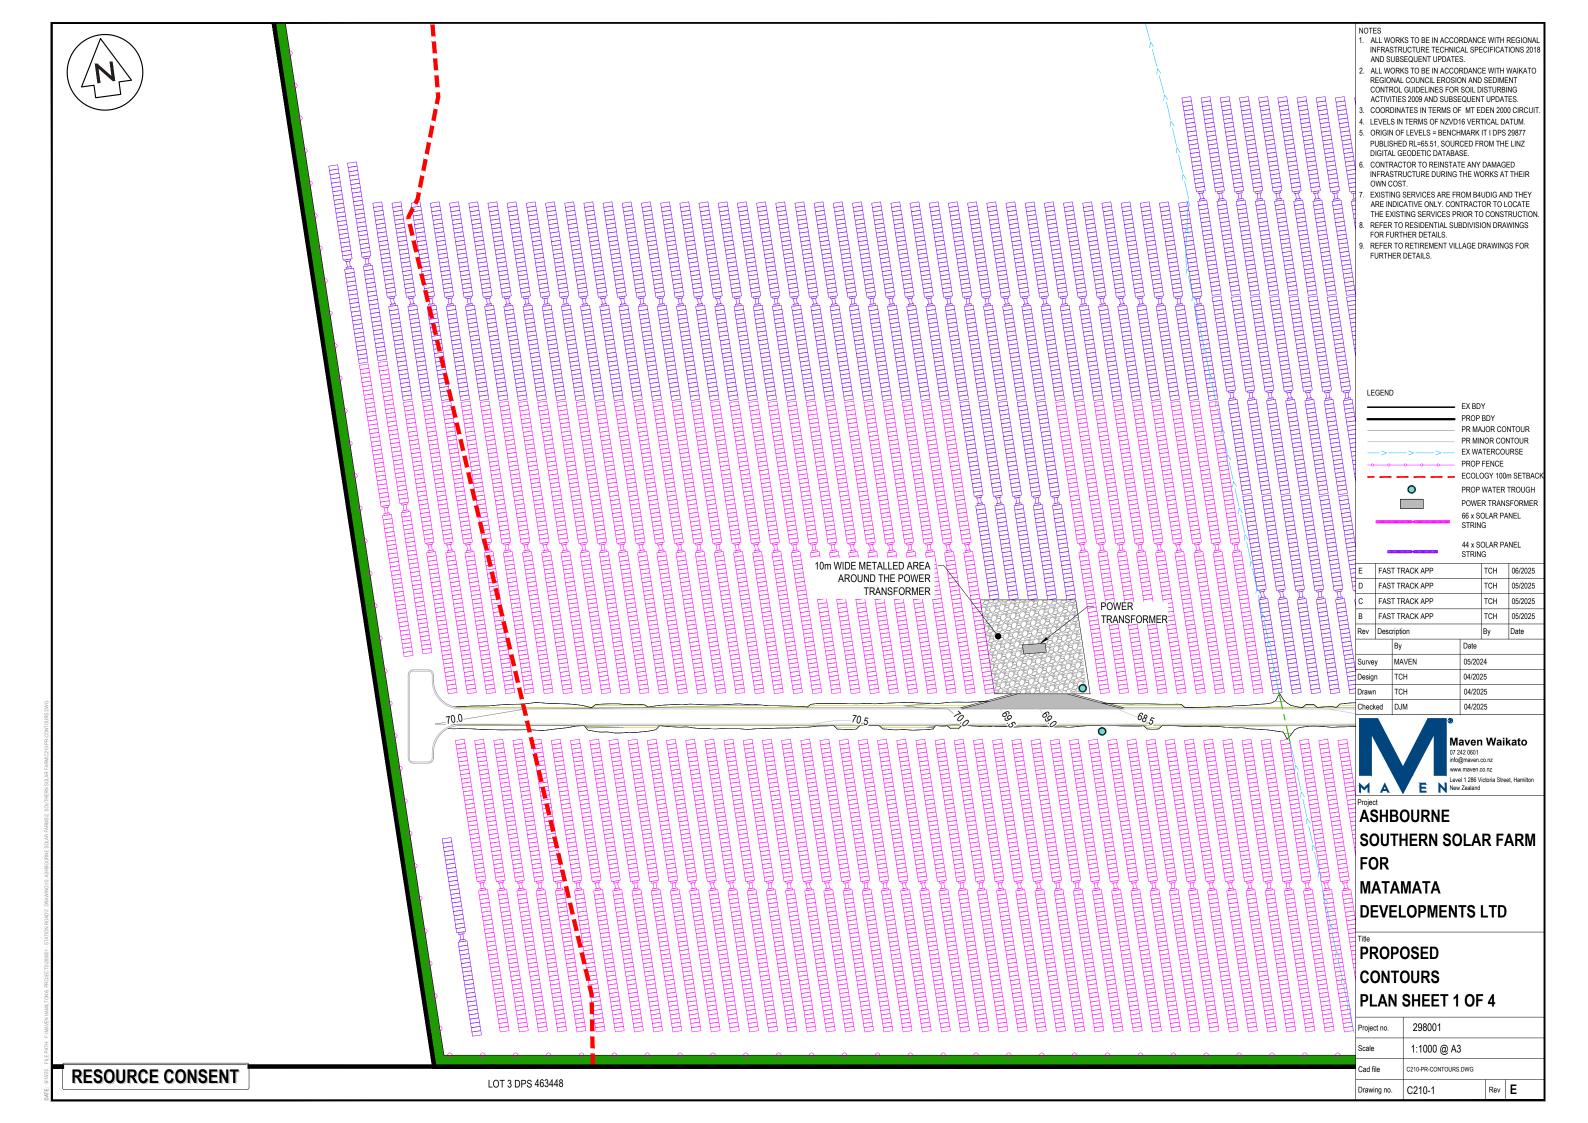


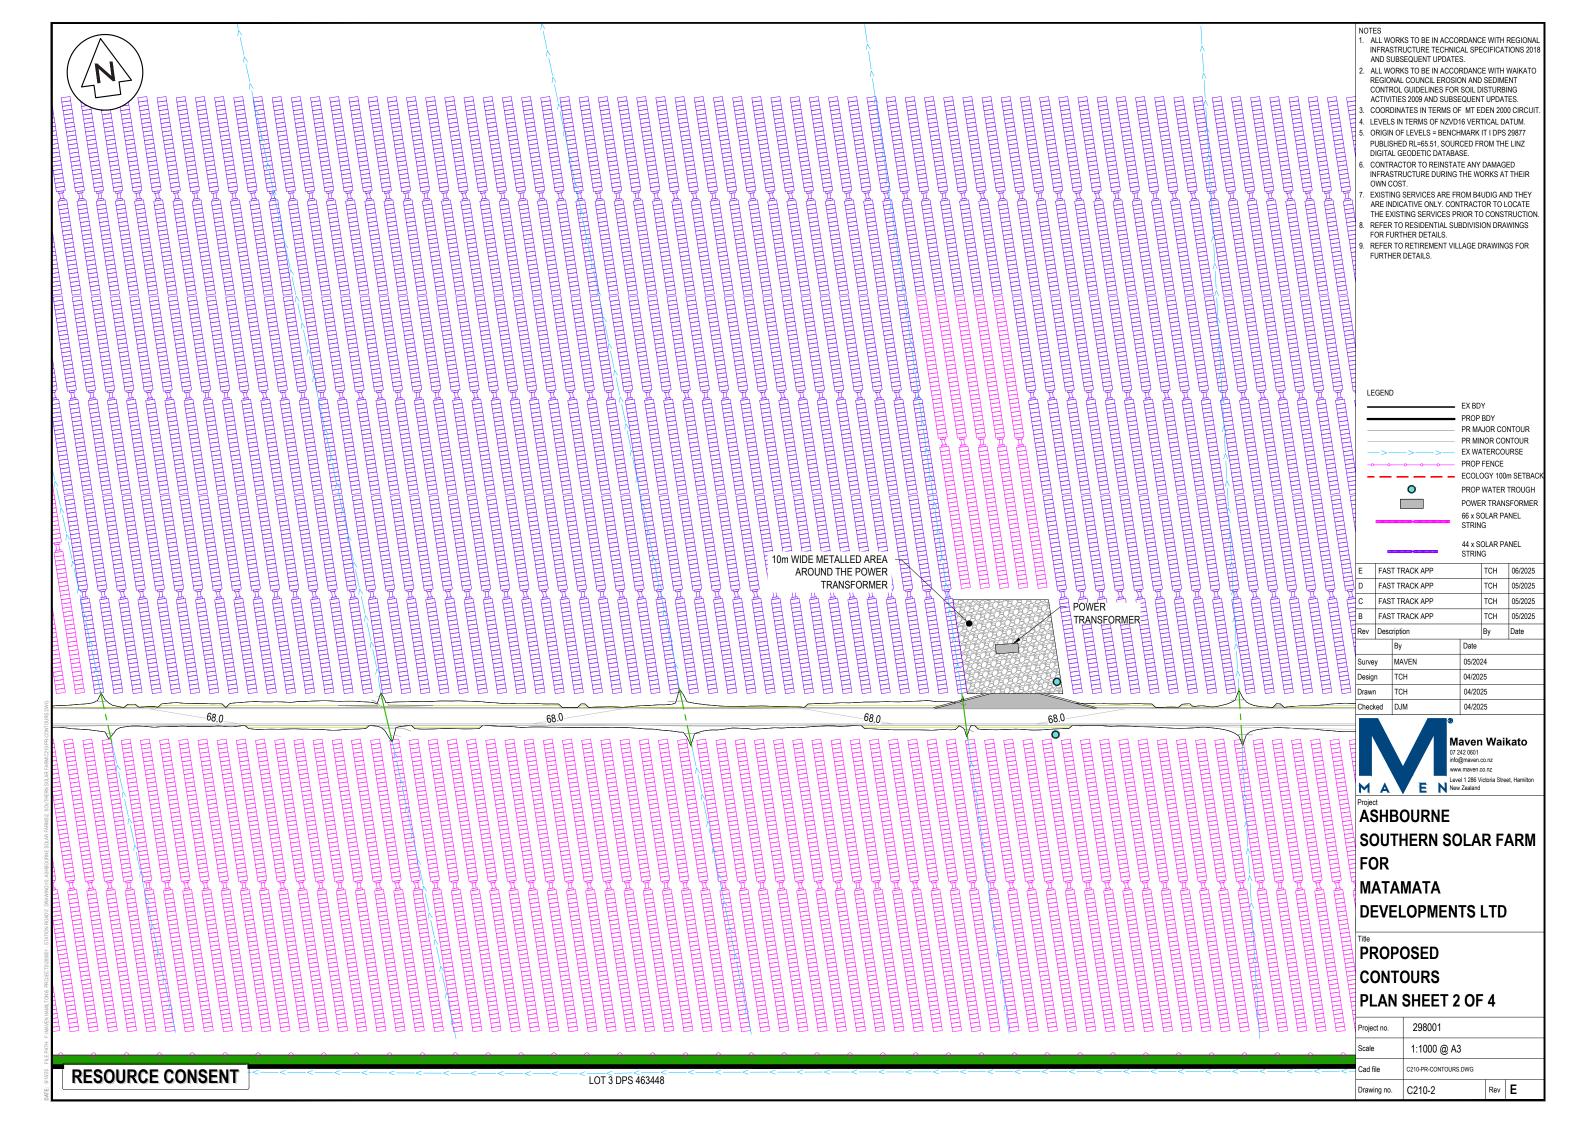








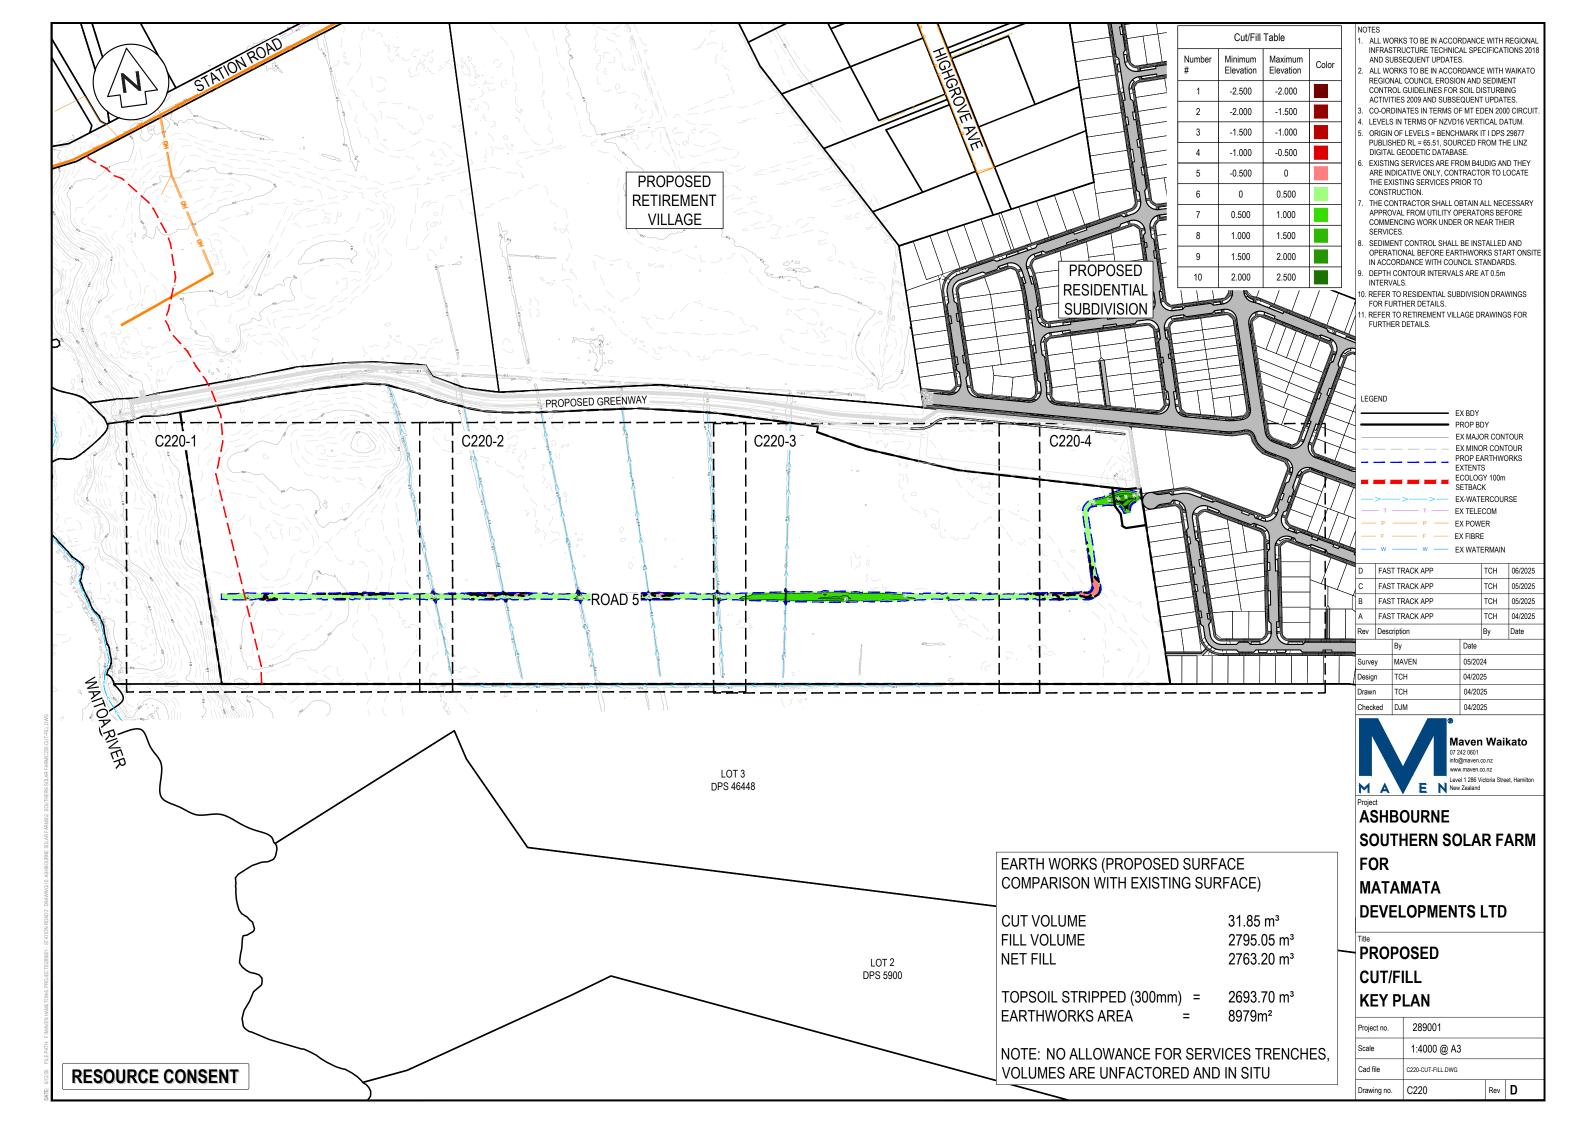


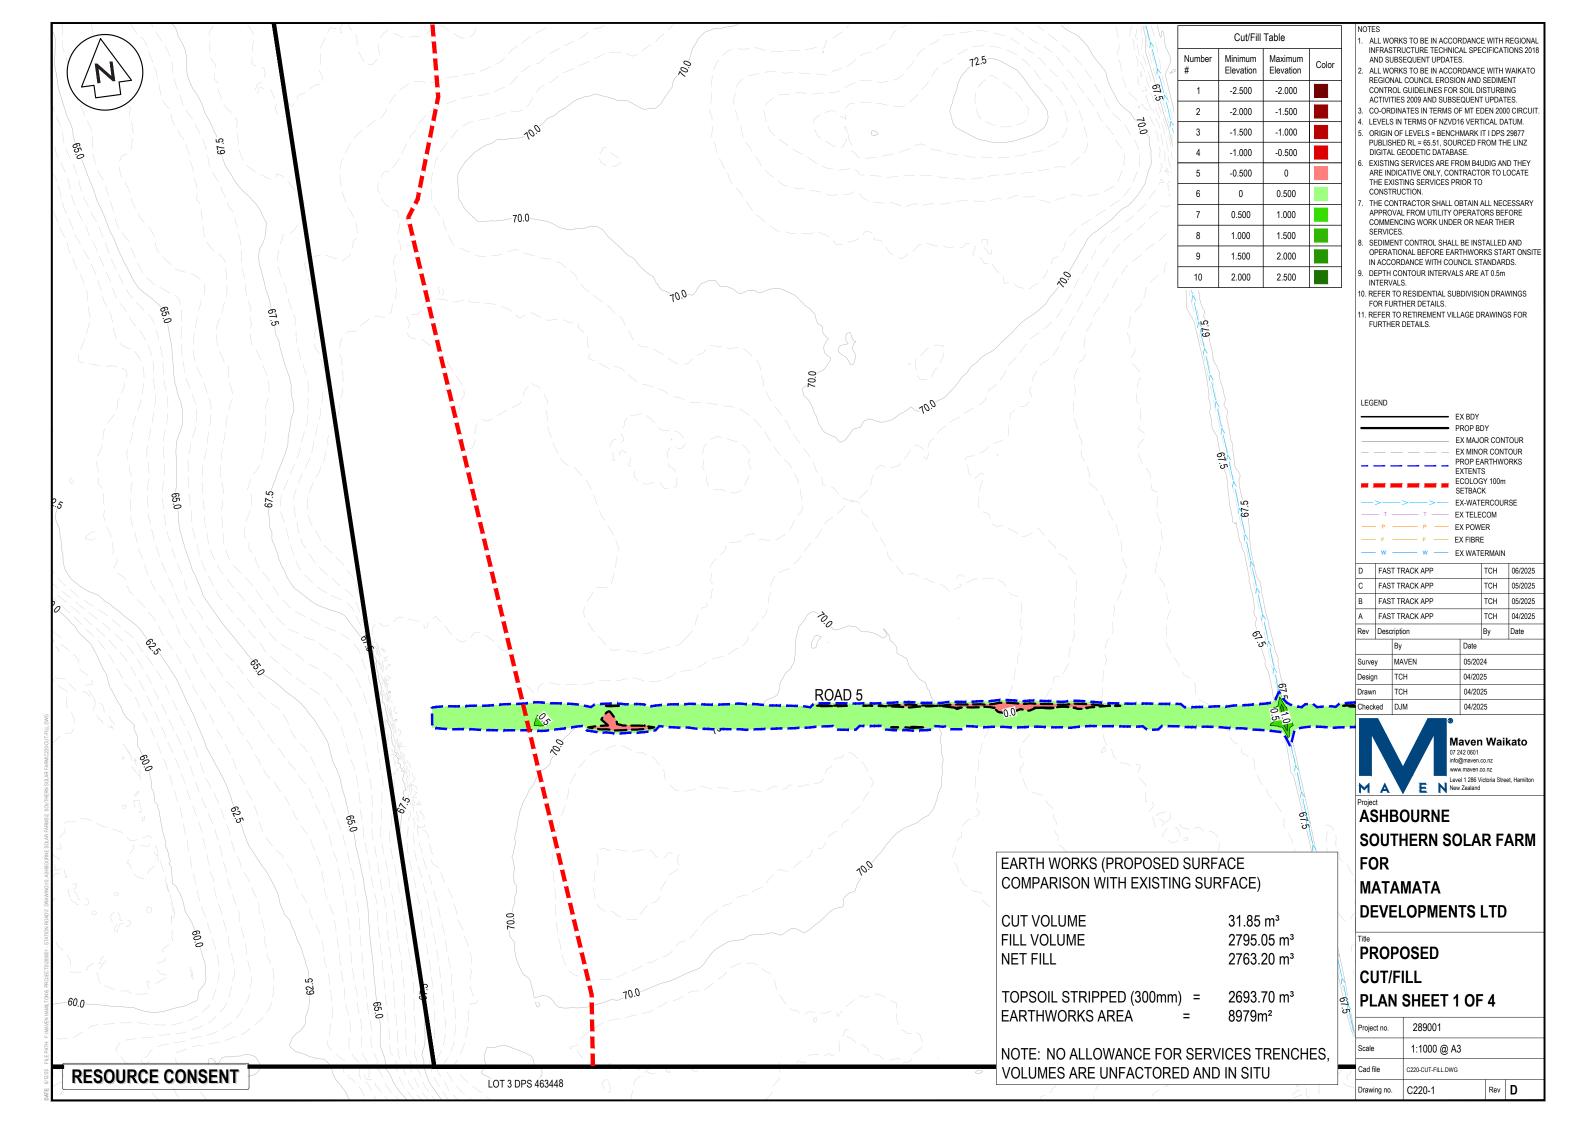


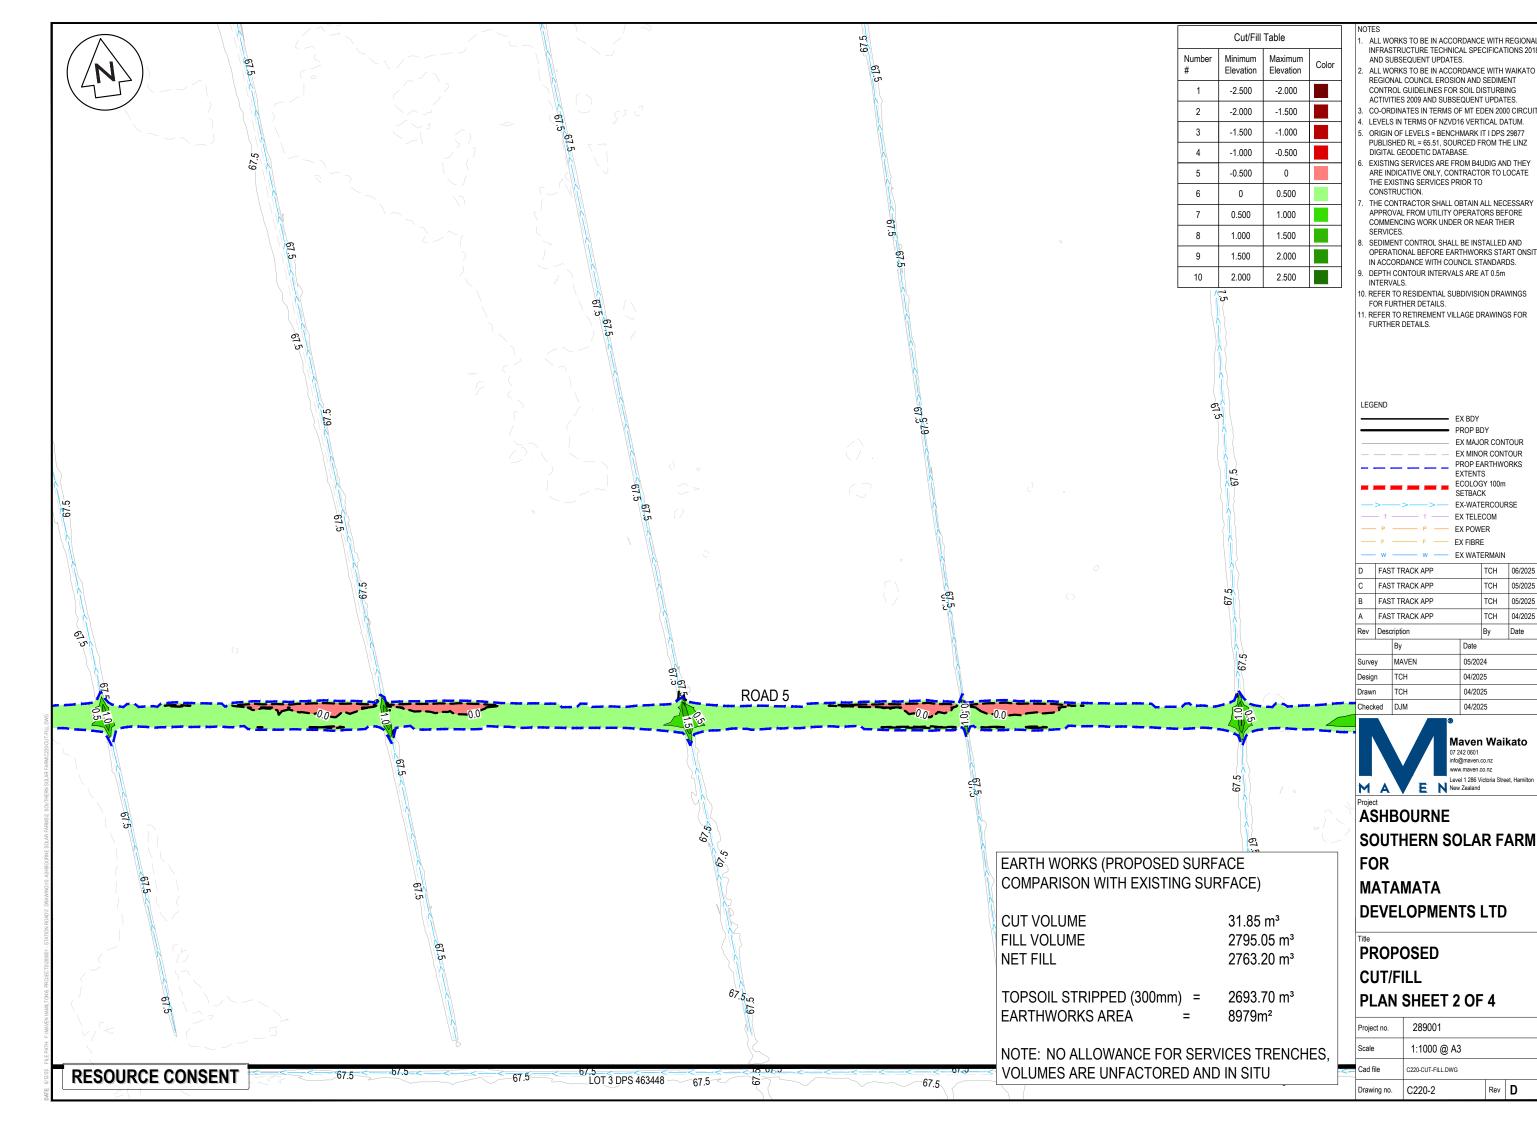


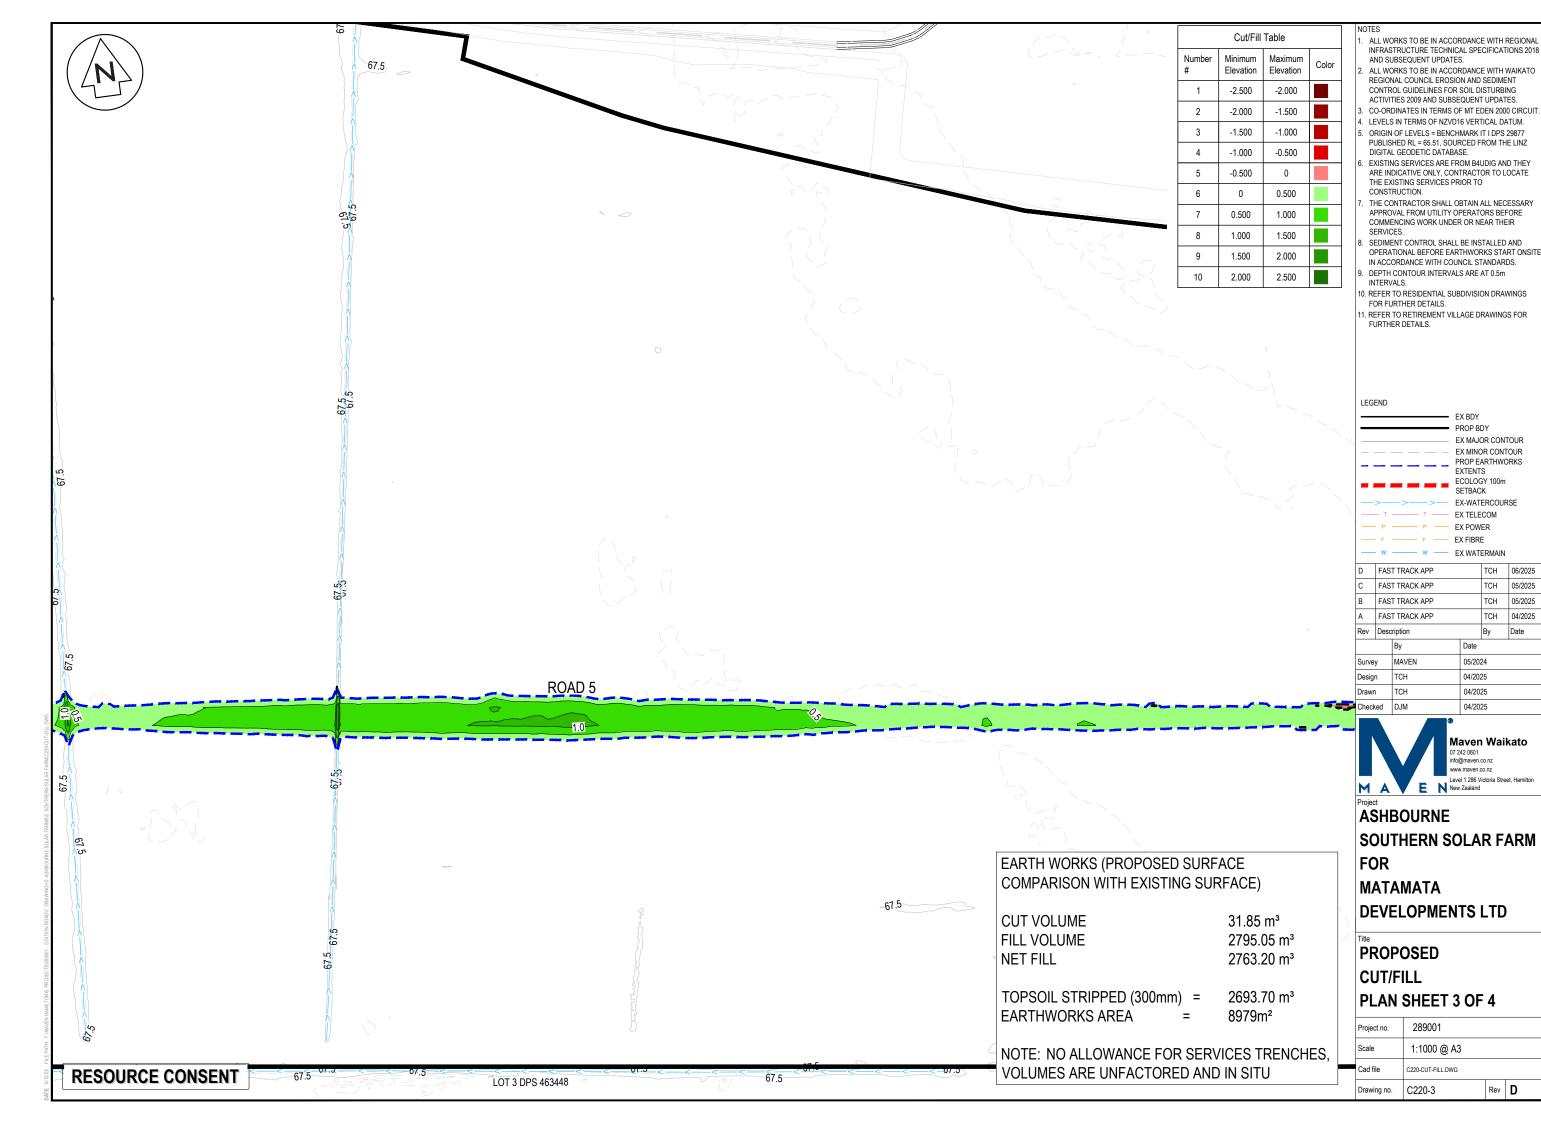

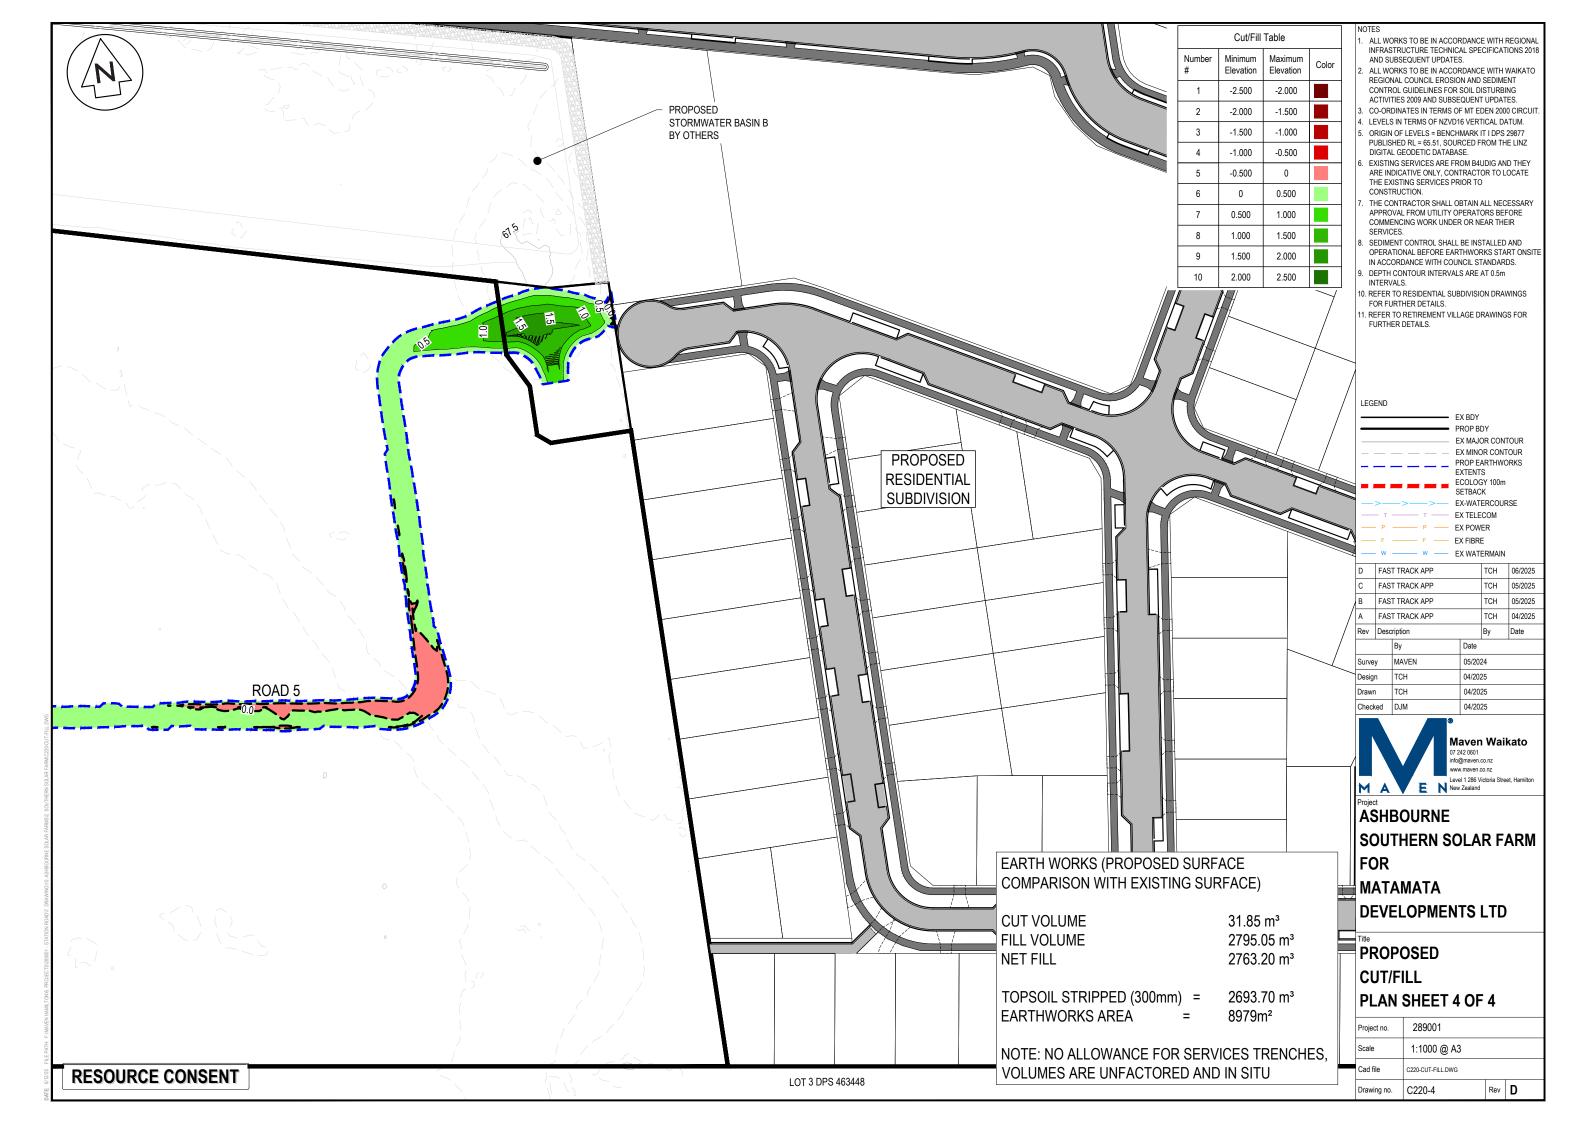


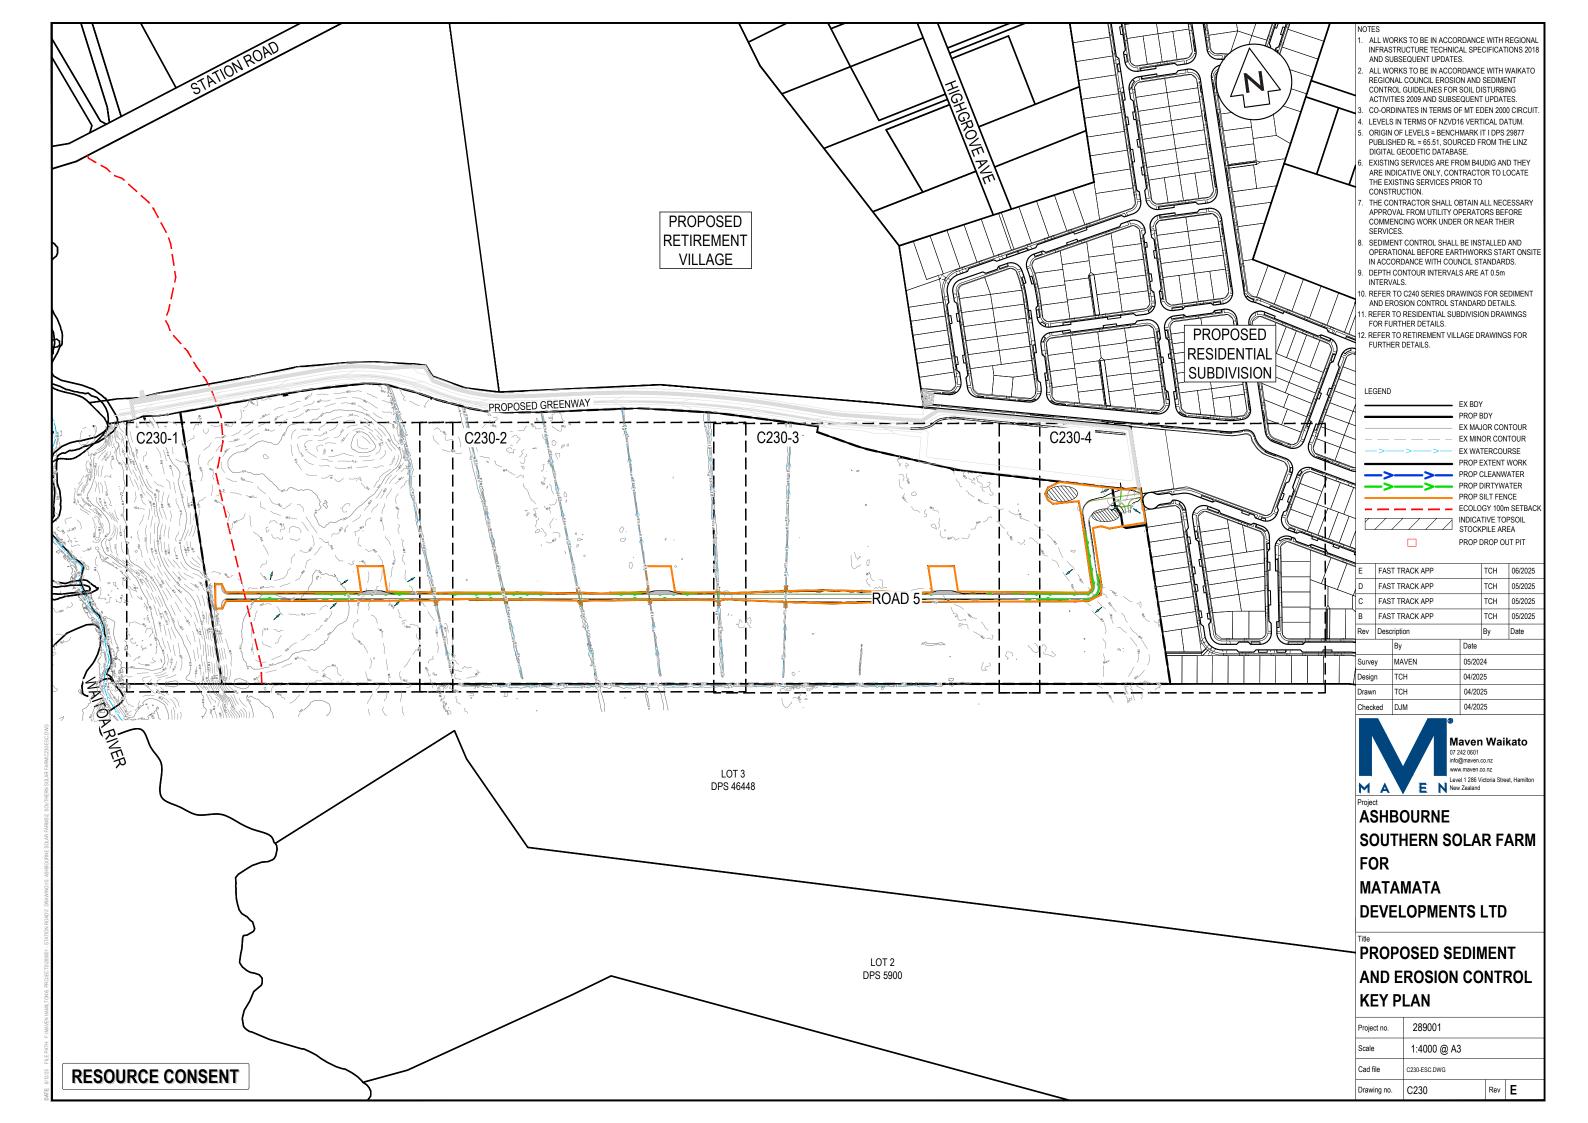


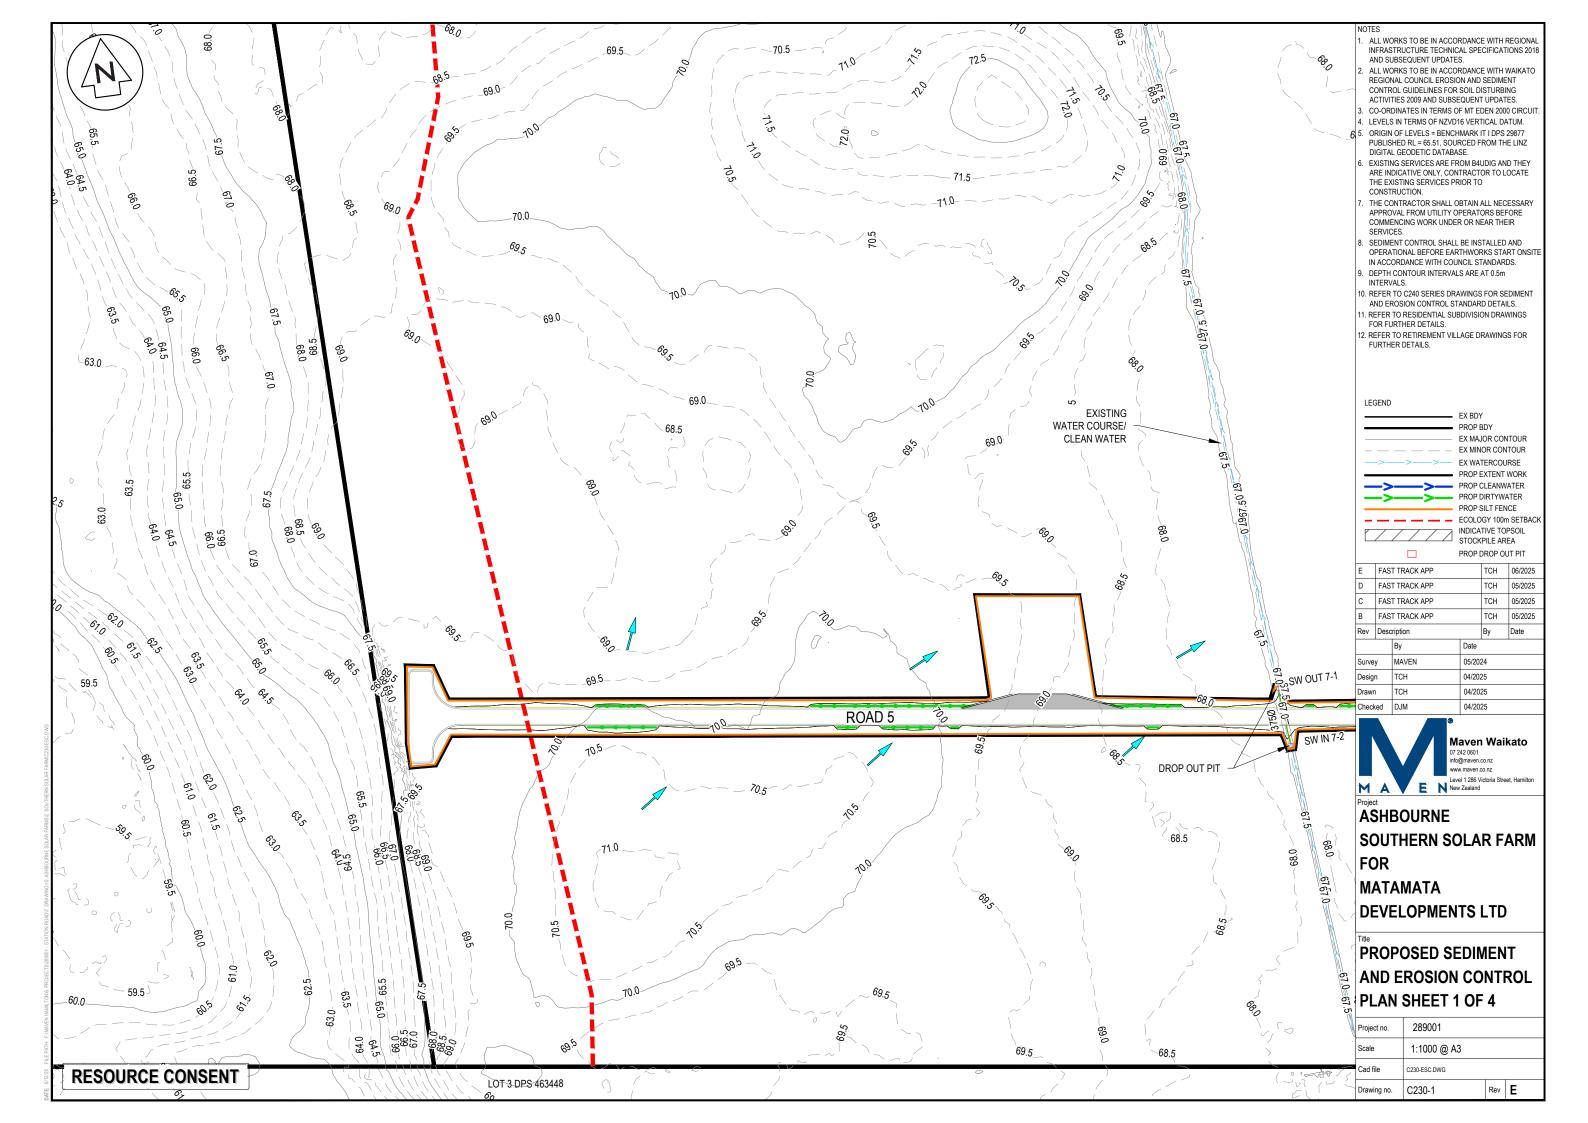

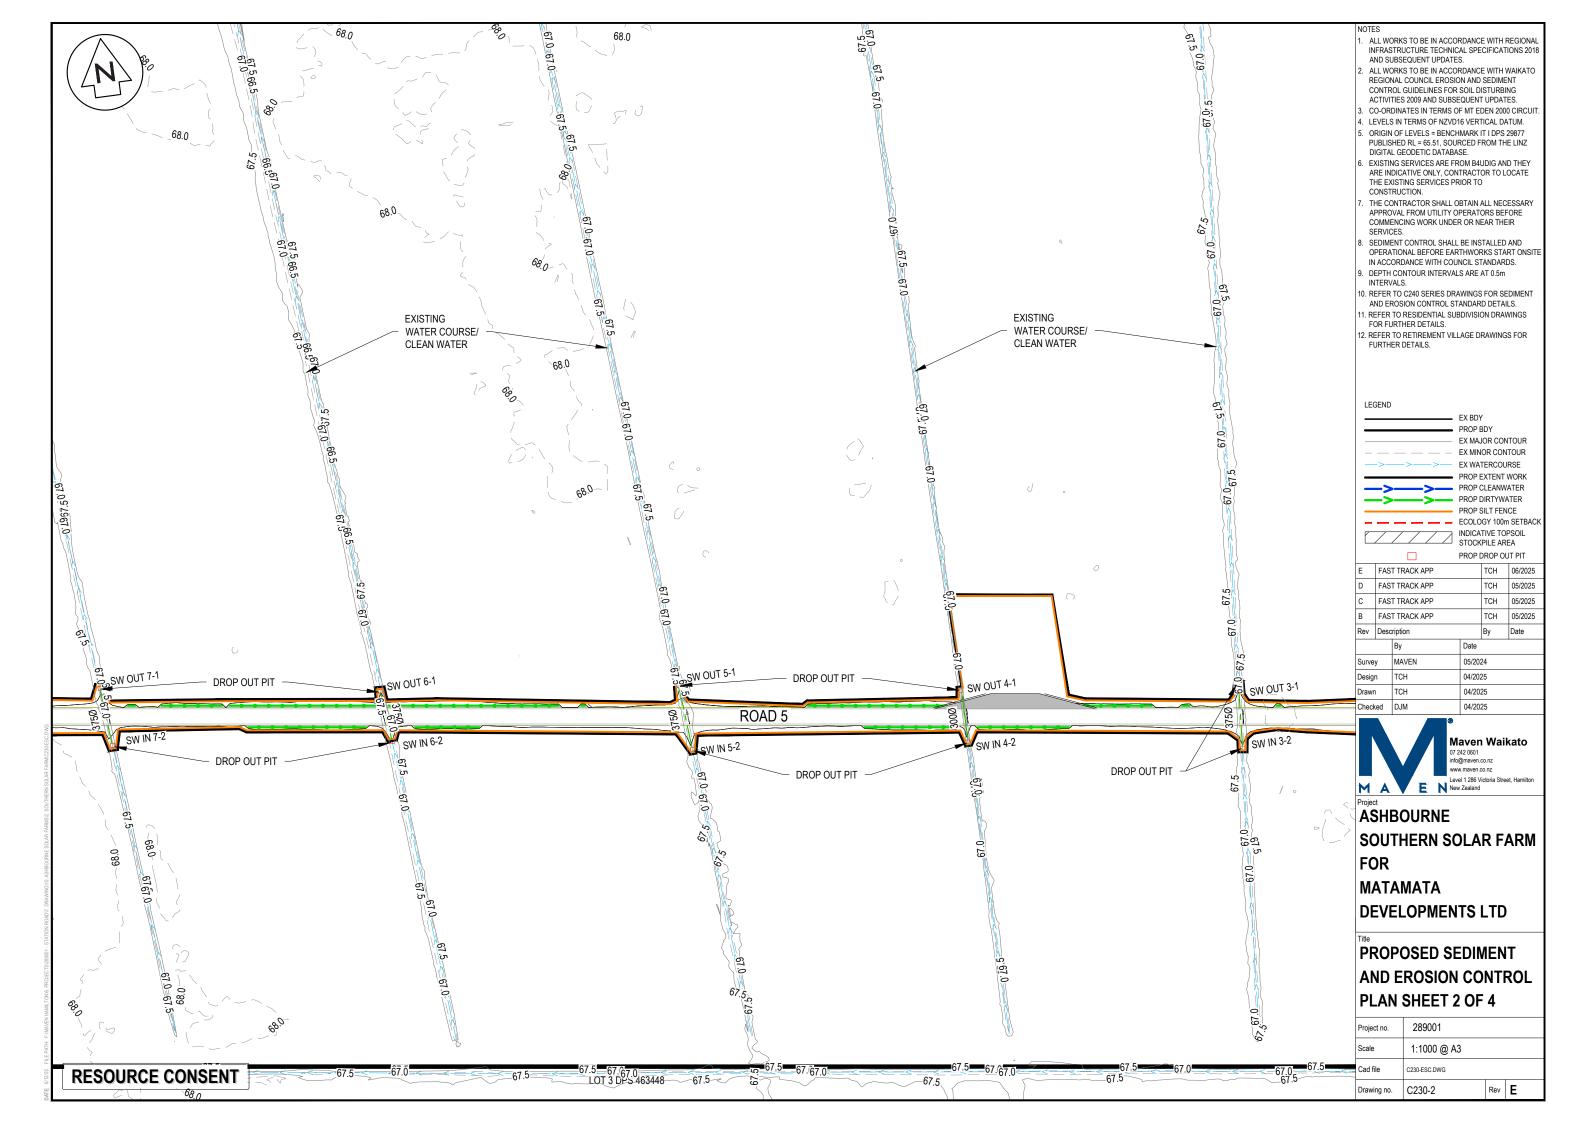




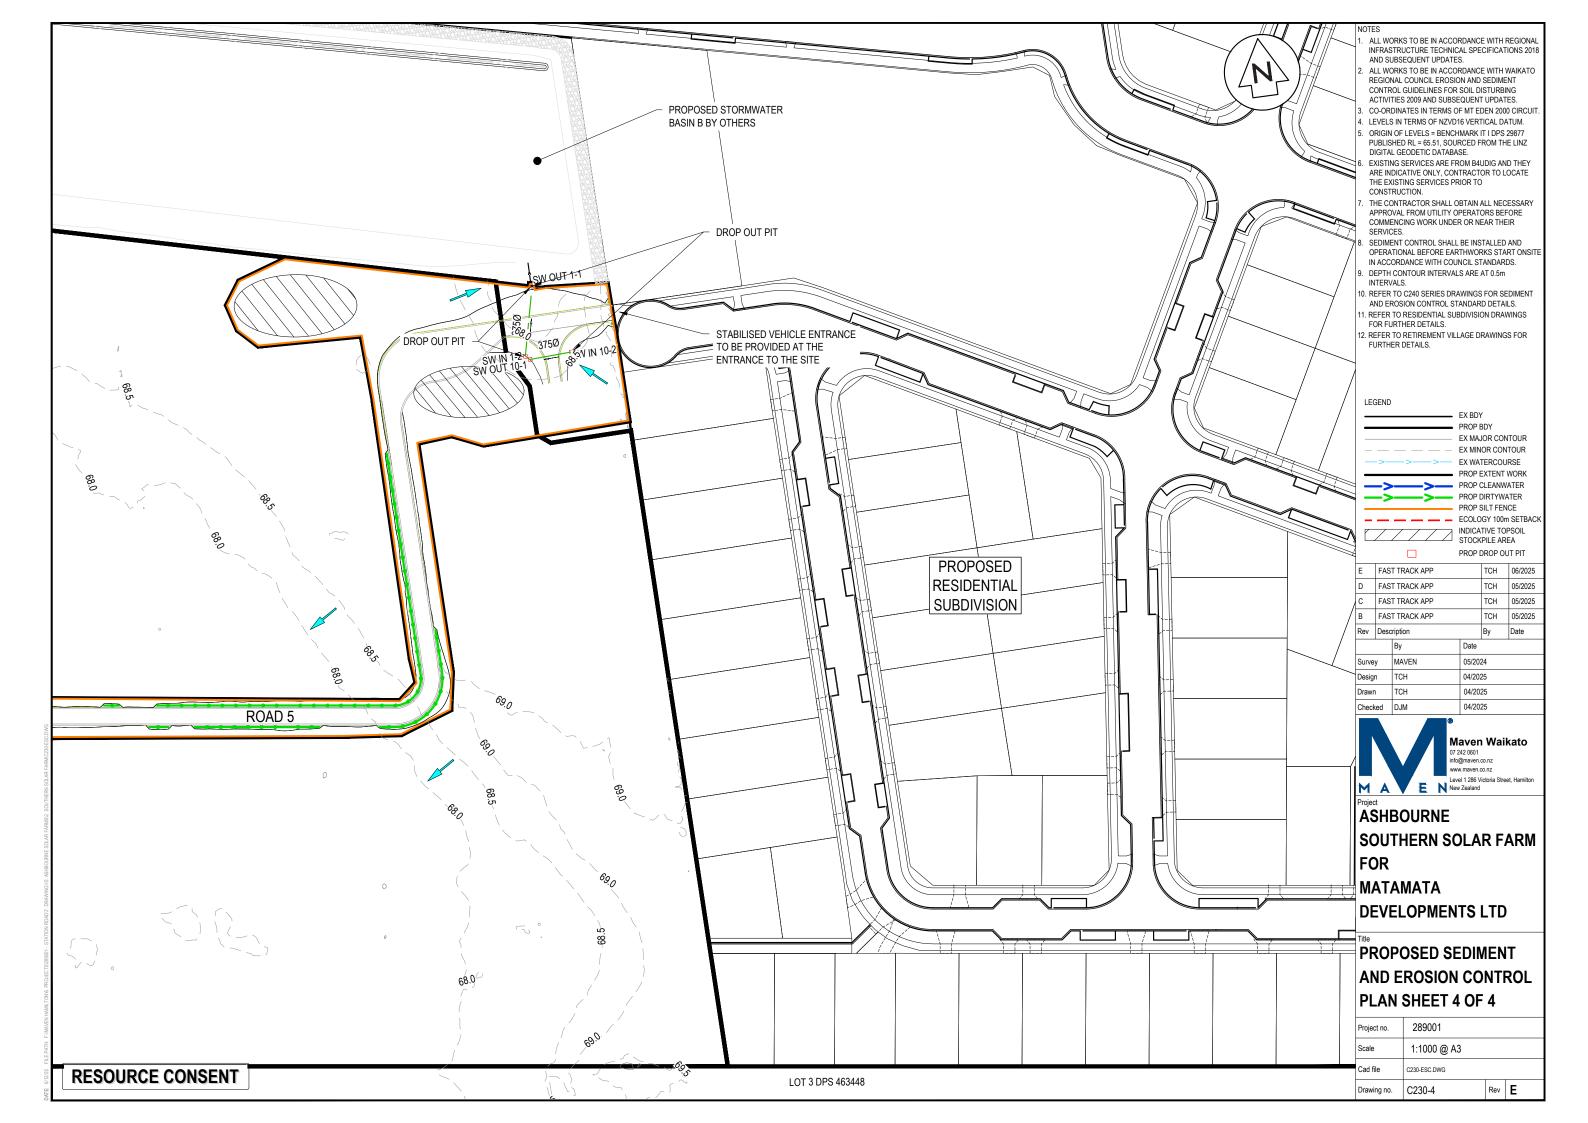


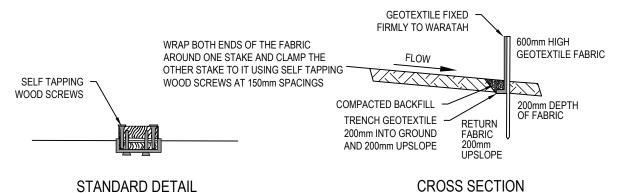

## **FABRIC JOIN**


POST SPACING CAN BE INCREASED FROM 2 METRES TO 4 METRES IF SUPPPORTED BY A 2.5mm DIAMETER HIGH TENSILE WIRE ALONG THE TOP WITH CLIPS EVERY 200mm

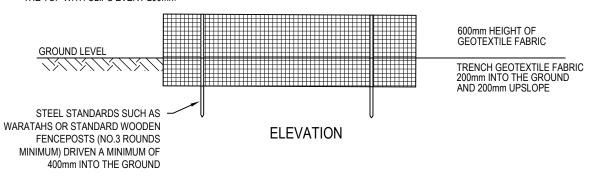

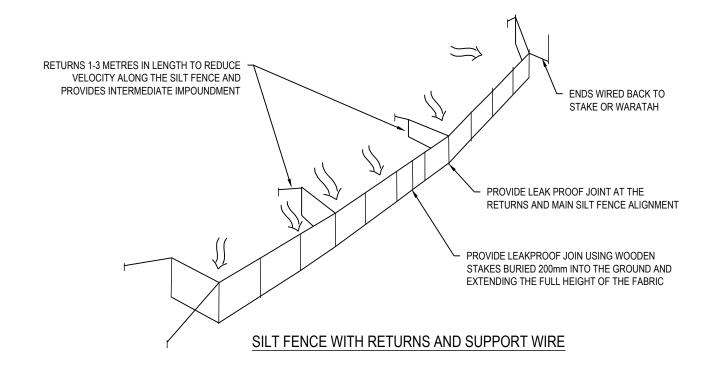

RESOURCE CONSENT

- . ALL WORKS TO BE IN ACCORDANCE WITH REGIONAL INFRASTRUCTURE TECHNICAL SPECIFICATIONS 201 AND SUBSEQUENT UPDATES.
- . ALL WORKS TO BE IN ACCORDANCE WITH WAIKATO REGIONAL COUNCIL EROSION AND SEDIMENT CONTROL GUIDELINES FOR SOIL DISTURBING ACTIVITIES 2009 AND SUBSEQUENT UPDATES.
- 3. COORDINATES IN TERMS OF MT EDEN 2000 CIRCUI
- . LEVELS IN TERMS OF NZVD16 VERTICAL DATUM. . ORIGIN OF LEVELS = BENCHMARK IT I DPS 29877
- PUBLISHED RL=65.51, SOURCED FROM THE LINZ DIGITAL GEODETIC DATABASE.
- REFER TO C230 SERIES DRAWINGS FOR SEDIMENT AND EROSION CONTROL LAYOUT DRAWINGS.

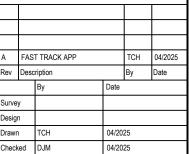





**ASHBOURNE SOUTHERN SOLAR FARM** FOR **MATAMATA DEVELOPMENTS LTD** 


# SEDIMENT EROSION **CONTROL DETAILS** SHEET 1 OF 2

Project no.	289001						
Scale	N.T.S						
Cad file	C240-ESC DET.DWG						
Drawing no.	C240-1	Rev	Α				

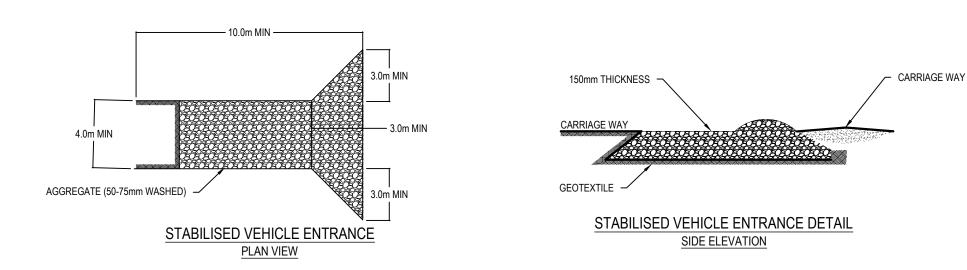

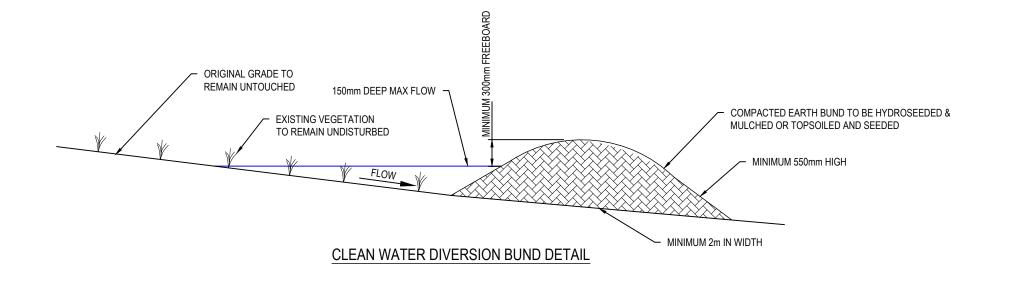

- . ALL WORKS TO BE IN ACCORDANCE WITH REGIONAL INFRASTRUCTURE TECHNICAL SPECIFICATIONS 201
  AND SUBSEQUENT UPDATES.
- 2. ALL WORKS TO BE IN ACCORDANCE WITH WAIKATO REGIONAL COUNCIL EROSION AND SEDIMENT CONTROL GUIDELINES FOR SOIL DISTURBING ACTIVITIES 2009 AND SUBSEQUENT UPDATES.
- 3. COORDINATES IN TERMS OF MT EDEN 2000 CIRCUI . LEVELS IN TERMS OF NZVD16 VERTICAL DATUM.
- i. ORIGIN OF LEVELS = BENCHMARK IT I DPS 29877 PUBLISHED RL=65.51, SOURCED FROM THE LINZ
- DIGITAL GEODETIC DATABASE. REFER TO C230 SERIES DRAWINGS FOR SEDIMENT AND EROSION CONTROL LAYOUT DRAWINGS.

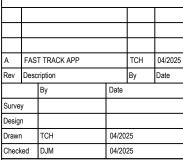



ASHBOURNE

**SOUTHERN SOLAR FARM** FOR

MATAMATA


**DEVELOPMENTS LTD** 


SEDIMENT EROSION **CONTROL DETAILS** SHEET 2 OF 2

Project no.	289001					
Scale	N.T.S					
Cad file	C240-ESC DET.DWG					
Drawing no.	C240-2	Rev A				

RESOURCE CONSENT



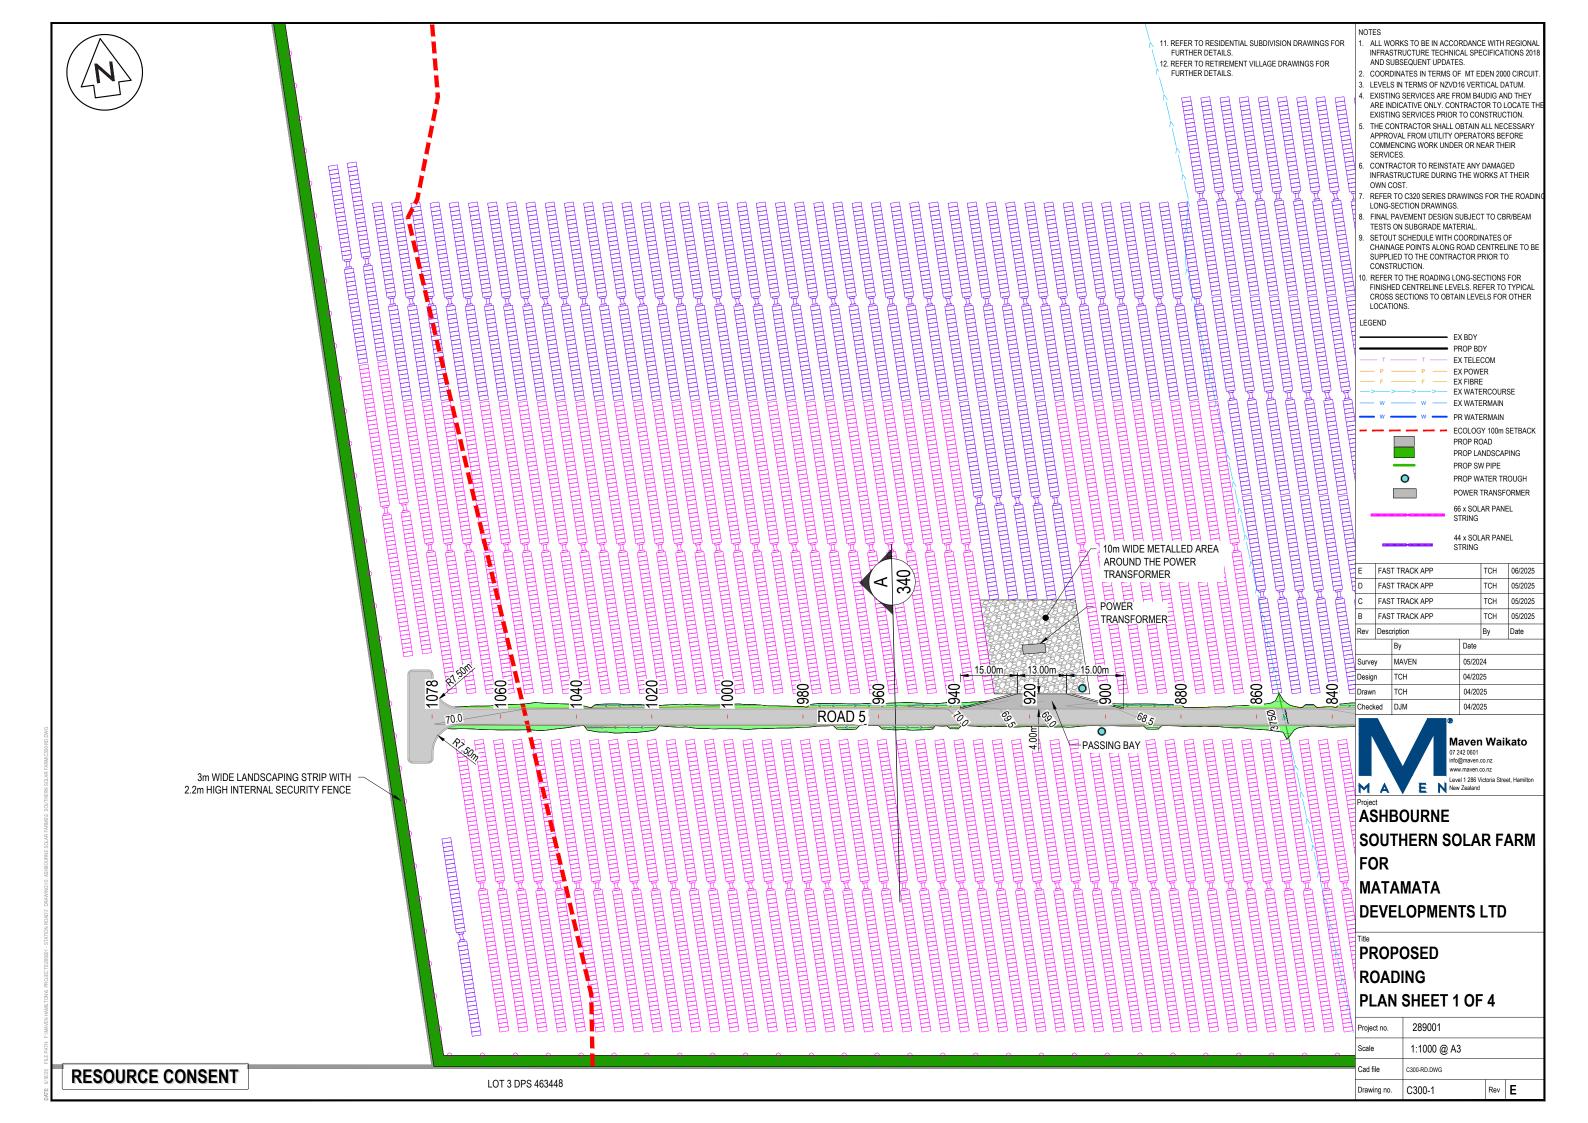

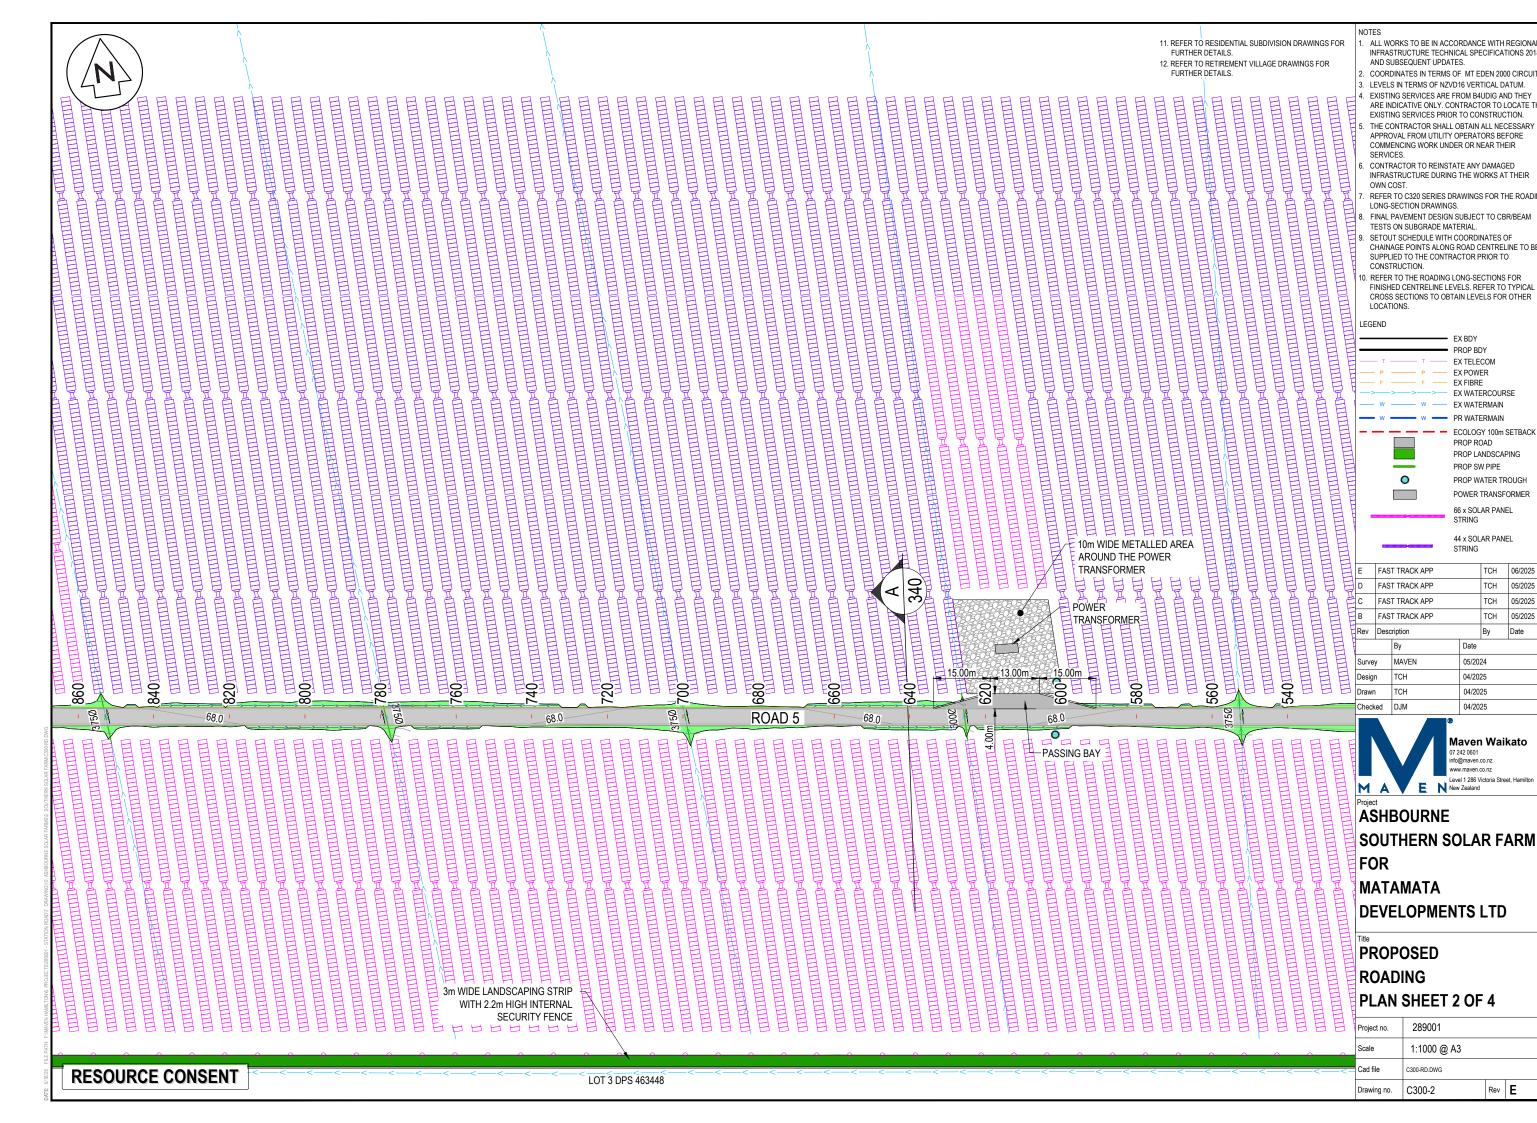



05/2025

05/2025

05/2025

Rev **E** 

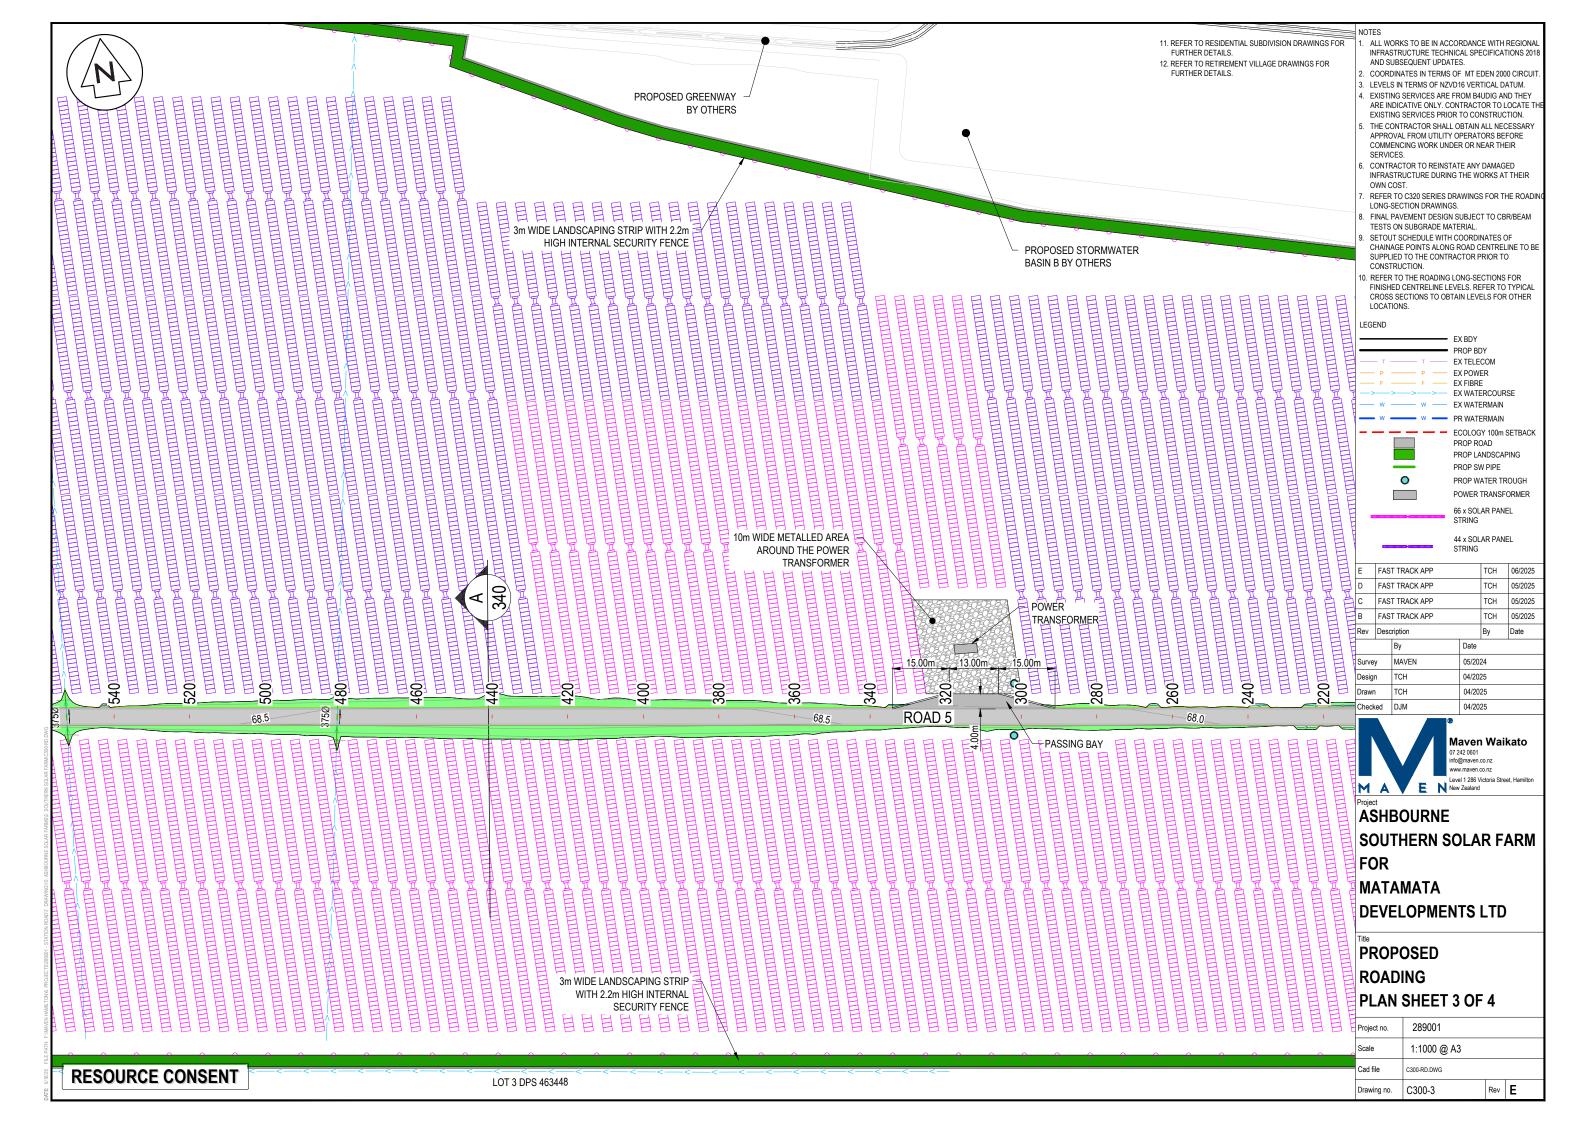

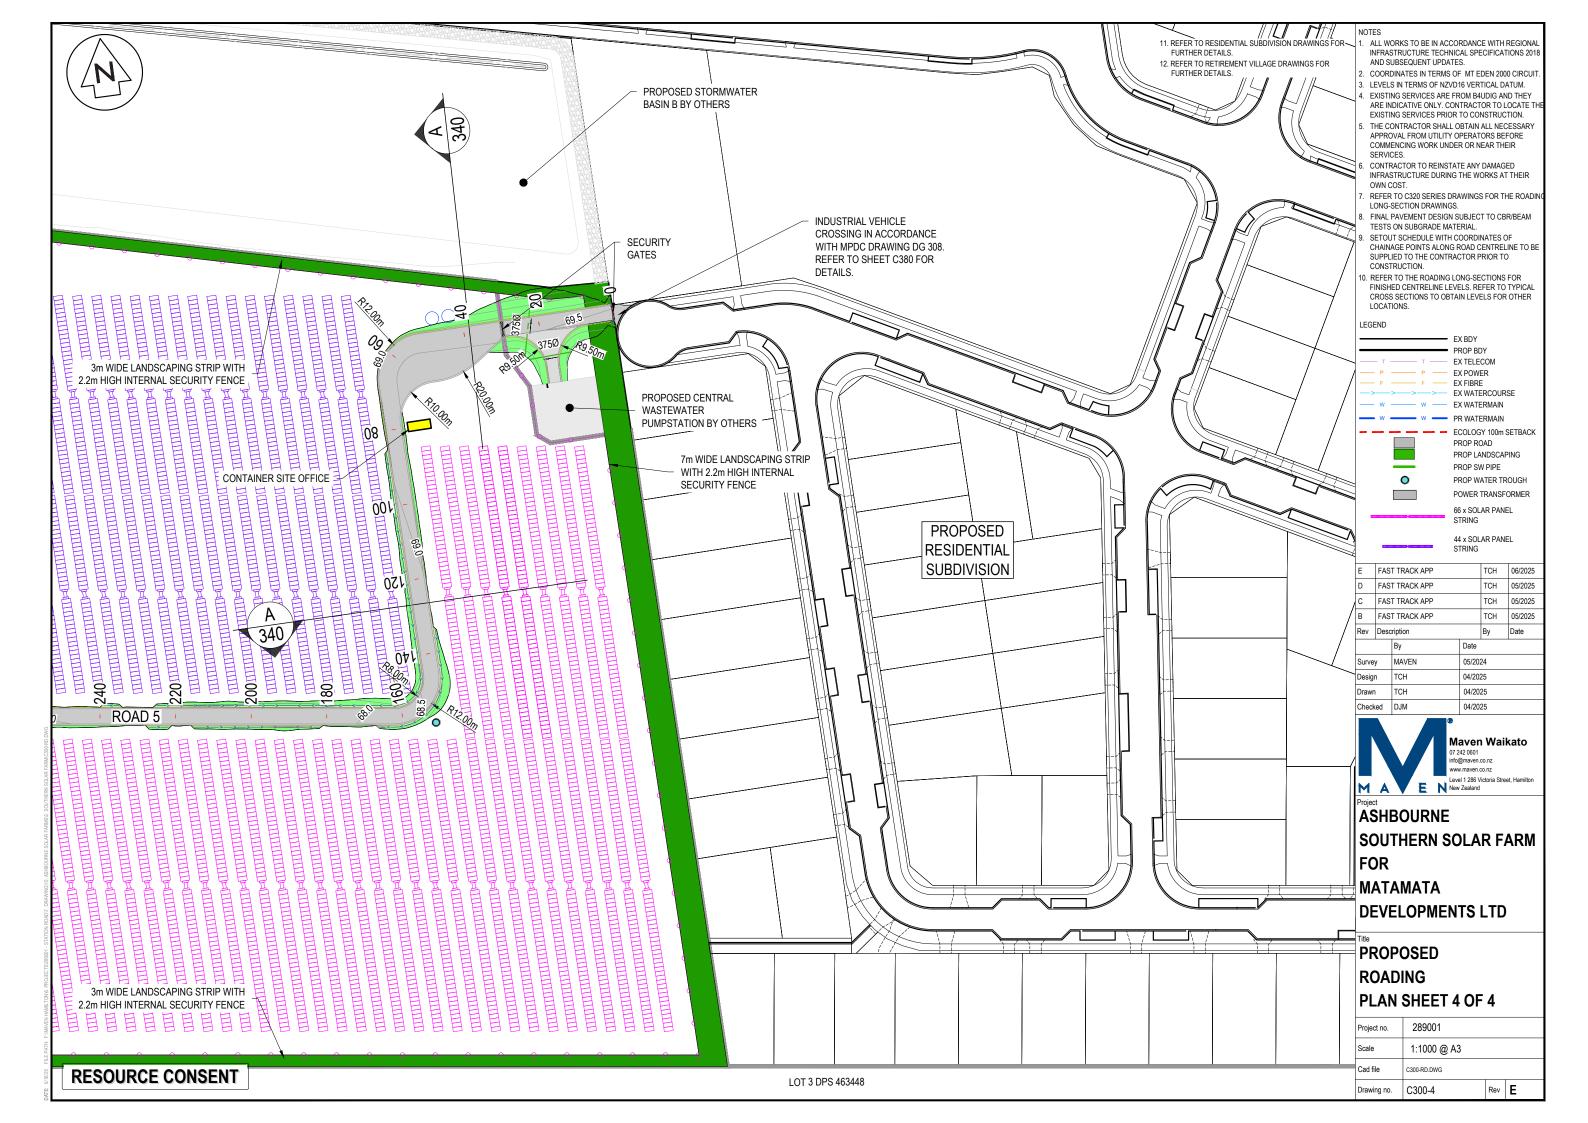

	4	A							
	H GH				<u>-</u>		<u> </u>		
DATUM RL = 65.0							<u> </u>		
HORIZONTAL GEOMETRY					R=- <sup>-</sup>	0.00 5.76	-		
VERTICAL GEOMETRY					-0.	5%			
EXISTING LEVELS	92.69	67.82	68.64	68.80	68.94	68.92	68.86	68.81	98.86
DESIGN LEVELS	69.53	69.43	69.33	69.27	69.23	69.19	69.13	69.03	68.93
CUT/FILL	-0.22	1.61	69:0	0.47	0.29	0.27	0.27	0.23	0.07
CHAINAGE	0.00	20.00	40.00	52.20	60.00	67.95	80.00	100.00	120.00

SAG DATUM RL = 65.0 R=10.00 HORIZONTAL GEOMETRY L=17.23 -0.5% -3% 0.5% VC=10m VC=20m VERTICAL GEOMETRY K=4 68.86 **EXISTING LEVELS** 68.90 68.93 68.95 68.94 68.91 68.32 67.82 99.79 67.67 67.75 67.90 68.84 68.83 68.74 67.92 67.67 DESIGN LEVELS 67. CUT/FILL -0.06 -0.02 -0.17 9 220.00 239.50 119.50 137.88 140.00 142.88 160.00 180.00 190.05 192.91 CHAINAGE

> **ROAD 5 LONGITUDINAL SECTION** SCALE HORI 1:500 VERT 1:250

RESOURCE CONSENT

- . ALL WORKS TO BE CONSTRUCTED IN ACCORDANCE WITH REGIONAL INFRASTRUCTURE TECHNICAL SPECIFICATIONS STANDARDS.
- COORDINATES IN TERMS OF NZ GEODETIC DATUM MT EDEN 2000.
- LEVELS IN TERMS OF THE NZVD16 VERTICAL DATUM ROADING LONGITUDINAL SECTIONS ARE BASED ON THE ROAD CENTRE LINE.
- REFER TO ROADING DRAWING C340 DRAWING FOR THE ROADING TYPICAL CROSS SECTION.
   REFER TO C300 SERIES DRAWINGS FOR THE

Legend	
	EXISTING GROUND LEVEL
	PROPOSED GROUND LEVEL


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R	ev	Desc	ription		Ву	Date	
			Ву	Date	Date		
S	urve	/	MAVEN	05/2024			
D	Design TCH		TCH	04/2025			
D	Drawn		TCH	04/2025			
С	heck	ed	DJM	04/20	25	·	



ASHBOURNE SOUTHERN SOLAR FARM FOR MATAMATA **DEVELOPMENTS** 

Project no.	289001				
Scale	AS SHOWN				
Cad file	C320-RD LS.DWG				
Drawing no.	C320-1	Rev	Α		

	F							
DATUM RL = 65.0								
HORIZONTAL GEOMETRY								
VERTICAL GEOMETRY					0.5%			
EXISTING LEVELS	67.71	67.71	67.73	67.70	67.79	68.14	68.07	67.89
DESIGN LEVELS	06.79	06'.29	00.89	68.10	68.20	68.30	68.40	68.50
CUT/FILL	0.19	0.19	0.27	0.41	0.41	0.16	0.33	0.61
CHAINAGE	239.00	240.00	260.00	280.00	300.00	320.00	340.00	359.00

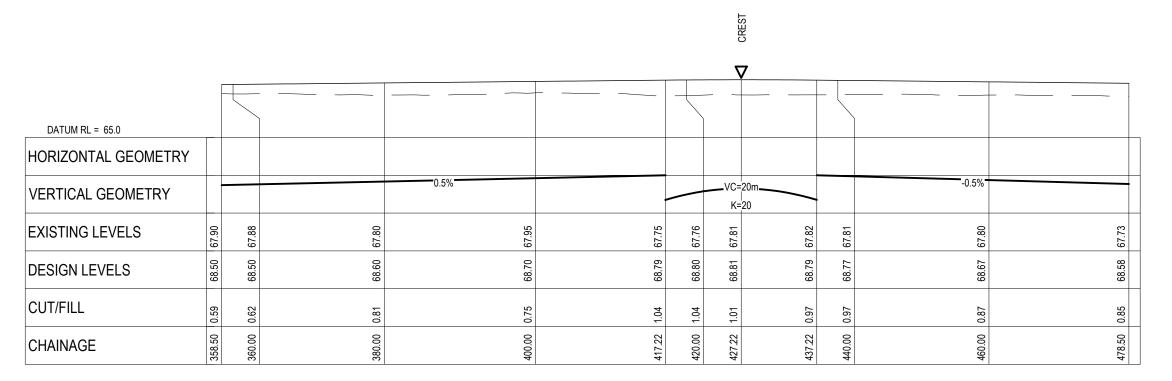

**ROAD 5 LONGITUDINAL SECTION** SCALE HORI 1:500 VERT 1:250

RESOURCE CONSENT

- . ALL WORKS TO BE CONSTRUCTED IN ACCORDANCE WITH REGIONAL INFRASTRUCTURE TECHNICAL SPECIFICATIONS STANDARDS.
- . COORDINATES IN TERMS OF NZ GEODETIC DATUM MT EDEN 2000.
- LEVELS IN TERMS OF THE NZVD16 VERTICAL DATUM ROADING LONGITUDINAL SECTIONS ARE BASED ON THE ROAD CENTRE LINE.
- REFER TO ROADING DRAWING C340 DRAWING FOR THE ROADING TYPICAL CROSS SECTION.
   REFER TO C300 SERIES DRAWINGS FOR THE

Legend	
	EXISTING GROUND LEVEL
	PROPOSED GROUND LEVEL


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Desc	ription	Ву	Date		
	Ву	Date			
y	MAVEN	05/20	05/2024		
1	TCH	04/2025			
1	TCH	04/2025			
ed	DJM	04/20	25		
	Desc	MAVEN TCH TCH	Description   Date	Description   By   Date	



ASHBOURNE SOUTHERN SOLAR FARM FOR MATAMATA **DEVELOPMENTS** 

Project no.	289001						
Scale	Scale AS SHOWN						
Cad file	C320-RD LS.DWG						
Drawing no.	C320-2	Rev	Α				

	Г								
DATUM DI CA O									
DATUM RL = 64.0									
HORIZONTAL GEOMETRY									
VERTICAL GEOMETRY	-				-0.5%				
VEITHORE GEOMETICE									
EXISTING LEVELS	67.72	69.79	67.82	67.85	68.06	67.94	067.90	67.90	
DESIGN LEVELS	68.58	68.57	68.47	68.37	68.27	68.17	68.07	86.79	
CUT/FILL	98.0	0.88	0.65	0.52	0.21	0.23		60.0	
CHAINAGE	478.00	480.00	500.00	520.00	540.00	560.00	580.00	598.00	

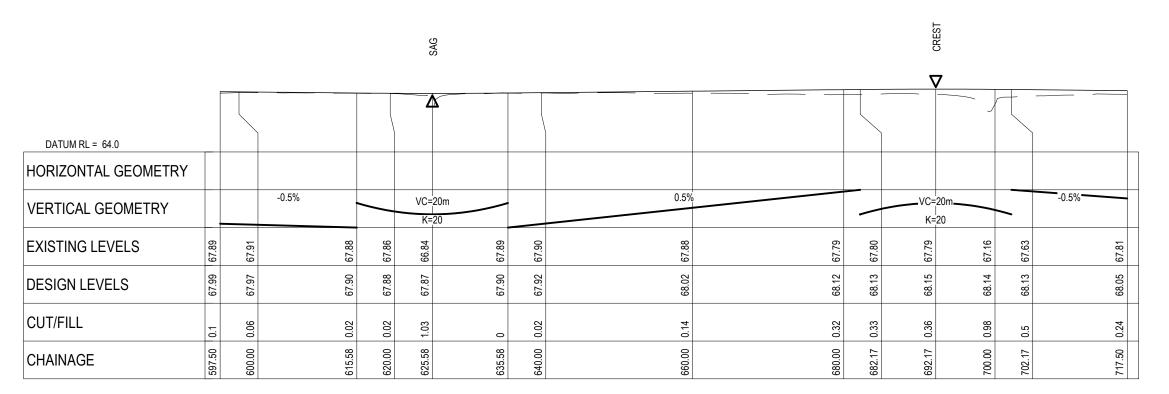

**ROAD 5 LONGITUDINAL SECTION** SCALE HORI 1:500 VERT 1:250

RESOURCE CONSENT

- . ALL WORKS TO BE CONSTRUCTED IN ACCORDANCE WITH REGIONAL INFRASTRUCTURE TECHNICAL SPECIFICATIONS STANDARDS.
- COORDINATES IN TERMS OF NZ GEODETIC DATUM MT EDEN 2000.
- LEVELS IN TERMS OF THE NZVD16 VERTICAL DATUM ROADING LONGITUDINAL SECTIONS ARE BASED ON THE ROAD CENTRE LINE.
- REFER TO ROADING DRAWING C340 DRAWING FOR THE ROADING TYPICAL CROSS SECTION.
   REFER TO C300 SERIES DRAWINGS FOR THE

Legend	
	EXISTING GROUND LEVEL
	PROPOSED GROUND LEVEL


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Rev	Desc	ription	otion		Ву	Date	
		Ву		Date			
Surve	у	MAVEN		05/2024			
Desig	ın	TCH		04/2025			
Draw	n	TCH		04/2025		04/2025	
Chec	ked	DJM		04/2025			
_							



ASHBOURNE **SOUTHERN SOLAR FARM** FOR MATAMATA **DEVELOPMENTS** 

Project no.	289001		
Scale	AS SHOWN		
Cad file	C320-RD LS.DWG		
Drawing no.	C320-3	Rev	Α

AG

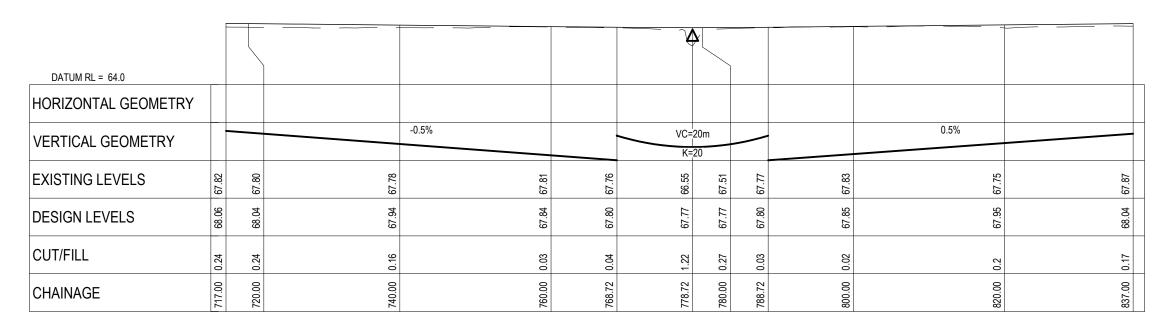

ROAD 5 LONGITUDINAL SECTION SCALE HORI 1:500 VERT 1:250



ROAD 5 LONGITUDINAL SECTION SCALE HORI 1:500 VERT 1:250

**RESOURCE CONSENT** 

NOTES

- ALL WORKS TO BE CONSTRUCTED IN ACCORDANCE WITH REGIONAL INFRASTRUCTURE TECHNICAL SPECIFICATIONS STANDARDS.
  - SPECIFICATIONS STANDARDS.

    COORDINATES IN TERMS OF NZ GEODETIC DATUM MT EDEN 2000.
- LEVELS IN TERMS OF THE NZVD16 VERTICAL DATUM
   ROADING LONGITUDINAL SECTIONS ARE BASED ON THE ROAD CENTRE LINE.
- E. REFER TO ROADING DRAWING C340 DRAWING FOR THE ROADING TYPICAL CROSS SECTION.
- 6. REFER TO C300 SERIES DRAWINGS FOR THE ROADING LAYOUT DRAWINGS.


Legend	
	EXISTING GROUND LEVEL
	PROPOSED GROUND LEVEL


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Rev	Desc	ription		Ву	Date
		Ву	Date		
Surve	y	MAVEN	05/20	24	
Desig	1	TCH	04/20	25	
Drawn	1	TCH	04/20	25	
Check	ed	DJM	04/20	25	



ASHBOURNE
SOUTHERN SOLAR FARM
FOR
MATAMATA
DEVELOPMENTS

Project no.	289001		
Scale	AS SHOWN		
Cad file	C320-RD LS.DWG		
Drawing no.	C320-4	Rev	Α

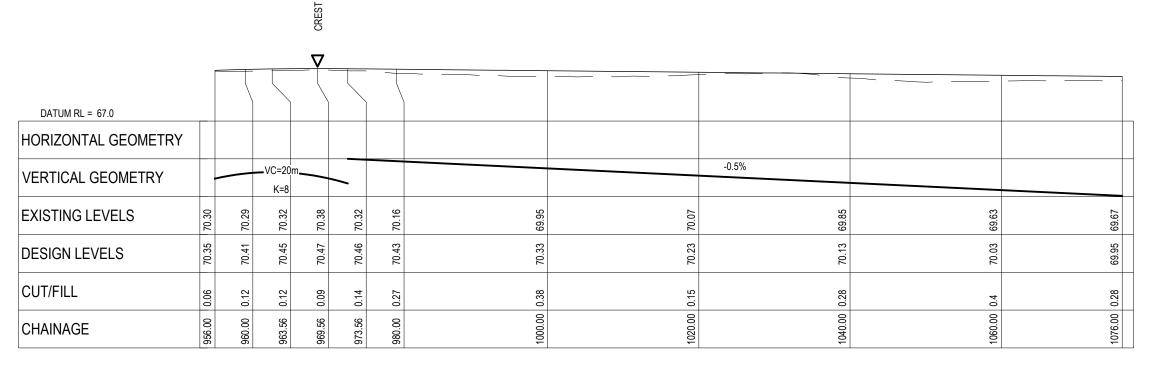

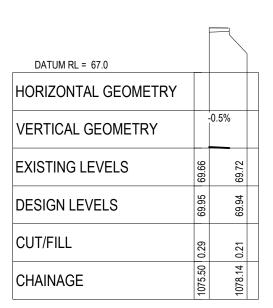

**ROAD 5 LONGITUDINAL SECTION** SCALE HORI 1:500 VERT 1:250

**RESOURCE CONSENT** 

- ALL WORKS TO BE CONSTRUCTED IN ACCORDANCE WITH REGIONAL INFRASTRUCTURE TECHNICAL SPECIFICATIONS STANDARDS.
- COORDINATES IN TERMS OF NZ GEODETIC DATUM MT EDEN 2000.
- LEVELS IN TERMS OF THE NZVD16 VERTICAL DATUM ROADING LONGITUDINAL SECTIONS ARE BASED ON THE ROAD CENTRE LINE.
- REFER TO ROADING DRAWING C340 DRAWING FOR THE ROADING TYPICAL CROSS SECTION.
   REFER TO C300 SERIES DRAWINGS FOR THE


Legend	
	EXISTING GROUND LEVEL
	PROPOSED GROUND LEVEL


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Rev	Desc	ription		Ву	Date
		Ву	Date		
Surve	у	MAVEN	05/20	24	
Desig	ın	TCH	04/20	25	
Draw	n	TCH	04/20	25	
Chec	ked	DJM	04/20	25	·




ASHBOURNE SOUTHERN SOLAR FARM FOR MATAMATA **DEVELOPMENTS** 

Project no.	289001		
Scale	AS SHOWN		
Cad file	C320-RD LS.DWG		
Drawing no.	C320-5	Rev	Α

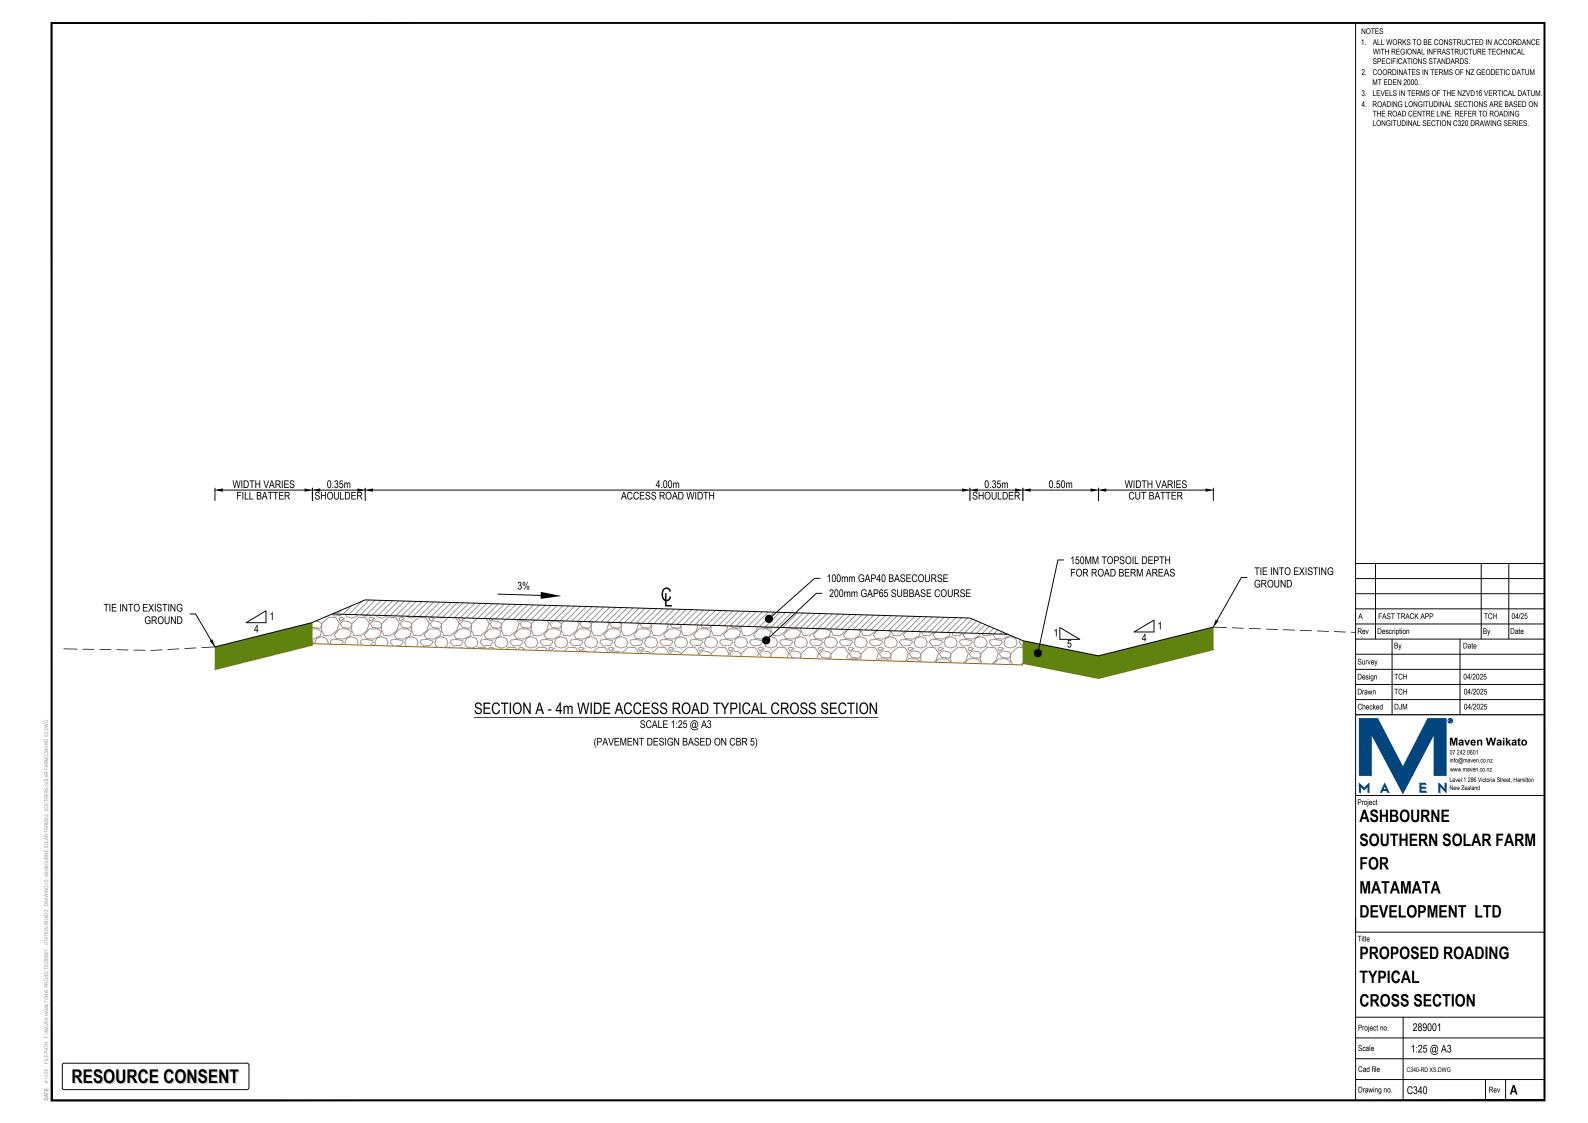

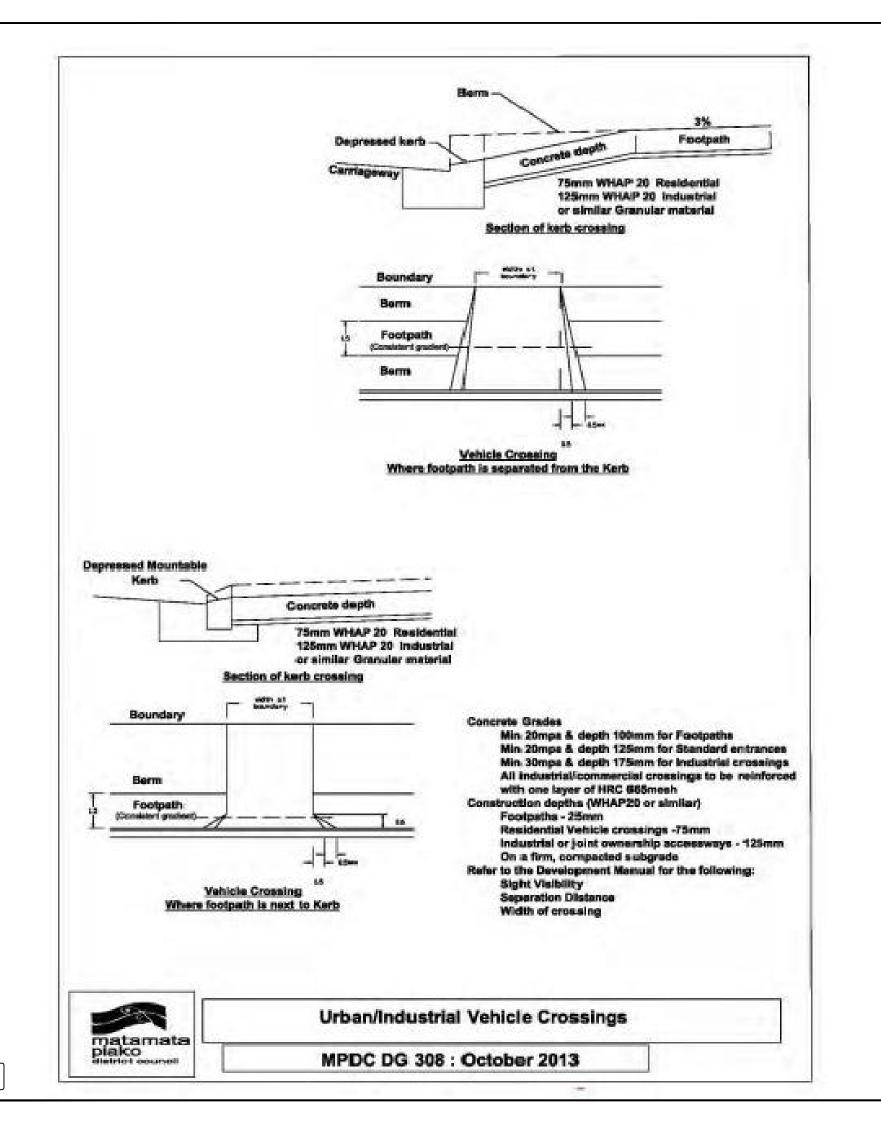

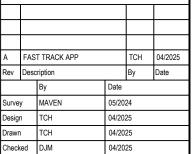



Project
ASHBOURNE
SOUTHERN SOLAR FARM
FOR
MATAMATA
DEVELOPMENT

PROPOSED
ROADING STANDARD
DETAILS

 Project no.
 289001


 Scale
 N.T.S

 Cad file
 c380-RD DET.DWG

 Drawing no.
 C380

 Rev
 A


RESOURCE CONSENT

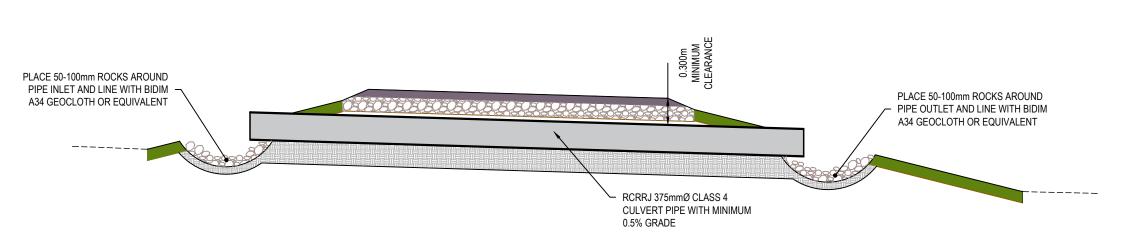

STORMWATER CULVERT TYPICAL DETAIL

NOTES

- ALL WORKS TO BE IN ACCORDANCE WITH REGIONAL INFRASTRUCTURE TECHNICAL SPECIFICATIONS 2018 AND SUBSEQUENT UPDATES.
  - . ALL WORKS TO BE IN ACCORDANCE WITH WAIKATO REGIONAL COUNCIL EROSION AND SEDIMENT CONTROL GUIDELINES FOR SOIL DISTURBING ACTIVITIES 2009 AND SUBSEQUENT UPDATES.
- COORDINATES IN TERMS OF NZ GEODETIC DATUM MT EDEN 2000. LEVELS IN TERMS OF NZVD16 VERTICAL DATUM 1946.
- EXISTING SERVICES ARE FROM B4UDIG AND THEY ARE INDICATIVE ONLY. CONTRACTOR TO LOCATE THE EXISTING SERVICES PRIOR TO CONSTRUCTION.
- 5. REFER TO THE ROADING C300 SERIES DRAWING FOR THE PROPOSED DRAINAGE CULVERT LOCATIONS.

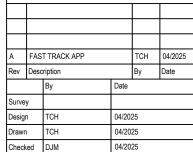



Project

ASHBOURNE
SOUTHERN SOLAR FARM
FOR
MATAMATA
DEVELOPMENTS LTD

Title

PROPOSED STORMWATER DETAILS PLAN

Project no.	289001		
Scale	N.T.S		
Cad file	C480-SW DET.DWG		
Drawing no.	C480	Rev	Α

RESOURCE CONSENT



