



PROPOSED  
NORTHERN SOLAR FARM

STATION ROAD

STATION ROAD

C500-1

C500-2

C500-3

C500-4

C500-5

C500-6

C500-7

C500-8

C500-9

C500-10

BALANCE LOT

PROPOSED  
RETIREMENT VILLAGE

PROPOSED GREENWAY

PROPOSED  
SOUTHERN SOLAR FARM

- Notes
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Legend

---	EX BOUNDARY
---	PROP BOUNDARY
---	EX WASTEWATER
---	PR WASTEWATER
---	WW RISING MAIN
⊙	EX/PROP WWMH
---	WW LOT CONNECTION

E	FAST TRACK APP	RJM	11/2025
D	FAST TRACK APP	MKS	06/2025
C	FAST TRACK APP	MKS	05/2025
B	FAST TRACK APP	RJM	04/2025
Rev	Description	By	Date
		By	Date
Survey	MAVEN		05/2024
Design	MKS		04/2025
Drawn	MKS		04/2025
Checked	DJM		06/2025



**Maven Associates**  
09 571 0050  
info@maven.co.nz  
www.maven.co.nz  
5 Owens Road, Epsom  
Auckland 1023

Project  
**ASHBOURNE  
RESIDENTIAL  
FOR  
MATAMATA  
DEVELOPMENTS LTD**

Title  
**PROPOSED  
WASTEWATER DRAINAGE  
OVERVIEW PLAN**

Project no.	289001		
Scale	1:6000 @ A3		
Cad file	C500-WASTEWATER.DWG		
Drawing no.	C500	Rev	E

RESOURCE CONSENT

DATE: 11/11/25 FILEPATH: F:\MAVEN\HAMILTON\6 PROJECTS\289001 - STATION ROAD\7 DRAWING\11 ASHBORNE RESIDENTIAL\0500 WASTEWATER.DWG



APOROD DRIVE

ODLUM DRIVE

LOT 1  
DP 365568

LOT 2  
DP 365568

LOT 1  
DP 404835

LOT 2  
DP 404835

LOT 5  
DP 365568

PR WWMH C32 1050Ø  
LL=66.23  
PR WWMH C31 1050Ø,=64.38 (C31 out)  
LL=66.69  
IL=63.81 (C32 in)  
IL=63.74 (C2 out)

PR WWMH C1 1050Ø  
LL=66.48  
IL=62.66 (C2 in)

PR WWMH C2 1050Ø  
LL=66.61  
IL=62.80 (C3 in)  
IL=62.81 (C31 in)  
IL=62.73 (C1 out)

150mm uPVC SN16 @ 0.55%

150mm uPVC SN16 @ ROAD 1

150mm uPVC SN16 @ 2.00%

PROPOSED NORTHERN WWPS  
SEE C535-1 DRAWING FOR DETAILS

PLEASE SEE PLAN C530  
FOR THE WIDER RISING MAIN DRAWINGS

STORMWATER  
BASIN D

PROPOSED WW RISING MAIN 140mmØ

RESOURCE CONSENT

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Rev	Description	By	Date
		By	Date
Survey	MAVEN		03/2024
Design	MKS		11/2024
Drawn	MKS		11/2024
Checked	DJM		06/2025

**M** Maven Associates  
09 571 0050  
info@maven.co.nz  
www.maven.co.nz  
5 Owens Road, Epsom  
Auckland 1023

Project  
**ASHBOURNE  
RESIDENTIAL  
FOR  
MATAMATA  
DEVELOPMENTS LTD**

Title  
**PROPOSED  
WASTEWATER  
DRAINAGE PLAN**

Project no.	289001		
Scale	1:1000 @ A3		
Cad file	C500-WASTEWATER.DWG		
Drawing no.	C500-1	Rev	E





OLIVE PLACE


LOT 3  
DP 404835

LOT 9  
DP 562902

LOT 13  
DP 562902

LOT 14  
DP 562902

RESOURCE CONSENT

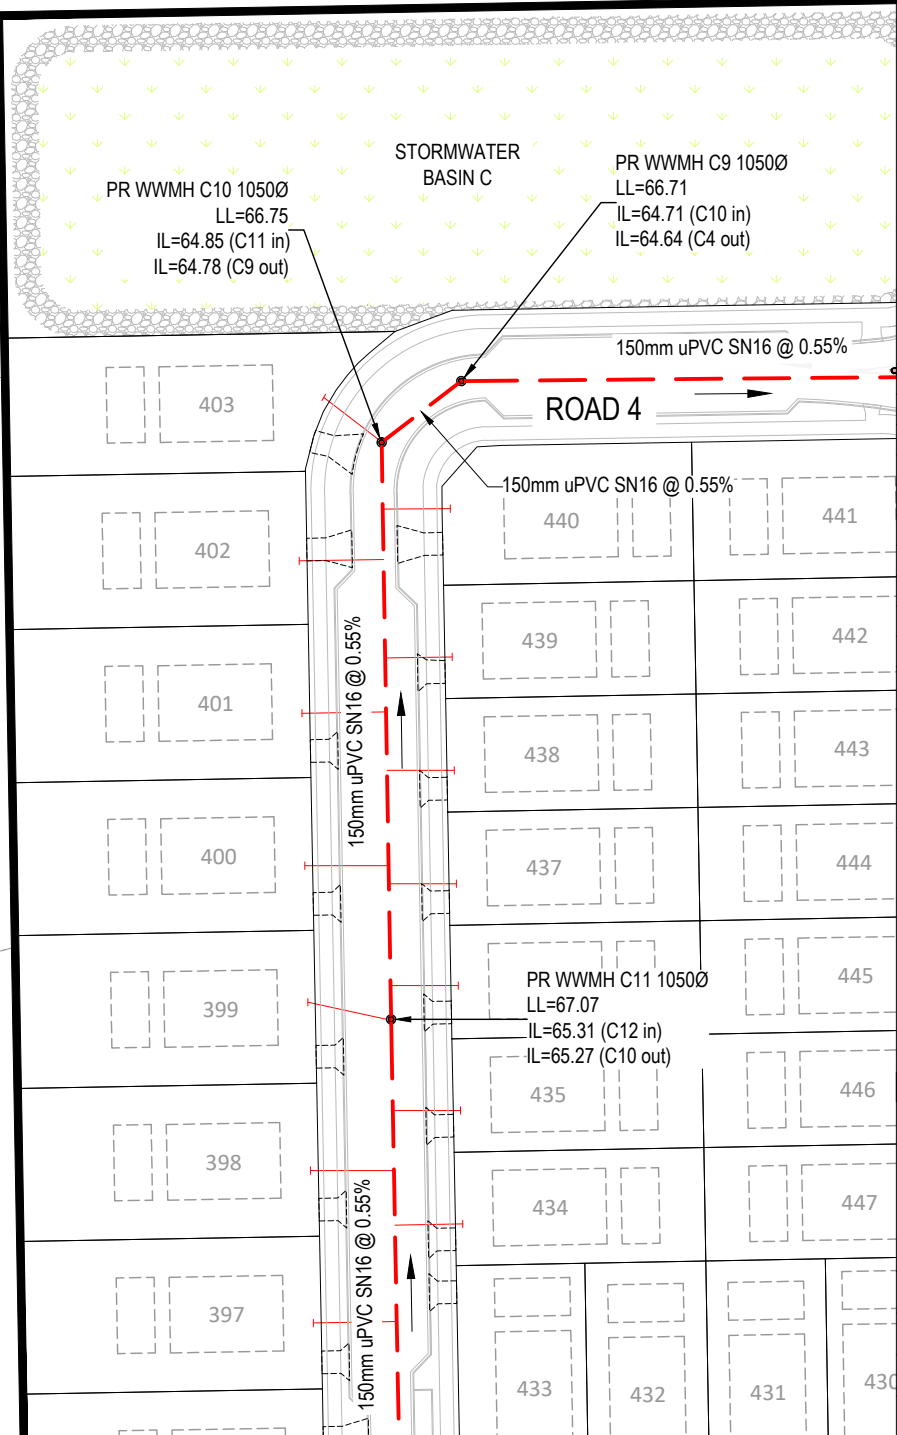

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**M** **Maven Associates**  
09 571 0050  
info@maven.co.nz  
www.maven.co.nz  
5 Owens Road, Epsom  
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**PROPOSED  
WASTEWATER  
DRAINAGE PLAN**

Project no.	289001		
Scale	1:1000 @ A3		
Cad file	C500-WASTEWATER.DWG		
Drawing no.	C500-2	Rev	E







HIGHGROVE AVENUE

LOT 16  
DP 562902

LOT 17  
DP 562902

LOT 18  
DP 562902

PR WWMH B51 1050Ø  
LL=68.24  
IL=66.48 (B50 out)

PR WWMH B48 1050Ø  
LL=68.07  
IL=66.60 (B43 out)

PR WWMH B43 1050Ø  
LL=67.90  
IL=66.09 (B44 in)  
IL=66.11 (B48 in)  
IL=66.02 (B42 out)

PR WWMH B44 1050Ø  
LL=68.17  
IL=66.73 (B43 out)

PR WWMH B37 1050Ø  
LL=68.86  
IL=67.25 (B36 out)

PR WWMH B36 1050Ø  
LL=68.44  
IL=66.68 (B37 in)  
IL=66.61 (B35 out)

PR WWMH B47 1050Ø  
LL=68.17  
IL=66.50 (B46 out)

PR WWMH B42 1050Ø  
LL=67.43  
IL=65.82 (B43 in)  
IL=65.78 (B41 out)

PR WWMH B46 1050Ø  
LL=67.80  
IL=66.03 (B47 in)  
IL=65.96 (B41 out)

PR WWMH B35 1050Ø  
LL=67.92  
IL=65.90 (B36 in)  
IL=65.97 (B38 in)  
IL=65.86 (B16 out)

PR WWMH B38 1050Ø  
LL=68.05  
IL=66.86 (B35 out)

PR WWMH B41 1050Ø  
LL=67.28  
IL=65.50 (B42 in)  
IL=65.53 (B46 in)  
IL=65.46 (B40 out)

PR WWMH B50 1050Ø  
LL=67.41  
IL=66.04 (B51 in)  
IL=66.00 (B49 out)

ROAD 9

ROAD 5

ROAD 4

ROAD 2

RESOURCE CONSENT

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Rev	Description	By	Date


Survey	MAVEN	Date	05/2024
Design	MKS		04/2025
Drawn	MKS		04/2025
Checked	DJM		06/2025



Project  
**ASHBOURNE  
RESIDENTIAL  
FOR  
MATAMATA  
DEVELOPMENTS LTD**

Title  
**PROPOSED  
WASTEWATER  
DRAINAGE PLAN**

Project no.	289001
Scale	1:1000 @ A3
Cad file	C500-WASTEWATER.DWG
Drawing no.	C500-4
Rev	E

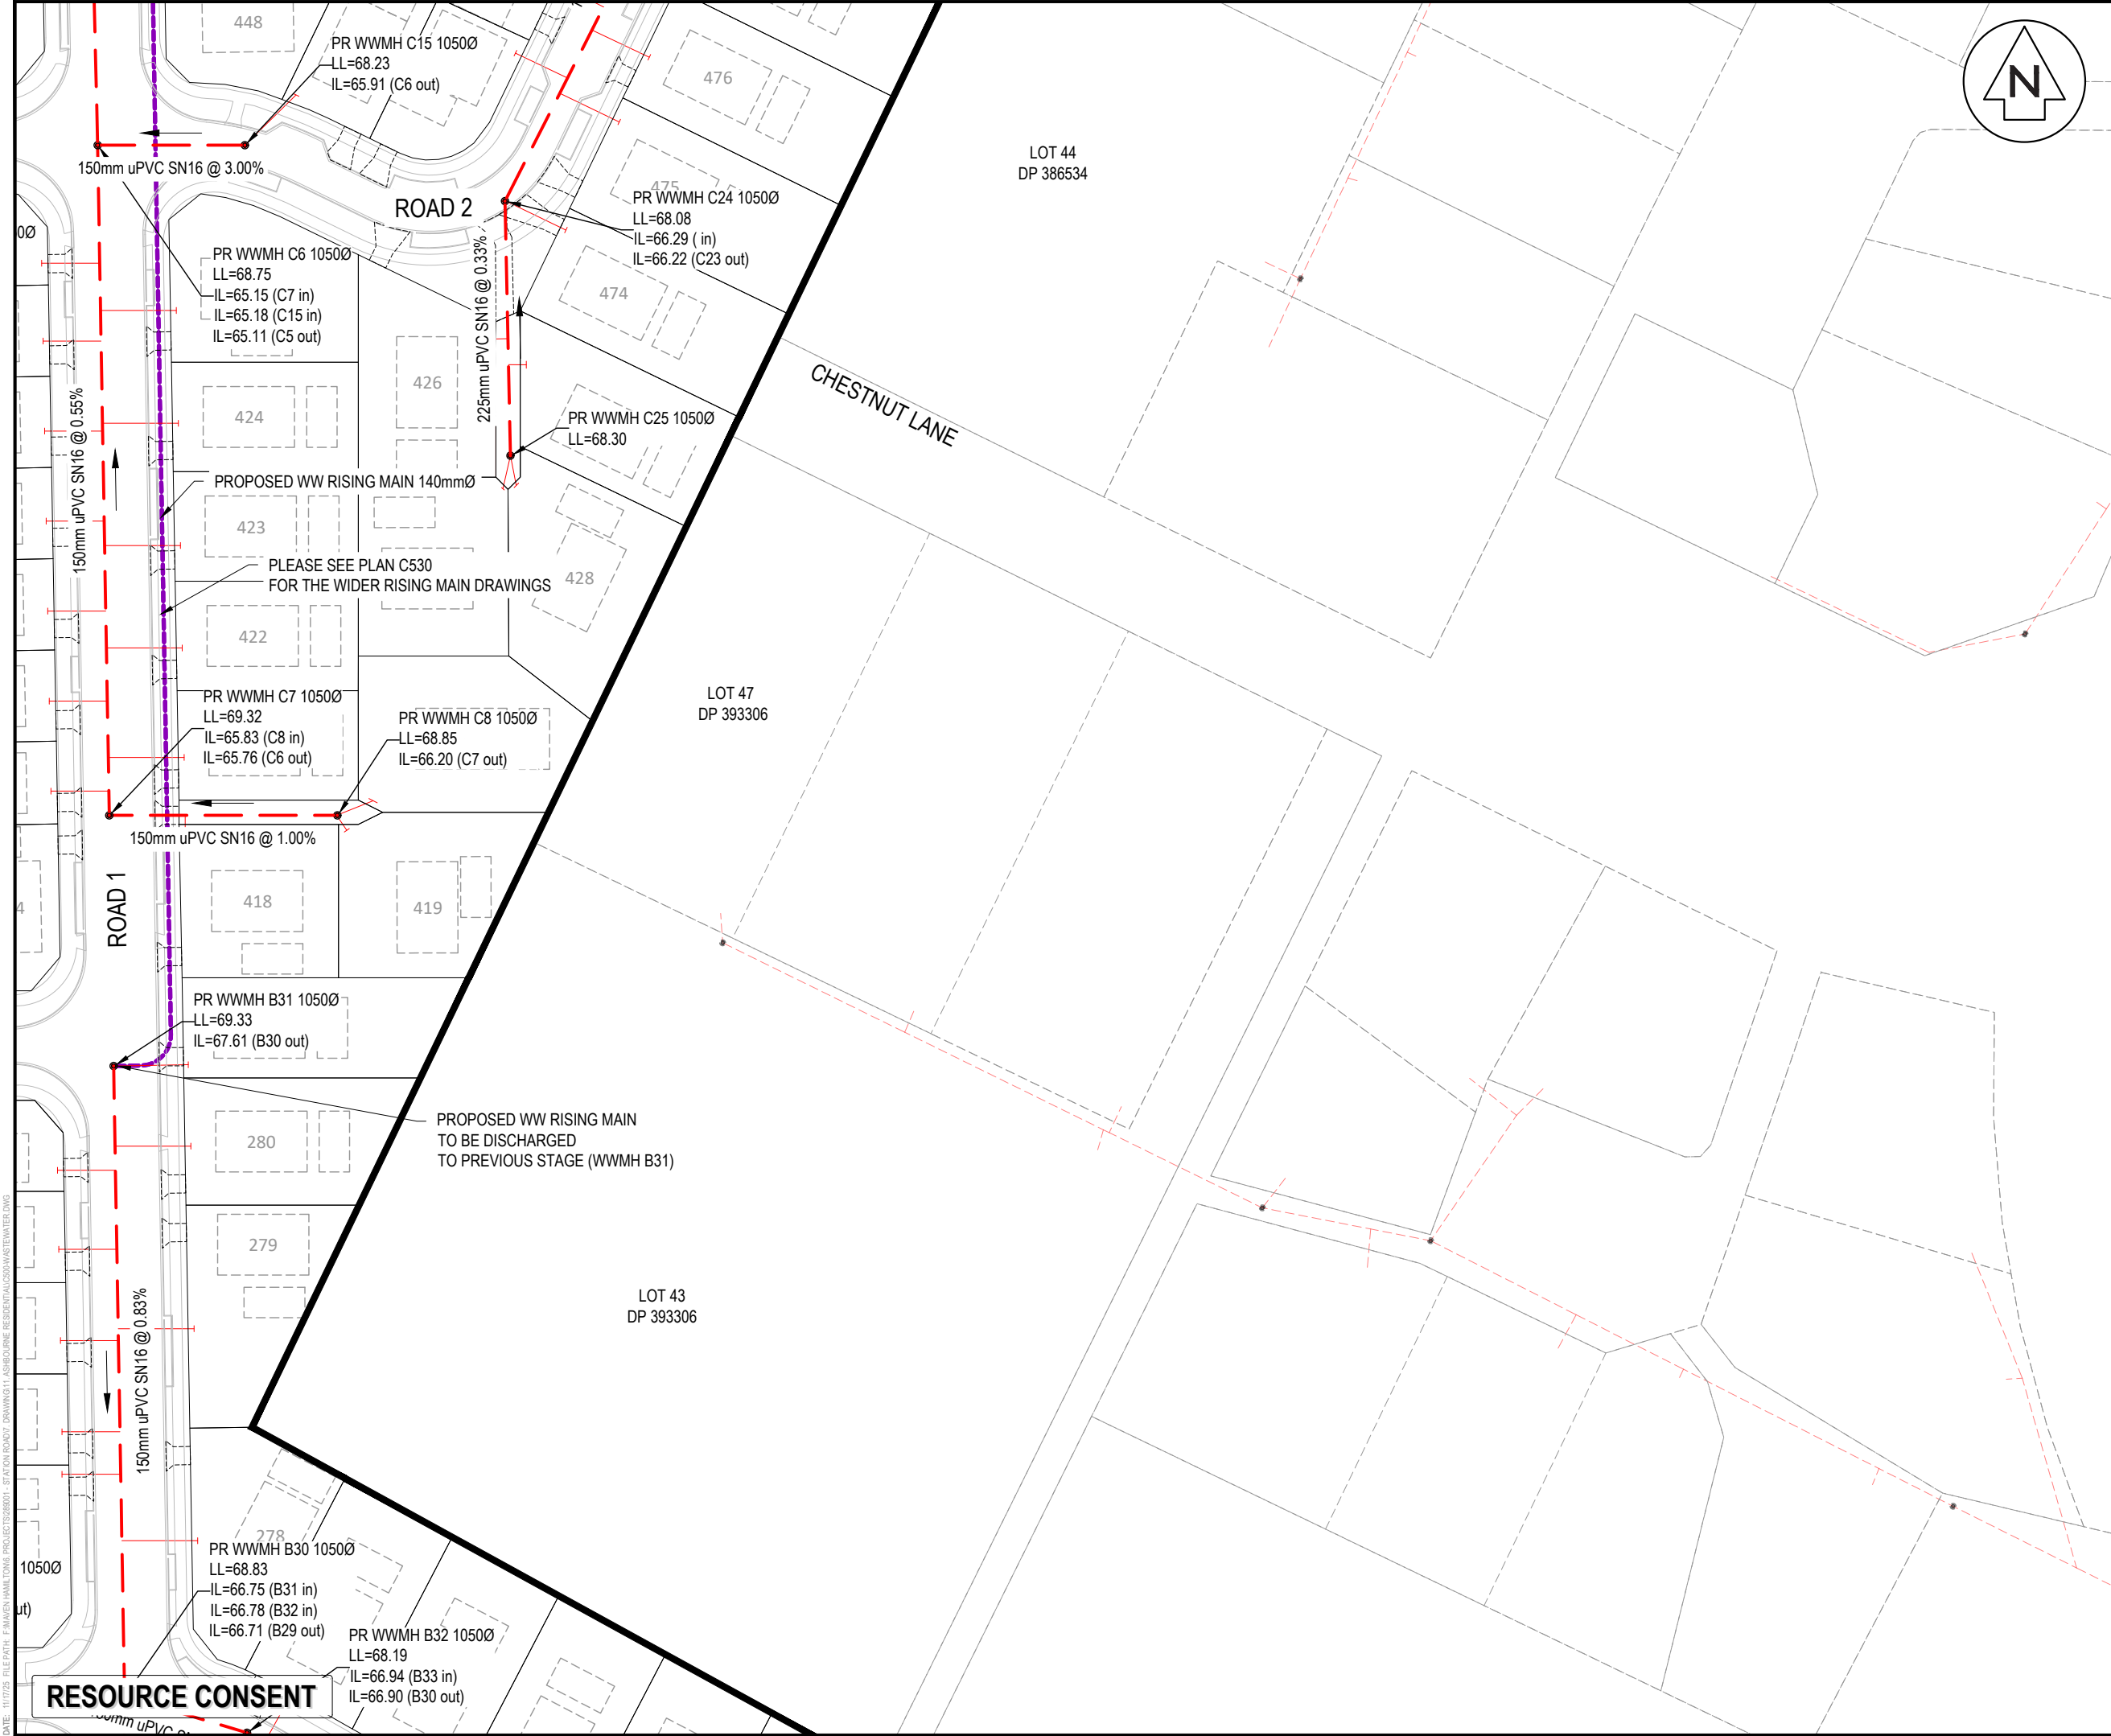

Notes

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09 571 0050  
info@maven.co.nz  
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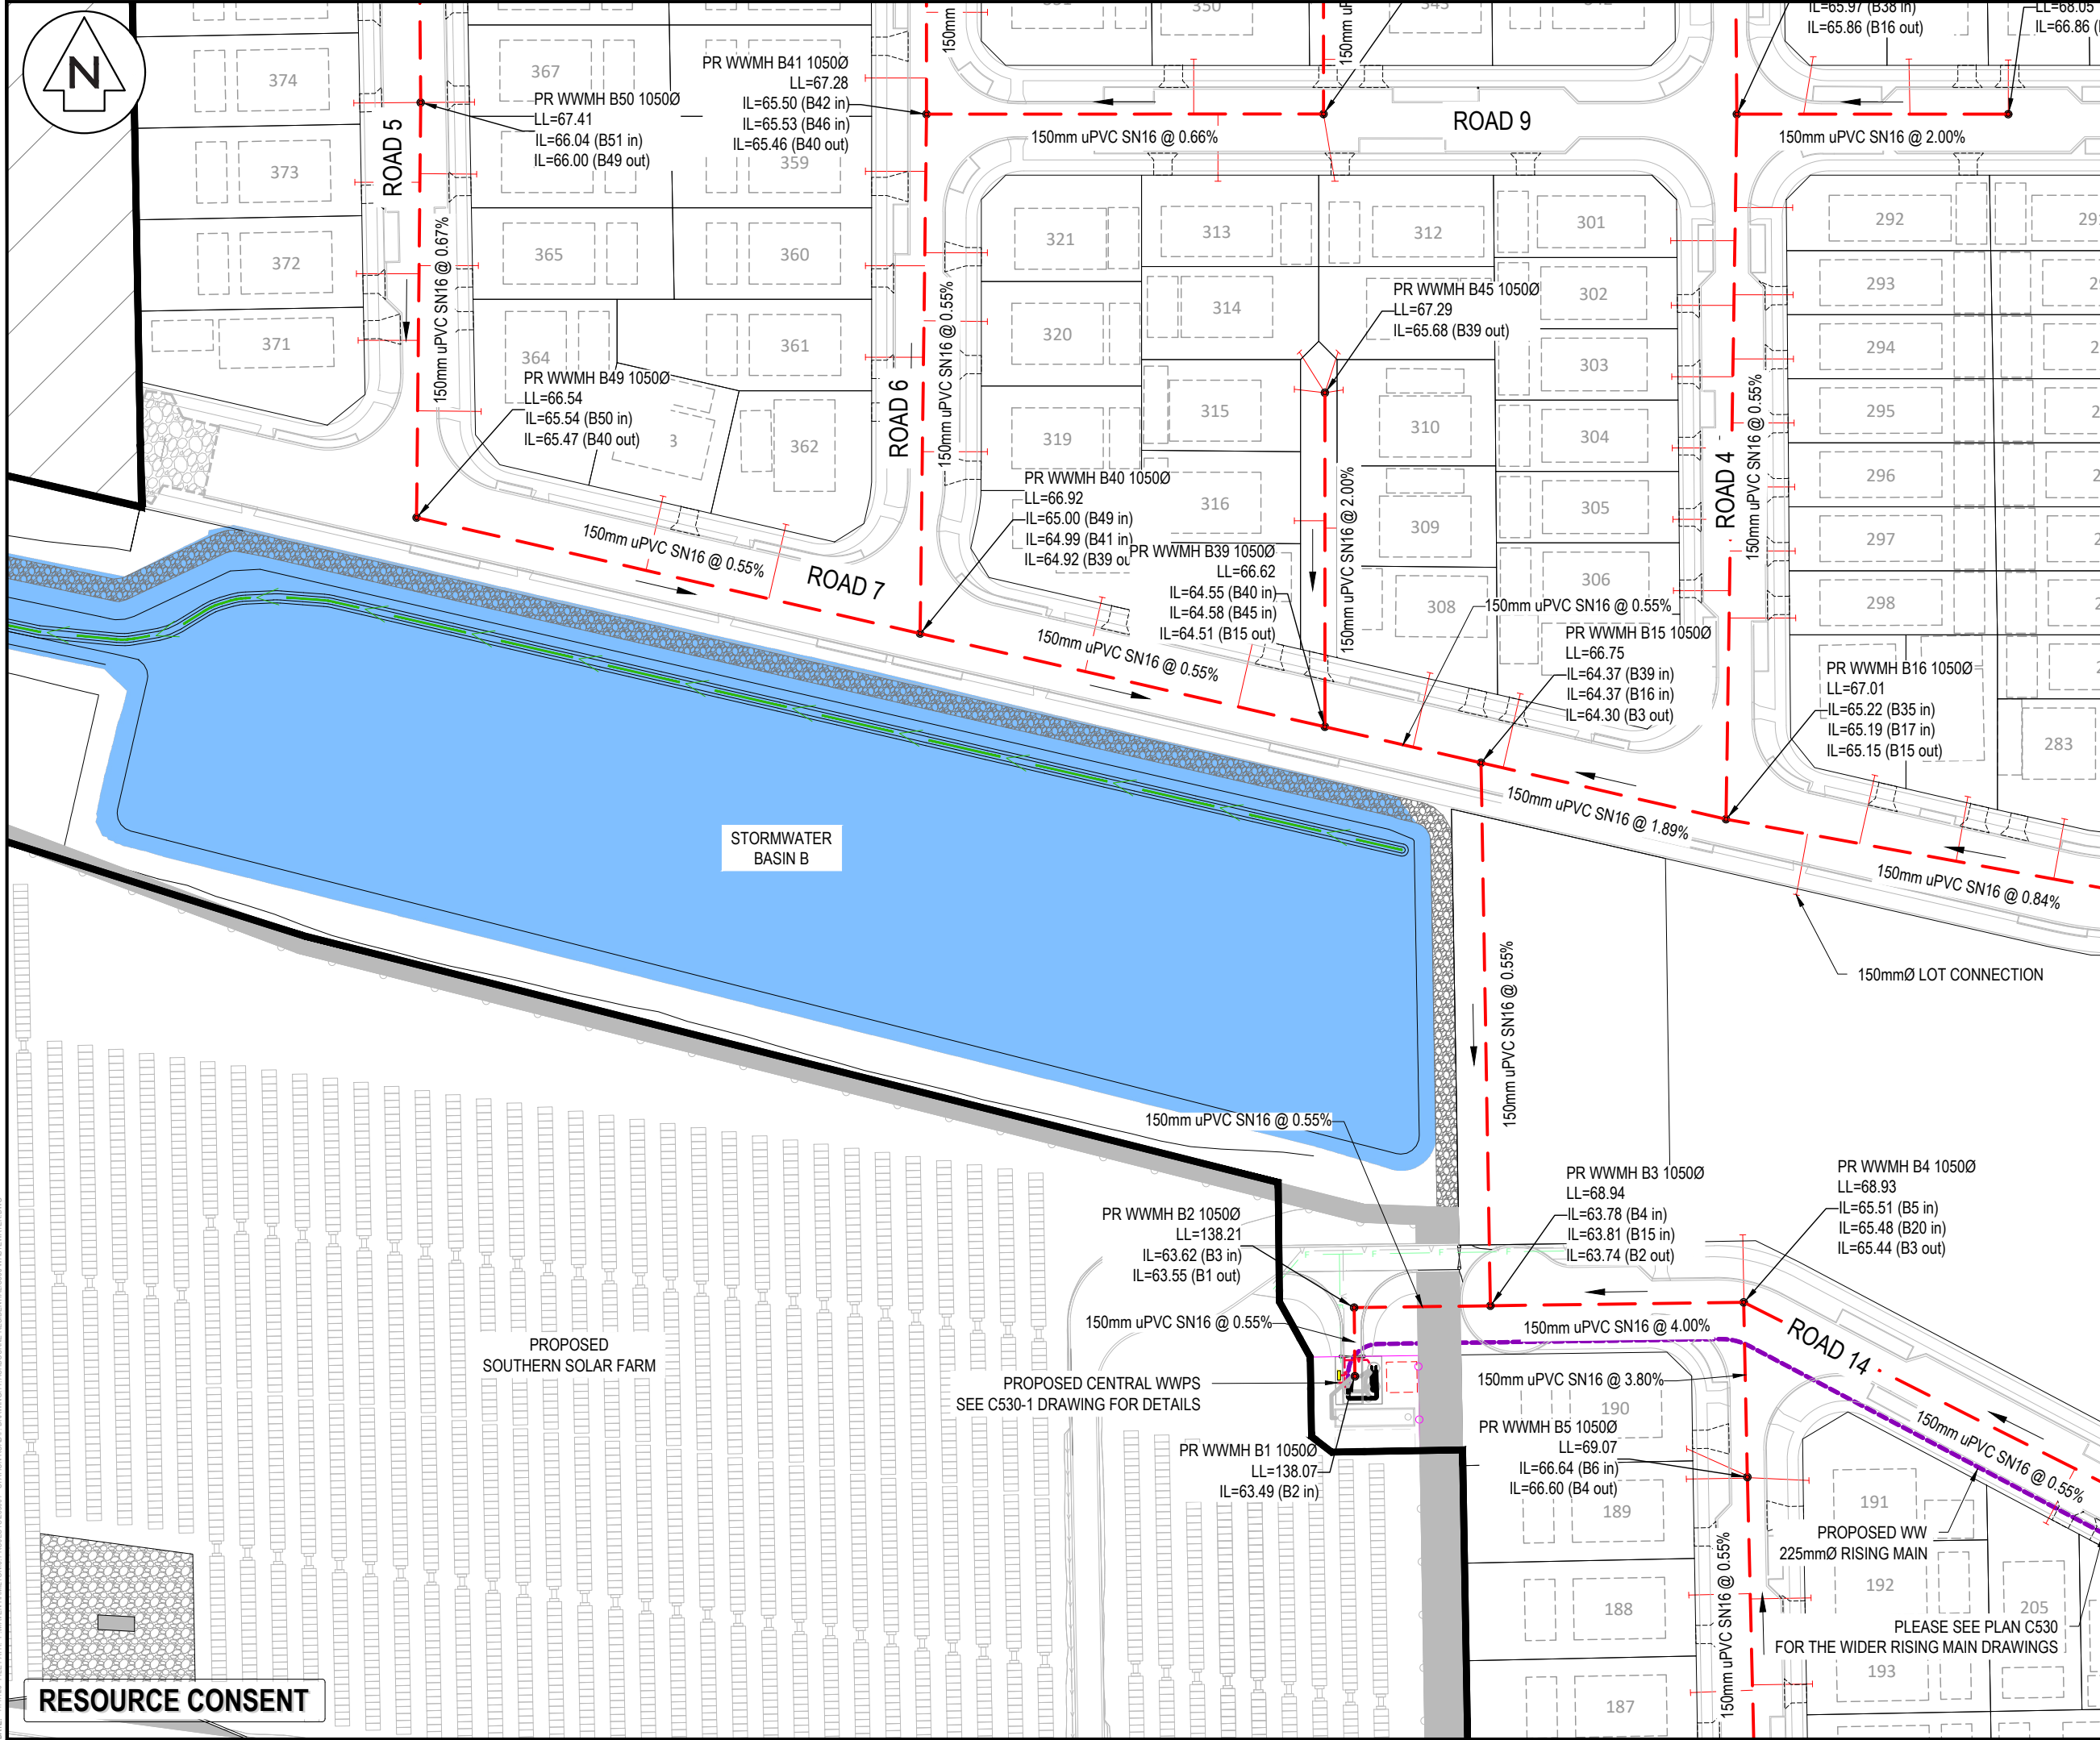
Title

**PROPOSED  
WASTEWATER  
DRAINAGE PLAN**

Project no.	289001		
Scale	1:1000 @ A3		
Cad file	C500-WASTEWATER.DWG		
Drawing no.	C500-5	Rev	E

DATE: 11/11/25 FILEPATH: F:\MAVEN\HAMITONG PROJECTS\289001 - STATION ROAD.DWG DRAWING: G11, ASHBORNE RESIDENTIAL\CS00\WASTEWATER.DWG





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**Maven Associates**  
09 571 0050  
info@maven.co.nz  
www.maven.co.nz  
5 Owens Road, Epsom  
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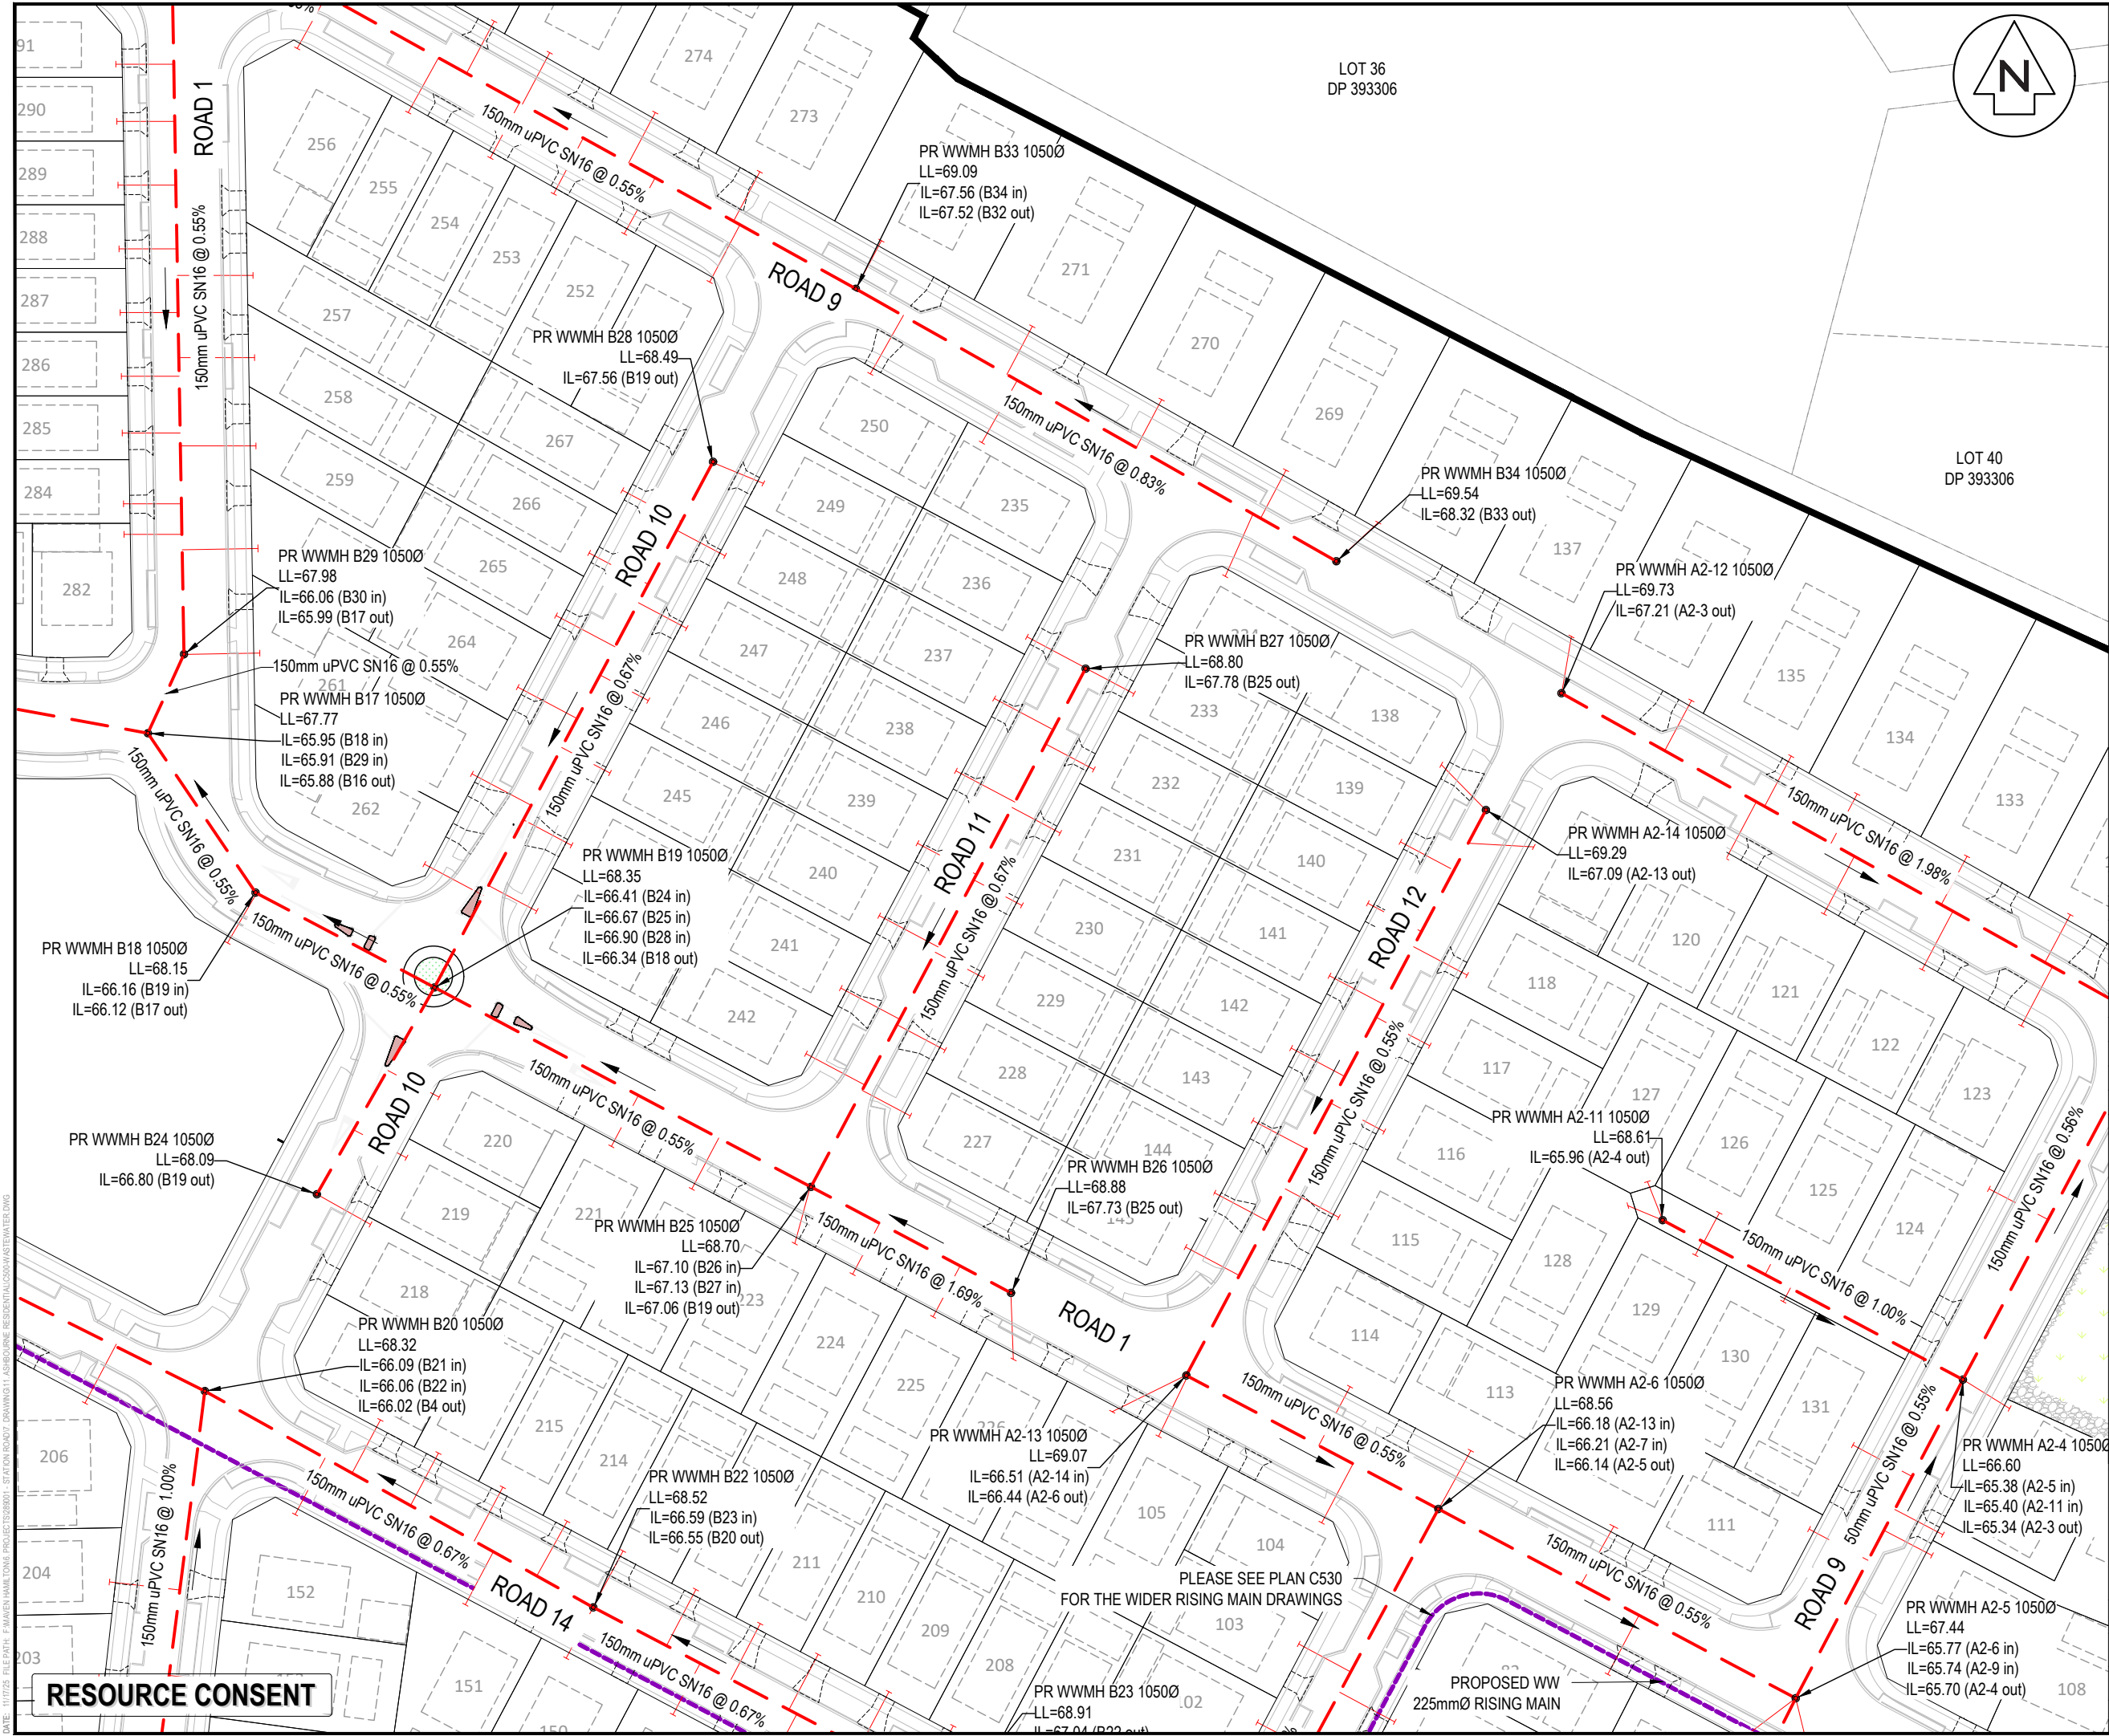
Title

**PROPOSED  
WASTEWATER  
DRAINAGE PLAN**

Project no.	289001
Scale	1:1000 @ A3
Cad file	C500-WASTEWATER.DWG
Drawing no.	C500-6
Rev	E

DATE: 11/07/25 FILEPATH: F:\MAVEN\HAMITON6 PROJECTS\289001 - STATION ROAD7 DRAWING\11 ASHBOURNE RESIDENTIAL\500 WASTEWATER.DWG





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info@maven.co.nz  
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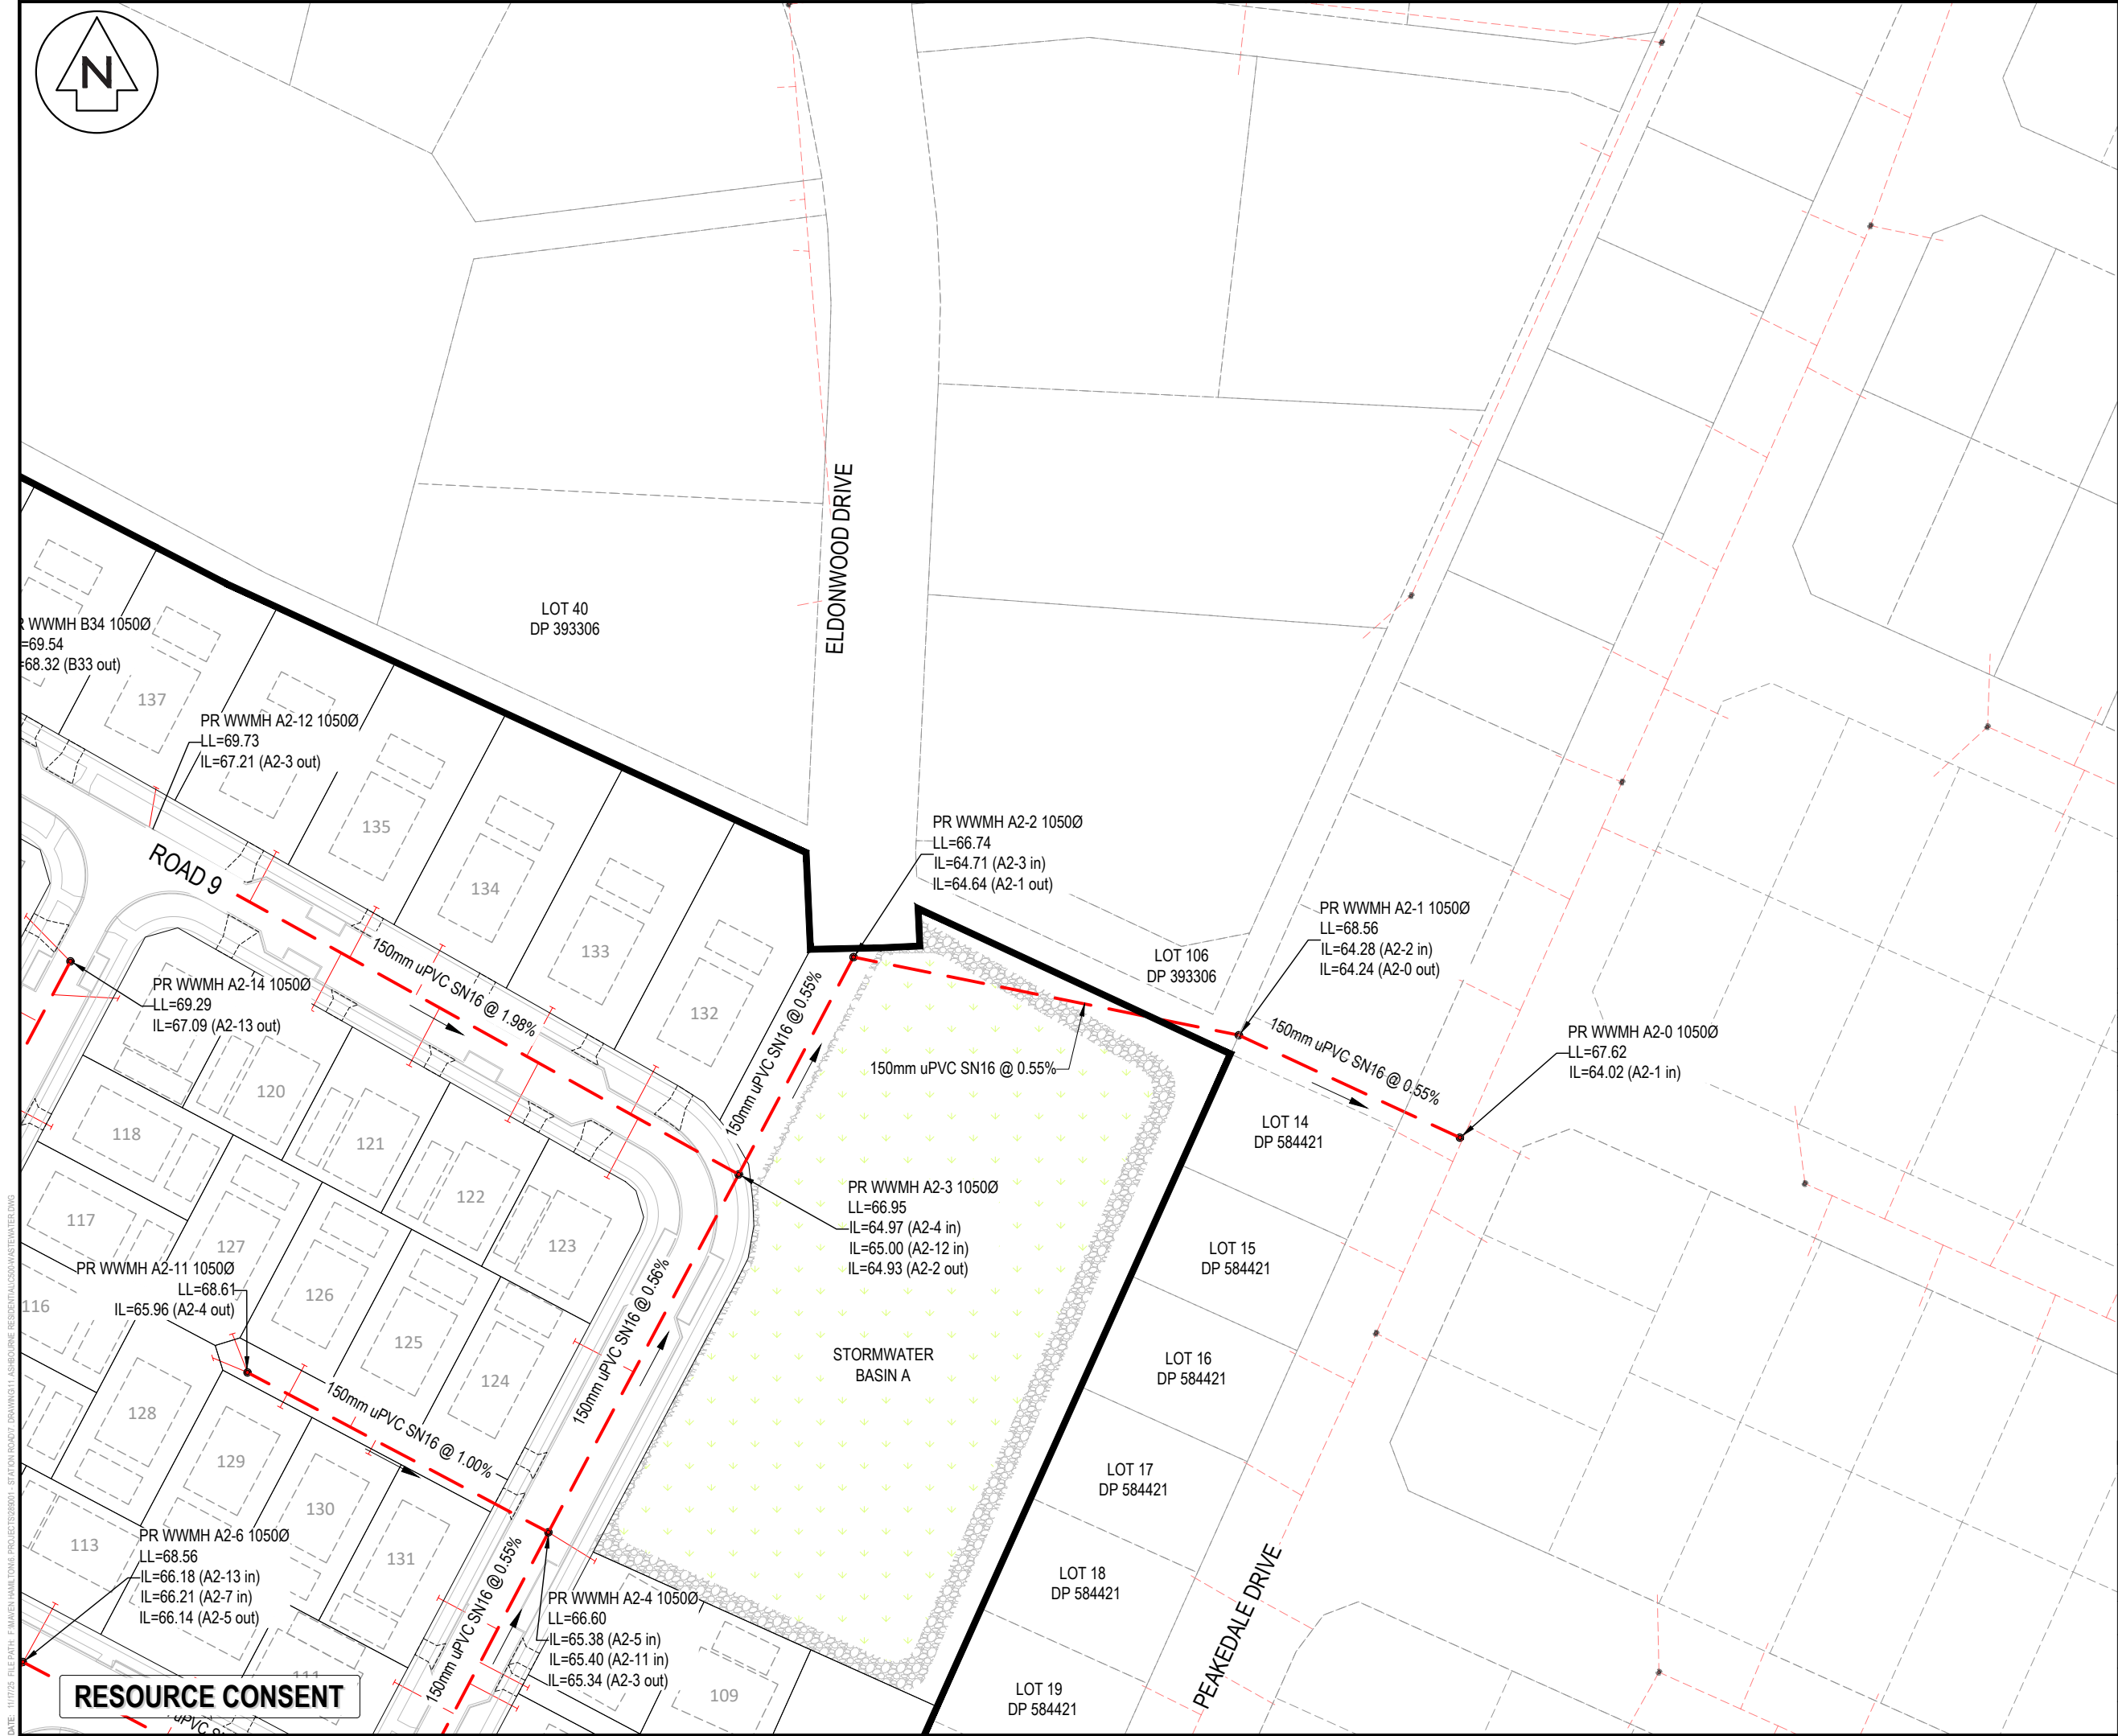
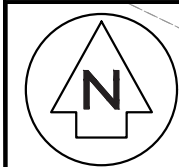
Project  
**ASHBOURNE  
RESIDENTIAL  
FOR  
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Title  
**PROPOSED  
WASTEWATER  
DRAINAGE PLAN**

Project no.	289001
Scale	1:1000 @ A3
Cad file	C500-WASTEWATER.DWG
Drawing no.	C500-7
Rev	E

DATE: 11/11/25 FILEPATH: F:\Maven\Hamilton\6 PROJECTS\289001 - STATION ROAD\DRAWING\11 ASHBORNE RESIDENTIAL\WASTEWATER.DWG





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**Maven Associates**  
09 571 0050  
info@maven.co.nz  
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5 Owens Road, Epsom  
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Project

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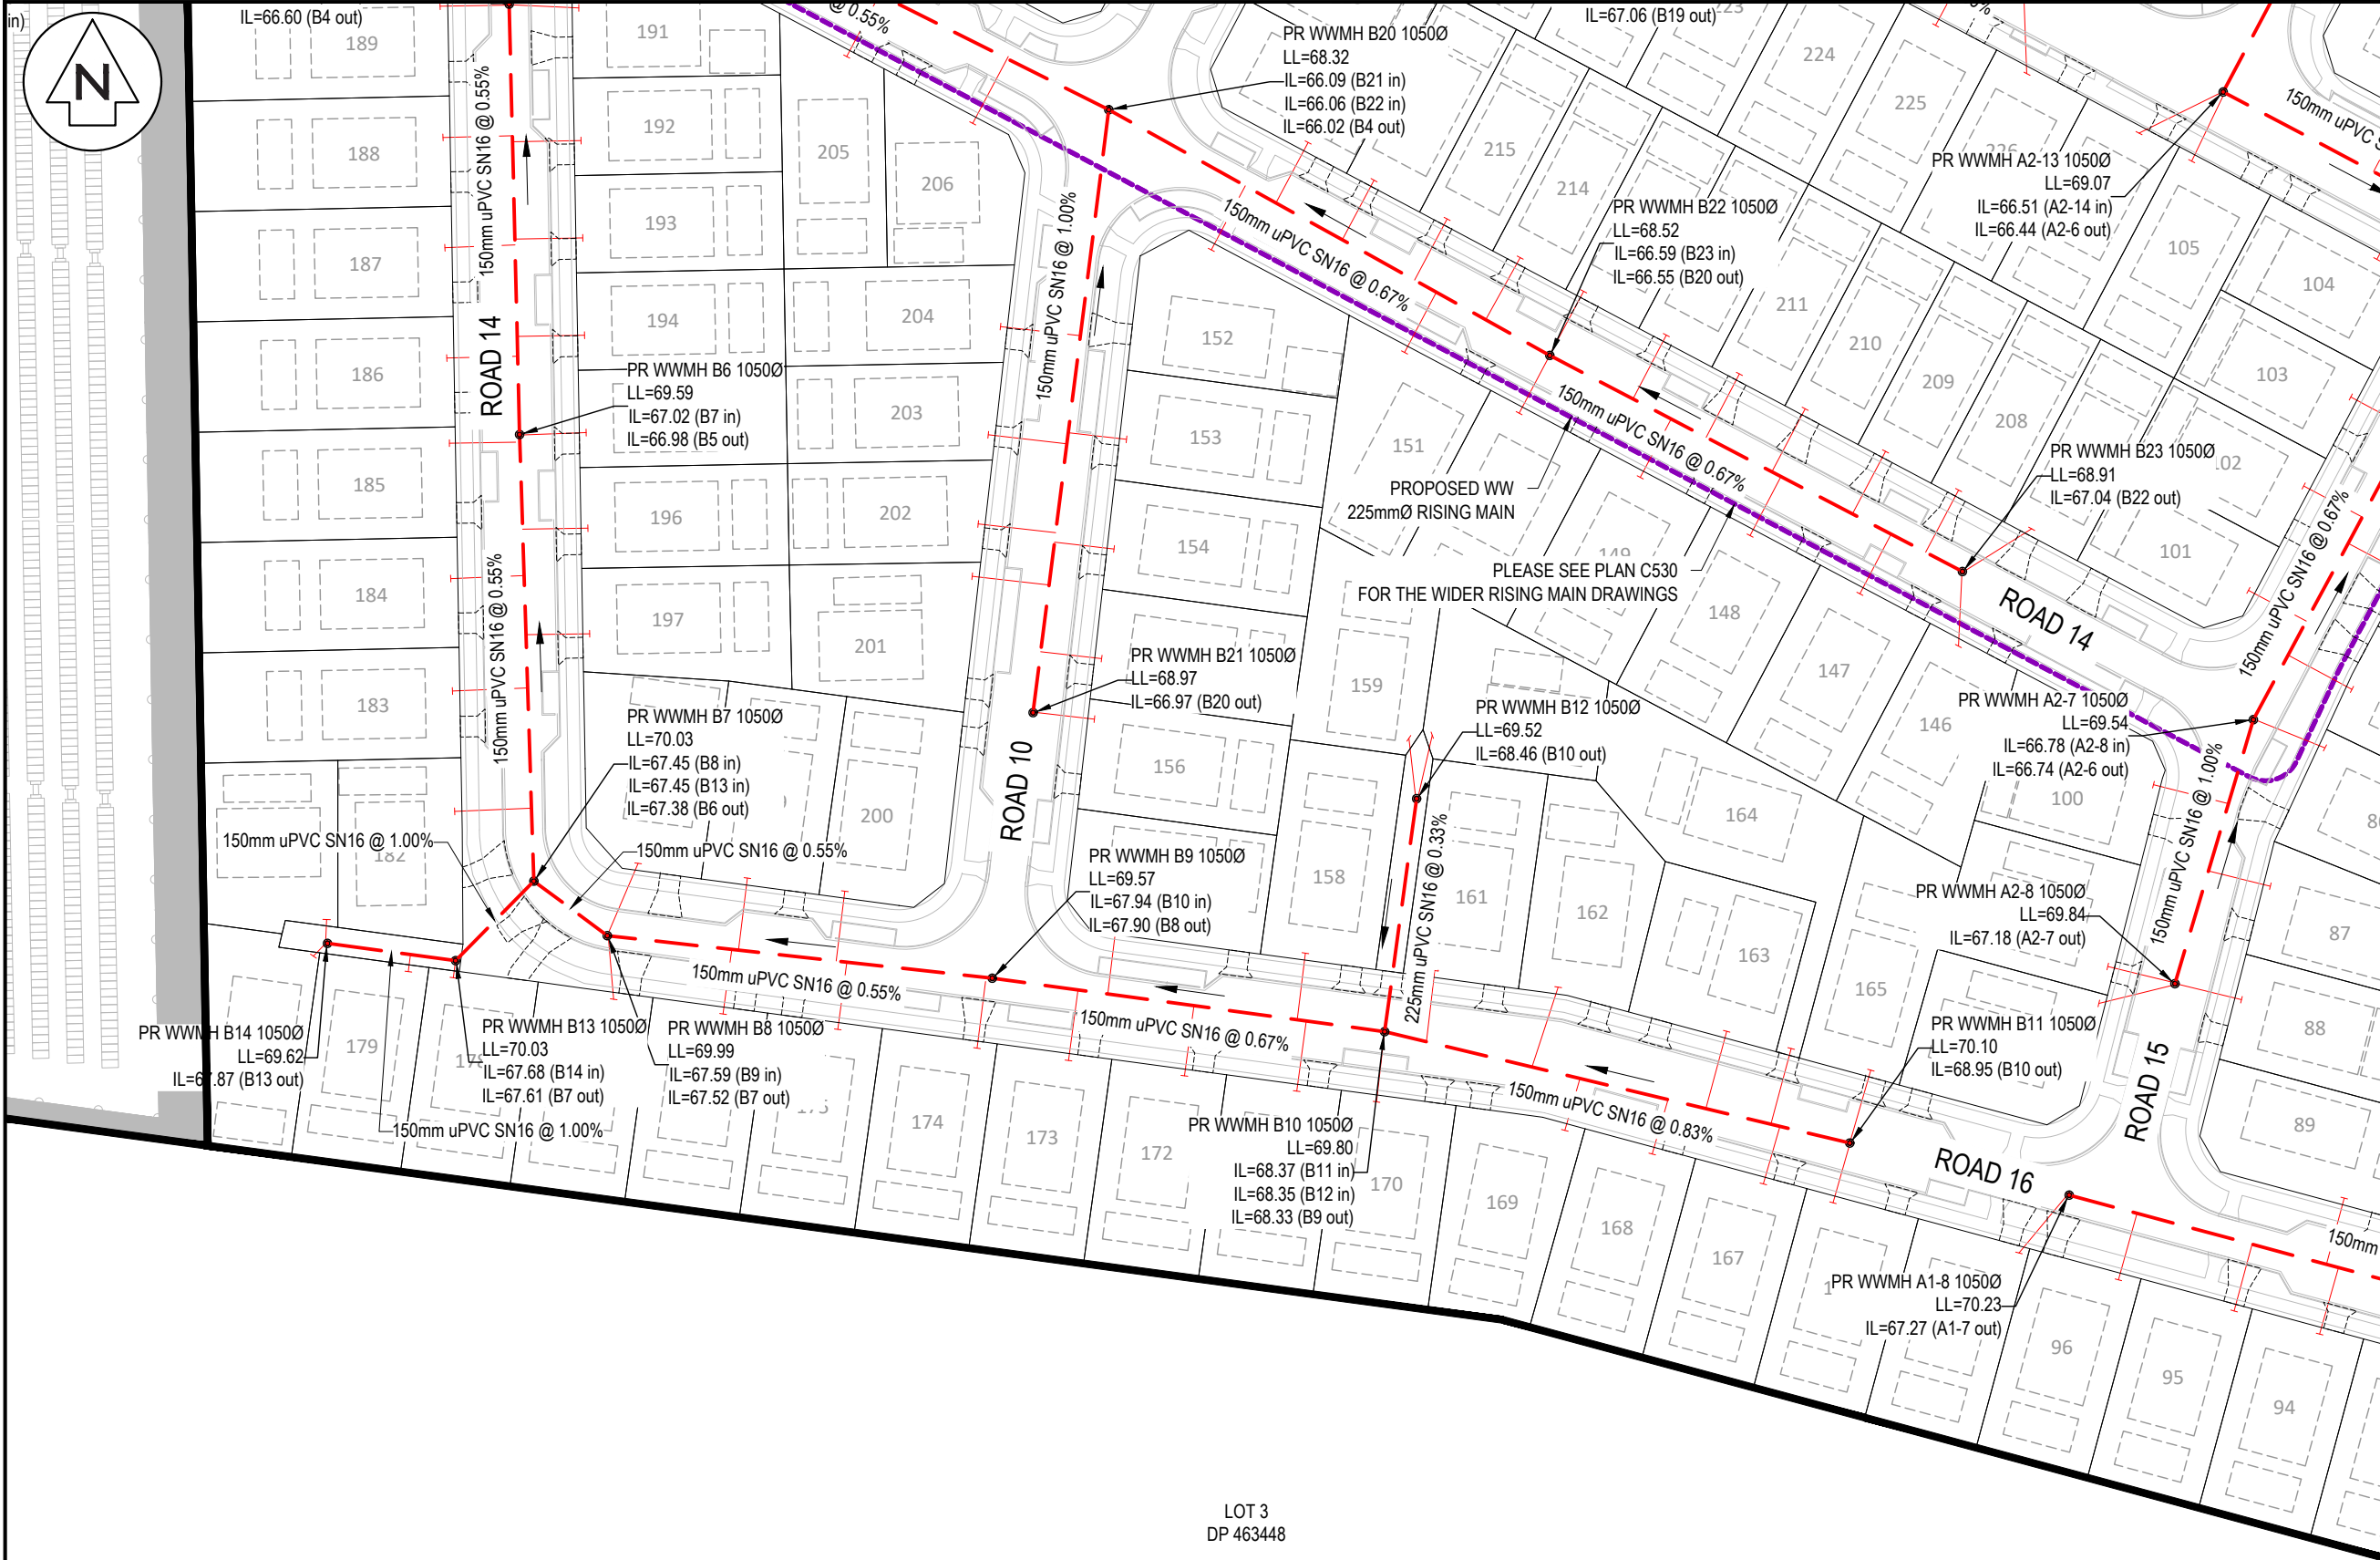
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**PROPOSED  
WASTEWATER  
DRAINAGE PLAN**

Project no.	289001		
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DATE: 11/11/25 FILEPATH: F:\MVEN\HAMITONG PROJECTS\289001 - STATION ROAD\ DRAWING\11. ASHBORNE RESIDENTIAL\500\WASTEWATER.DWG

RESOURCE CONSENT



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Drawing no.	C500-9	Rev	E

RESOURCE CONSENT









SERVICE IS TO EXTEND 1.0m PASSED  
STAGE BOUNDARY AND CAPPED  
FOR FUTURE STAGE CONNECTION

STORMWATER  
BASIN A

FROM PR WWMH A2-0  
TO PR WWMH A2-1  
TO BE CONSTRUCTED  
IN STAGE 2

LOT 106  
DP 393306

LOT 14  
DP 584421

LOT 15  
DP 584421

LOT 16  
DP 584421

LOT 17  
DP 584421

LOT 18  
DP 584421

LOT 19  
DP 584421

LOT 20  
DP 584421

LOT 22  
DP 584421

LOT 70  
DP 584421

LOT 71  
DP 584421

LOT 72  
DP 584421

LOT 73  
DP 584421

LOT 74  
DP 584421

ROAD 1

PLEASE SEE PLAN C530  
FOR THE WIDER RISING MAIN DRAWINGS

PROPOSED WW  
225mmØ RISING MAIN

PROPOSED WW  
225mmØ RISING MAIN  
TO BE CONTINUED  
IN STAGE 3

LOT 77  
DP 07627

ROAD 13

ROAD 8

ROAD 16

LOT 3  
DP 463448

SERVICE IS TO EXTEND 1.0m PASSED  
STAGE BOUNDARY AND CAPPED  
FOR FUTURE STAGE CONNECTION

SERVICE IS TO EXTEND 1.0m PASSED  
STAGE BOUNDARY AND CAPPED  
FOR FUTURE STAGE CONNECTION

#### Notes

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#### Legend

---	EX BOUNDARY
---	PROP BOUNDARY
---	EX WASTEWATER
---	PR WASTEWATER
---	WW RISING MAIN
○	EX/PROP WWMH
+	WW LOT CONNECTION

C	FAST TRACK APP	RJM	11/2025
B	FAST TRACK APP	MKS	06/2025
A	FAST TRACK APP	MKS	05/2025
Rev	Description	By	Date
Survey	MAVEN		05/2024
Design	MKS		04/2025
Drawn	MKS		04/2025
Checked	DJM		05/2025




Project  
**ASHBOURNE  
RESIDENTIAL  
FOR  
MATAMATA  
DEVELOPMENTS LTD**

Title  
**PROPOSED  
WASTEWATER DRAINAGE  
PLAN STAGE 1**

Project no.	289001		
Scale	1:1500 @ A3		
Cad file	C500-WASTEWATER.DWG		
Drawing no.	C500-11	Rev	C

RESOURCE CONSENT



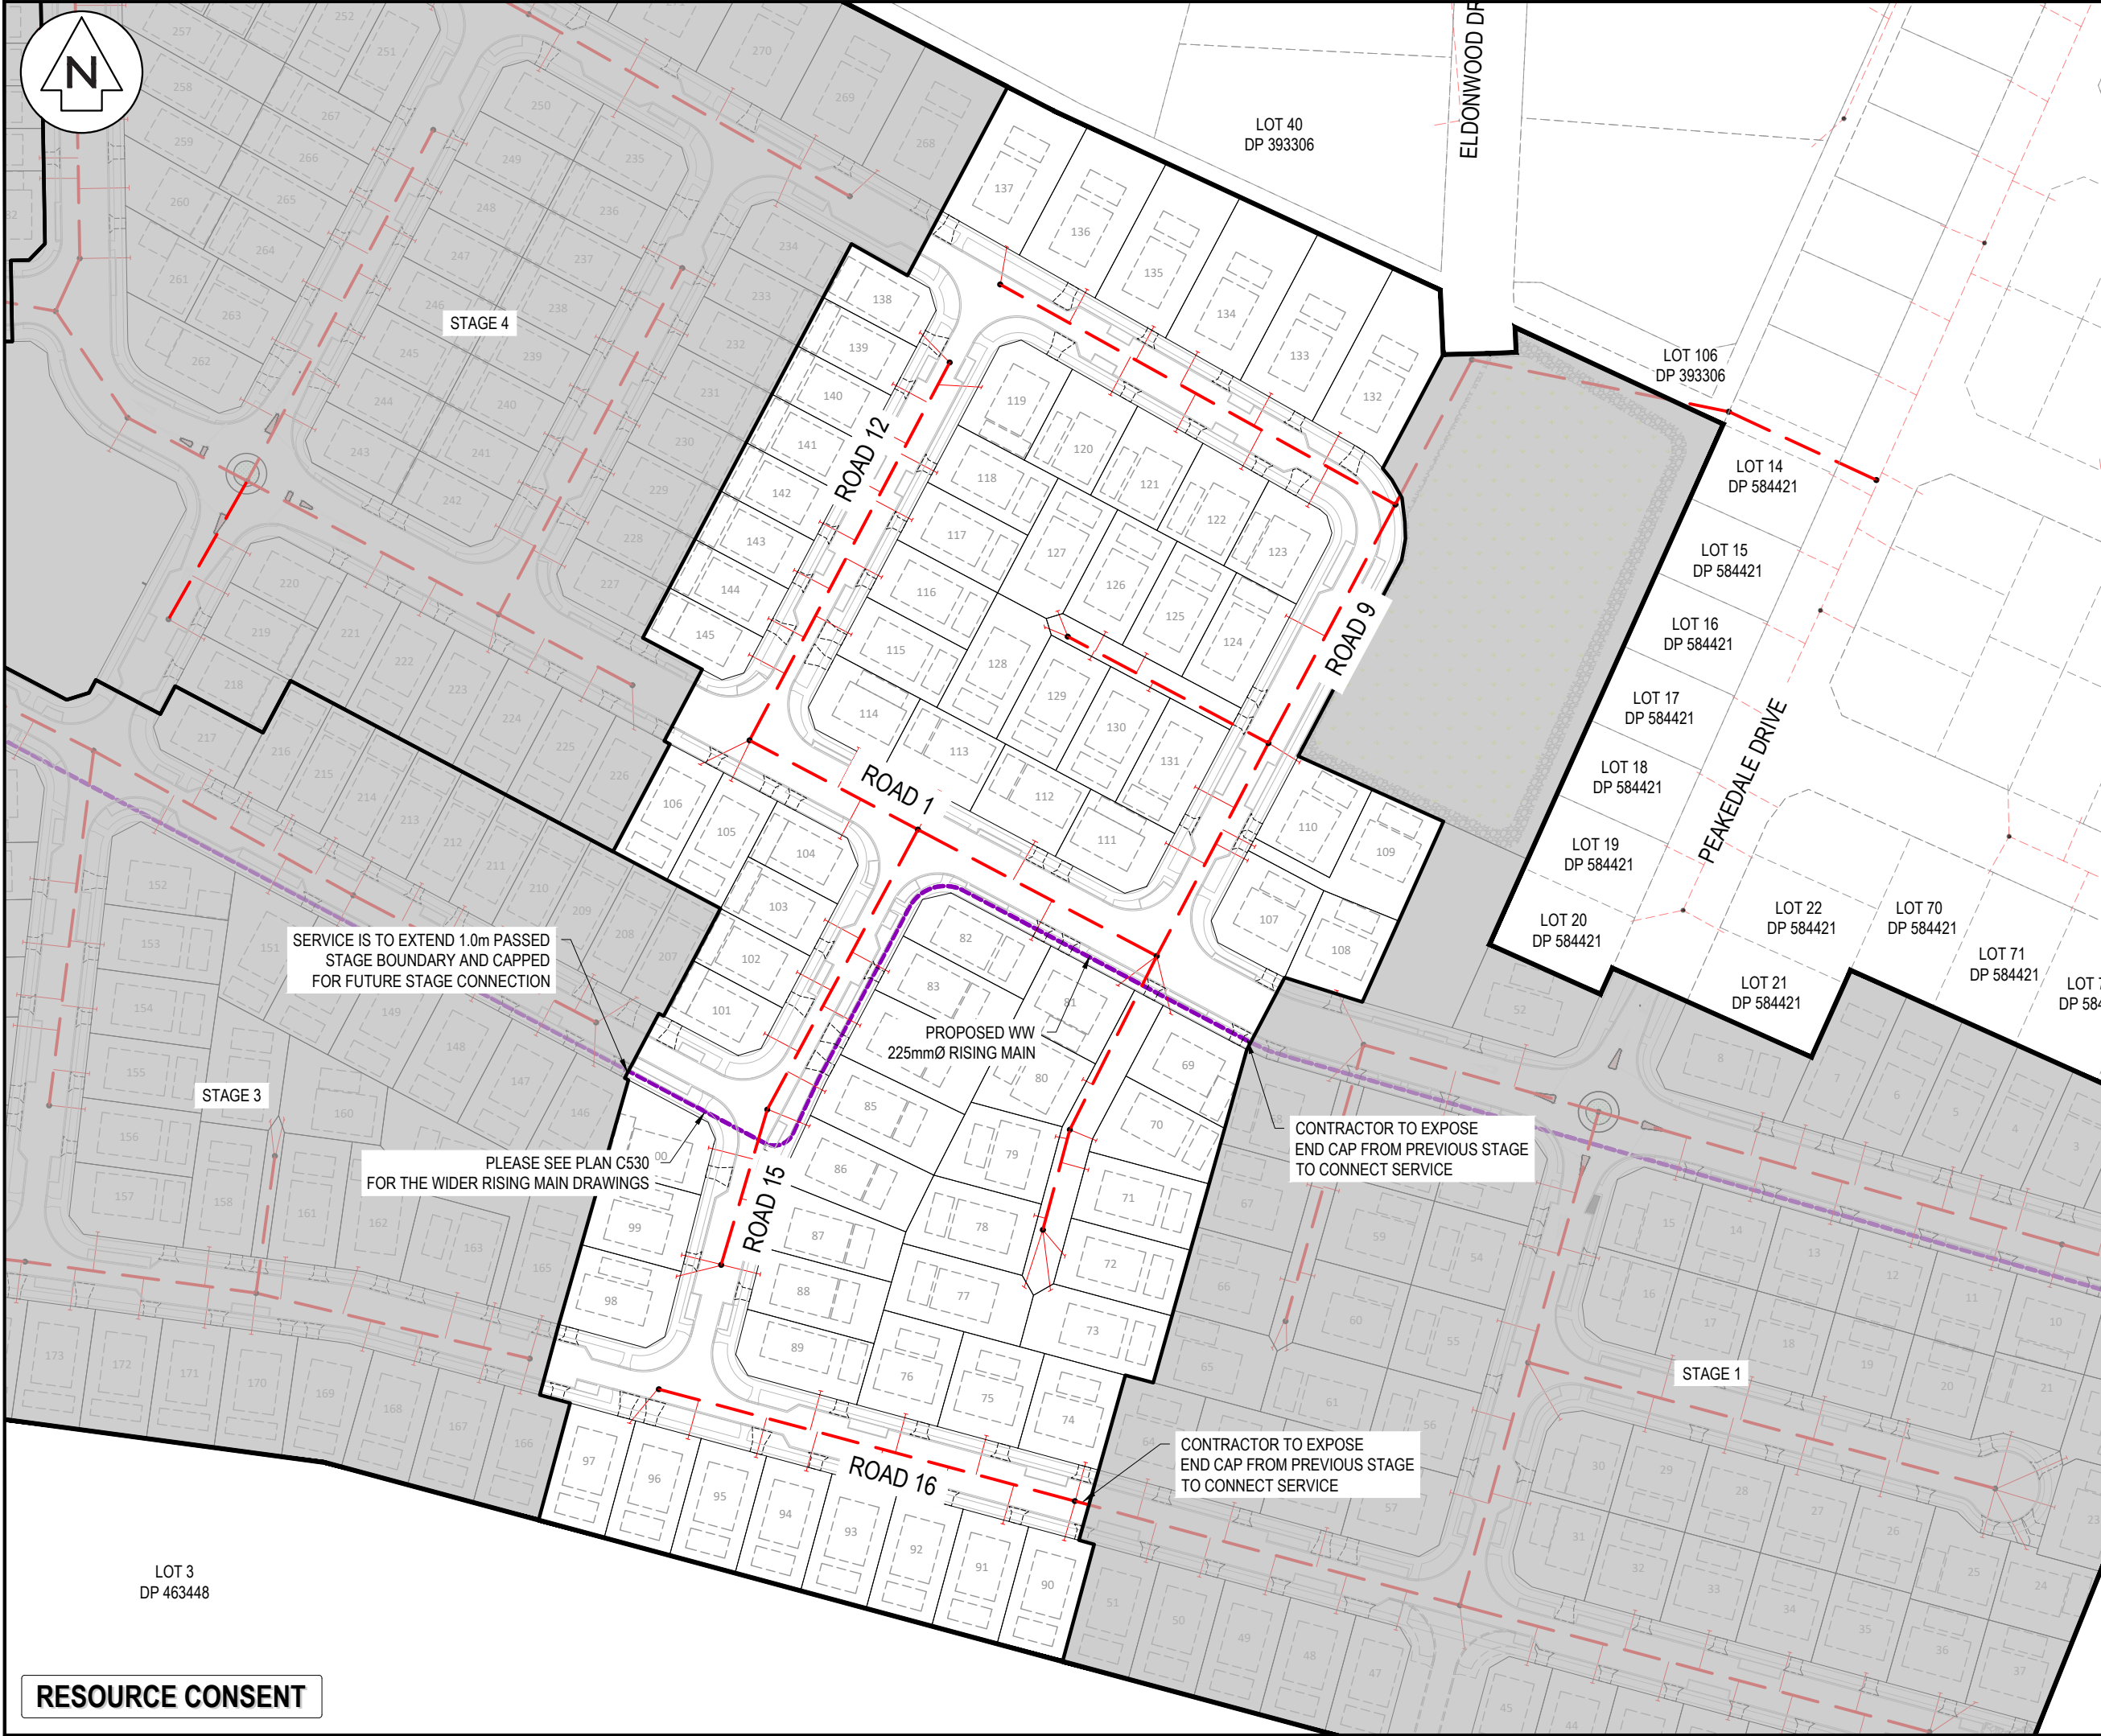

Notes

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Legend

---	EX BOUNDARY
---	PROP BOUNDARY
---	EX WASTEWATER
---	PR WASTEWATER
---	WW RISING MAIN
○	EX/PROP WWMH
+	WW LOT CONNECTION

C	FAST TRACK APP	RJM	11/2025
B	FAST TRACK APP	MKS	06/2025
A	FAST TRACK APP	MKS	05/2025
Rev	Description	By	Date
7		MAVEN	05/2024
	Survey	MKS	04/2025
	Design	MKS	04/2025
	Drawn	DJM	05/2025

**M** **Maven Associates**  
09 571 0050  
info@maven.co.nz  
www.maven.co.nz  
5 Owens Road, Epsom  
Auckland 1023

Project


**ASHBOURNE  
RESIDENTIAL  
FOR  
MATAMATA  
DEVELOPMENTS LTD**

Title

**PROPOSED  
WASTEWATER DRAINAGE  
PLAN STAGE 2**

Project no.	289001		
Scale	1:1500 @ A3		
Cad file	C500-WASTEWATER.DWG		
Drawing no.	C500-12	Rev	<b>C</b>



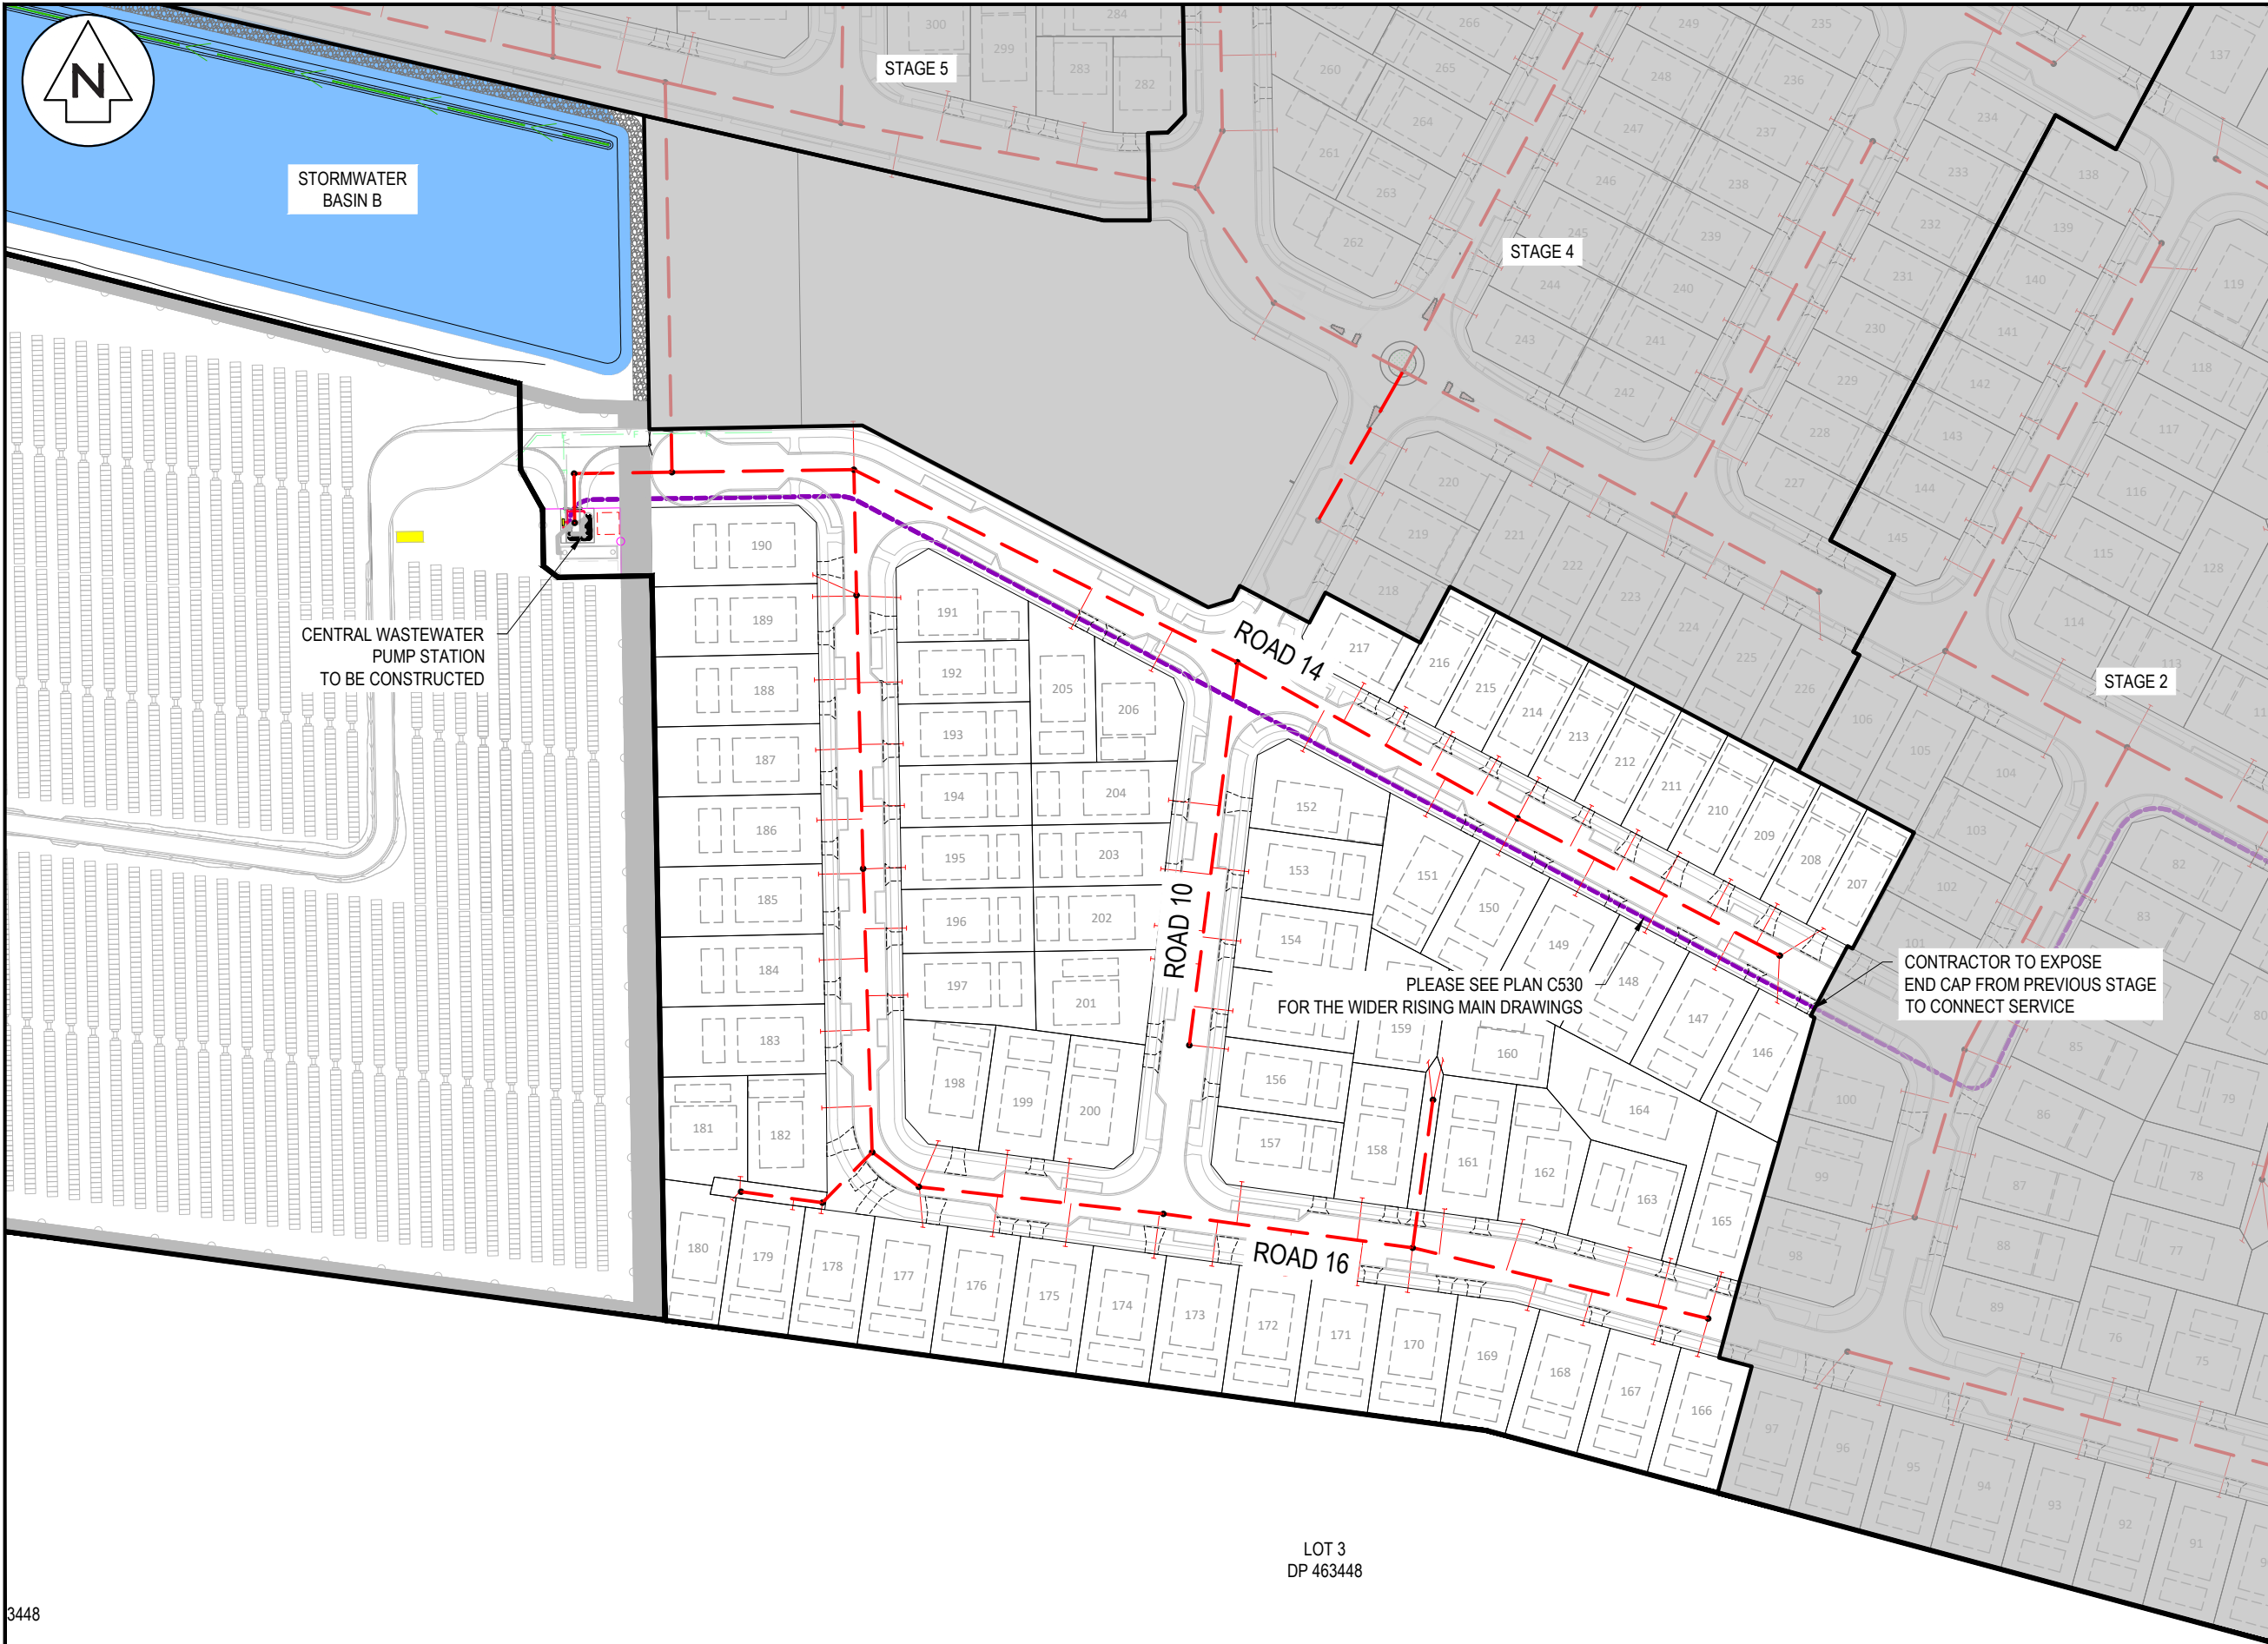

Notes

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Legend

—	EX BOUNDARY
---	PROP BOUNDARY
---	EX WASTEWATER
---	PR WASTEWATER
---	WW RISING MAIN
⊙	EX/PROP WWMH
—+—	WW LOT CONNECTION

C	FAST TRACK APP	RJM	11/2025
B	FAST TRACK APP	MKS	06/2025
A	FAST TRACK APP	MKS	05/2025
Rev	Description	By	Date
		By	Date
Survey	MAVEN		05/2024
Design	MKS		04/2025
Drawn	MKS		04/2025
Checked	DJM		05/2025

**Maven Associates**  
09 571 0050  
info@maven.co.nz  
www.maven.co.nz  
5 Owens Road, Epsom  
Auckland 1023

Project


**ASHBOURNE  
RESIDENTIAL  
FOR  
MATAMATA  
DEVELOPMENTS LTD**

Title

**PROPOSED  
WASTEWATER DRAINAGE  
PLAN STAGE 3**

Project no.	289001		
Scale	1:1500 @ A3		
Cad file	C500-WASTEWATER.DWG		
Drawing no.	C500-13	Rev	<b>C</b>



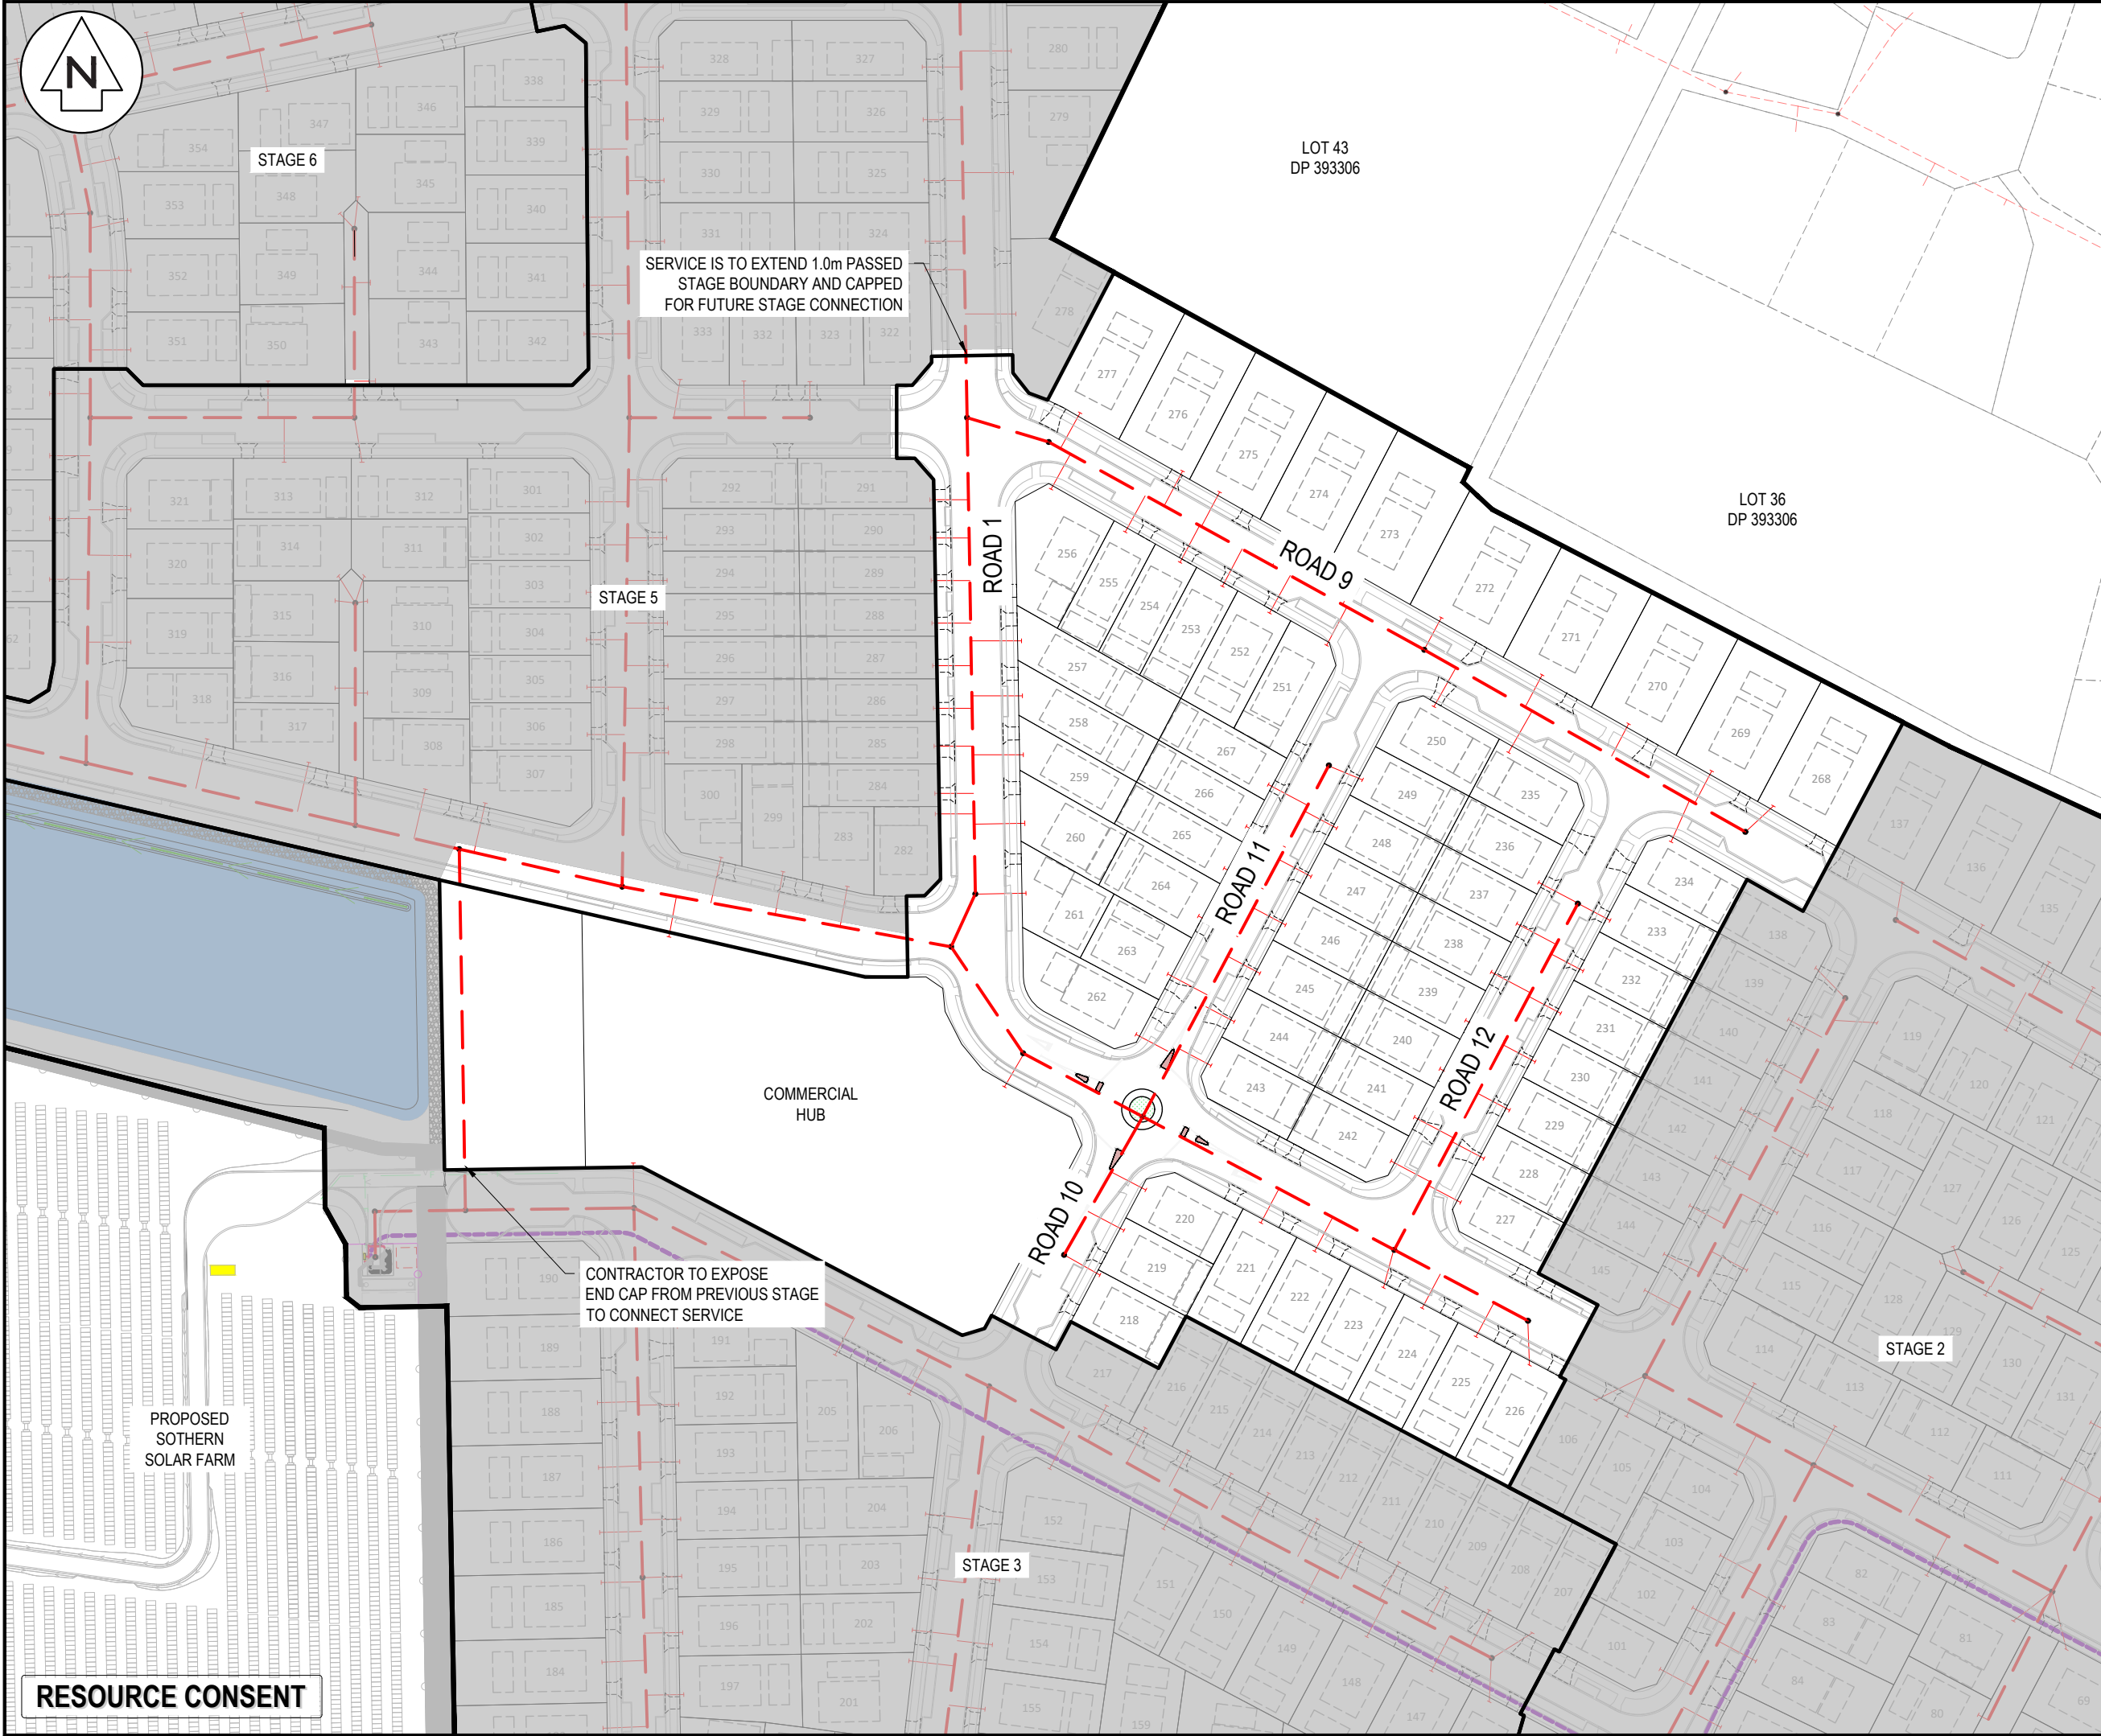

Notes

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Legend

---	EX BOUNDARY
---	PROP BOUNDARY
---	EX WASTEWATER
---	PR WASTEWATER
---	WW RISING MAIN
⊙	EX/PROP WWMH
---	WW LOT CONNECTION

C	FAST TRACK APP	RJM	11/2025
B	FAST TRACK APP	MKS	06/2025
A	FAST TRACK APP	MKS	05/2025
Rev	Description	By	Date
		By	Date
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Design	MKS		04/2025
Drawn	MKS		04/2025
Checked	DJM		05/2025

**Maven Associates**  
09 571 0050  
info@maven.co.nz  
www.maven.co.nz  
5 Owens Road, Epsom  
Auckland 1023

Project

**ASHBOURNE  
RESIDENTIAL  
FOR  
MATAMATA  
DEVELOPMENTS LTD**

Title

**PROPOSED  
WASTEWATER DRAINAGE  
PLAN STAGE 4**

Project no.	289001		
Scale	1:1500 @ A3		
Cad file	C500-WASTEWATER.DWG		
Drawing no.	C500-14	Rev	<b>C</b>





HIGHGROVE AVENUE

CHESTNUT LANE

LOT 16  
DP 562902

LOT 17  
DP 562902

LOT 18  
DP 562902

LOT 47  
DP 393306

LOT 43  
DP 393306

STAGE 7

STAGE 6

ROAD 5

ROAD 1

ROAD 9

ROAD 6

ROAD 4

ROAD 7

STAGE 4

SERVICE IS TO EXTEND 1.0m PASSED  
STAGE BOUNDARY AND CAPPED  
FOR FUTURE STAGE CONNECTION

PROPOSED WW  
140mmØ RISING MAIN

SERVICE IS TO EXTEND 1.0m PASSED  
STAGE BOUNDARY AND CAPPED  
FOR FUTURE STAGE CONNECTION

SERVICE IS TO EXTEND 1.0m PASSED  
STAGE BOUNDARY AND CAPPED  
FOR FUTURE STAGE CONNECTION

CONTRACTOR TO EXPOSE  
END CAP FROM PREVIOUS STAGE  
TO CONNECT SERVICE

WASTEWATER PIPE  
TO BE CONNECTED  
TO STAGE 4

- Notes
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Legend

- EX BOUNDARY
- PROP BOUNDARY
- EX WASTEWATER
- PR WASTEWATER
- WW RISING MAIN
- EX/PROP WWMH
- WW LOT CONNECTION

C	FAST TRACK APP	RJM	11/2025
B	FAST TRACK APP	MKS	06/2025
A	FAST TRACK APP	MKS	05/2025
Rev	Description	By	Date
Survey	MAVEN		05/2024
Design	MKS		04/2025
Drawn	MKS		04/2025
Checked	DJM		05/2025

**M** Maven Associates  
09 571 0050  
info@maven.co.nz  
www.maven.co.nz  
5 Owens Road, Epsom  
Auckland 1023

Project  
**ASHBOURNE  
RESIDENTIAL  
FOR  
MATAMATA  
DEVELOPMENTS LTD**

Title  
**PROPOSED  
WASTEWATER DRAINAGE  
PLAN STAGE 5**

Project no.	289001
Scale	1:1500 @ A3
Cad file	C500-WASTEWATER.DWG
Drawing no.	C500-15
Rev	C

RESOURCE CONSENT

DATE: 11/11/25 FILEPATH: F:\MAVEN\HAMITON6 PROJECTS\289001 - STATION ROAD\DRAWING\11 ASHBORNE RESIDENTIAL\500 WASTEWATER.DWG





HIGHROVE AVENUE

LOT 16  
DP 562902

LOT 17  
DP 562902

LOT 18  
DP 562902

LOT 2  
DP 21055

ROAD 5

ROAD 6

ROAD 5

ROAD 7

STAGE 7

STAGE 5

STAGE 4

CONTRACTOR TO EXPOSE  
END CAP FROM PREVIOUS STAGE  
TO CONNECT SERVICE

CONTRACTOR TO EXPOSE  
END CAP FROM PREVIOUS STAGE  
TO CONNECT SERVICE

#### Notes

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- PROP BOUNDARY
- EX WASTEWATER
- PR WASTEWATER
- WW RISING MAIN
- EX/PROP WWMH
- WW LOT CONNECTION

C	FAST TRACK APP	RJM	11/2025
B	FAST TRACK APP	MKS	06/2025
A	FAST TRACK APP	MKS	05/2025
Rev	Description	By	Date
Survey	MAVEN		05/2024
Design	MKS		04/2025
Drawn	MKS		04/2025
Checked	DJM		05/2025




Project  
**ASHBOURNE  
RESIDENTIAL  
FOR  
MATAMATA  
DEVELOPMENTS LTD**

Title  
**PROPOSED  
WASTEWATER DRAINAGE  
PLAN STAGE 6**

Project no.	289001		
Scale	1:1500 @ A3		
Cad file	C500-WASTEWATER.DWG		
Drawing no.	C500-16	Rev	C

RESOURCE CONSENT

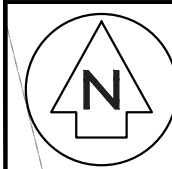

OLIVE PLACE

LOT 9  
DP 562902

LOT 13  
DP 562902

LOT 14  
DP 562902

LOT 16  
DP 562902

LOT 17  
DP 562902

LOT 18  
DP 562902

LOT 3  
DP 404835

STORMWATER  
BASIN C

SERVICE IS TO EXTEND 1.0m PASSED  
STAGE BOUNDARY AND CAPPED  
FOR FUTURE STAGE CONNECTION

STAGE 8

PROPOSED WW  
140mmØ RISING MAIN

PLEASE SEE PLAN C530  
FOR THE WIDER RISING MAIN DRAWINGS

ROAD 2

ROAD 4

ROAD 1

LOT 28  
DP 386534

LOT 44  
DP 386534

CHESTNUT LANE

LOT 47  
DP 393306

CONTRACTOR TO EXPOSE  
END CAP FROM PREVIOUS STAGE  
TO CONNECT SERVICE

STAGE 6

STAGE 5

RESOURCE CONSENT

#### Notes

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#### Legend

- EX BOUNDARY
- PROP BOUNDARY
- EX WASTEWATER
- PR WASTEWATER
- WW RISING MAIN
- EX/PROP WWMH
- WW LOT CONNECTION

C	FAST TRACK APP	RJM	11/2025
B	FAST TRACK APP	MKS	06/2025
A	FAST TRACK APP	MKS	05/2025
Rev	Description	By	Date
Survey	MAVEN		05/2024
Design	MKS		04/2025
Drawn	MKS		04/2025
Checked	DJM		05/2025

**M** Maven Associates  
09 571 0050  
info@maven.co.nz  
www.maven.co.nz  
5 Owens Road, Epsom  
Auckland 1023

Project  
**ASHBOURNE  
RESIDENTIAL  
FOR  
MATAMATA  
DEVELOPMENTS LTD**

Title  
**PROPOSED  
WASTEWATER DRAINAGE  
PLAN STAGE 7**


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Scale	1:1500 @ A3		
Cad file	C500-WASTEWATER.DWG		
Drawing no.	C500-17		





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RESOURCE CONSENT  
DP 562902

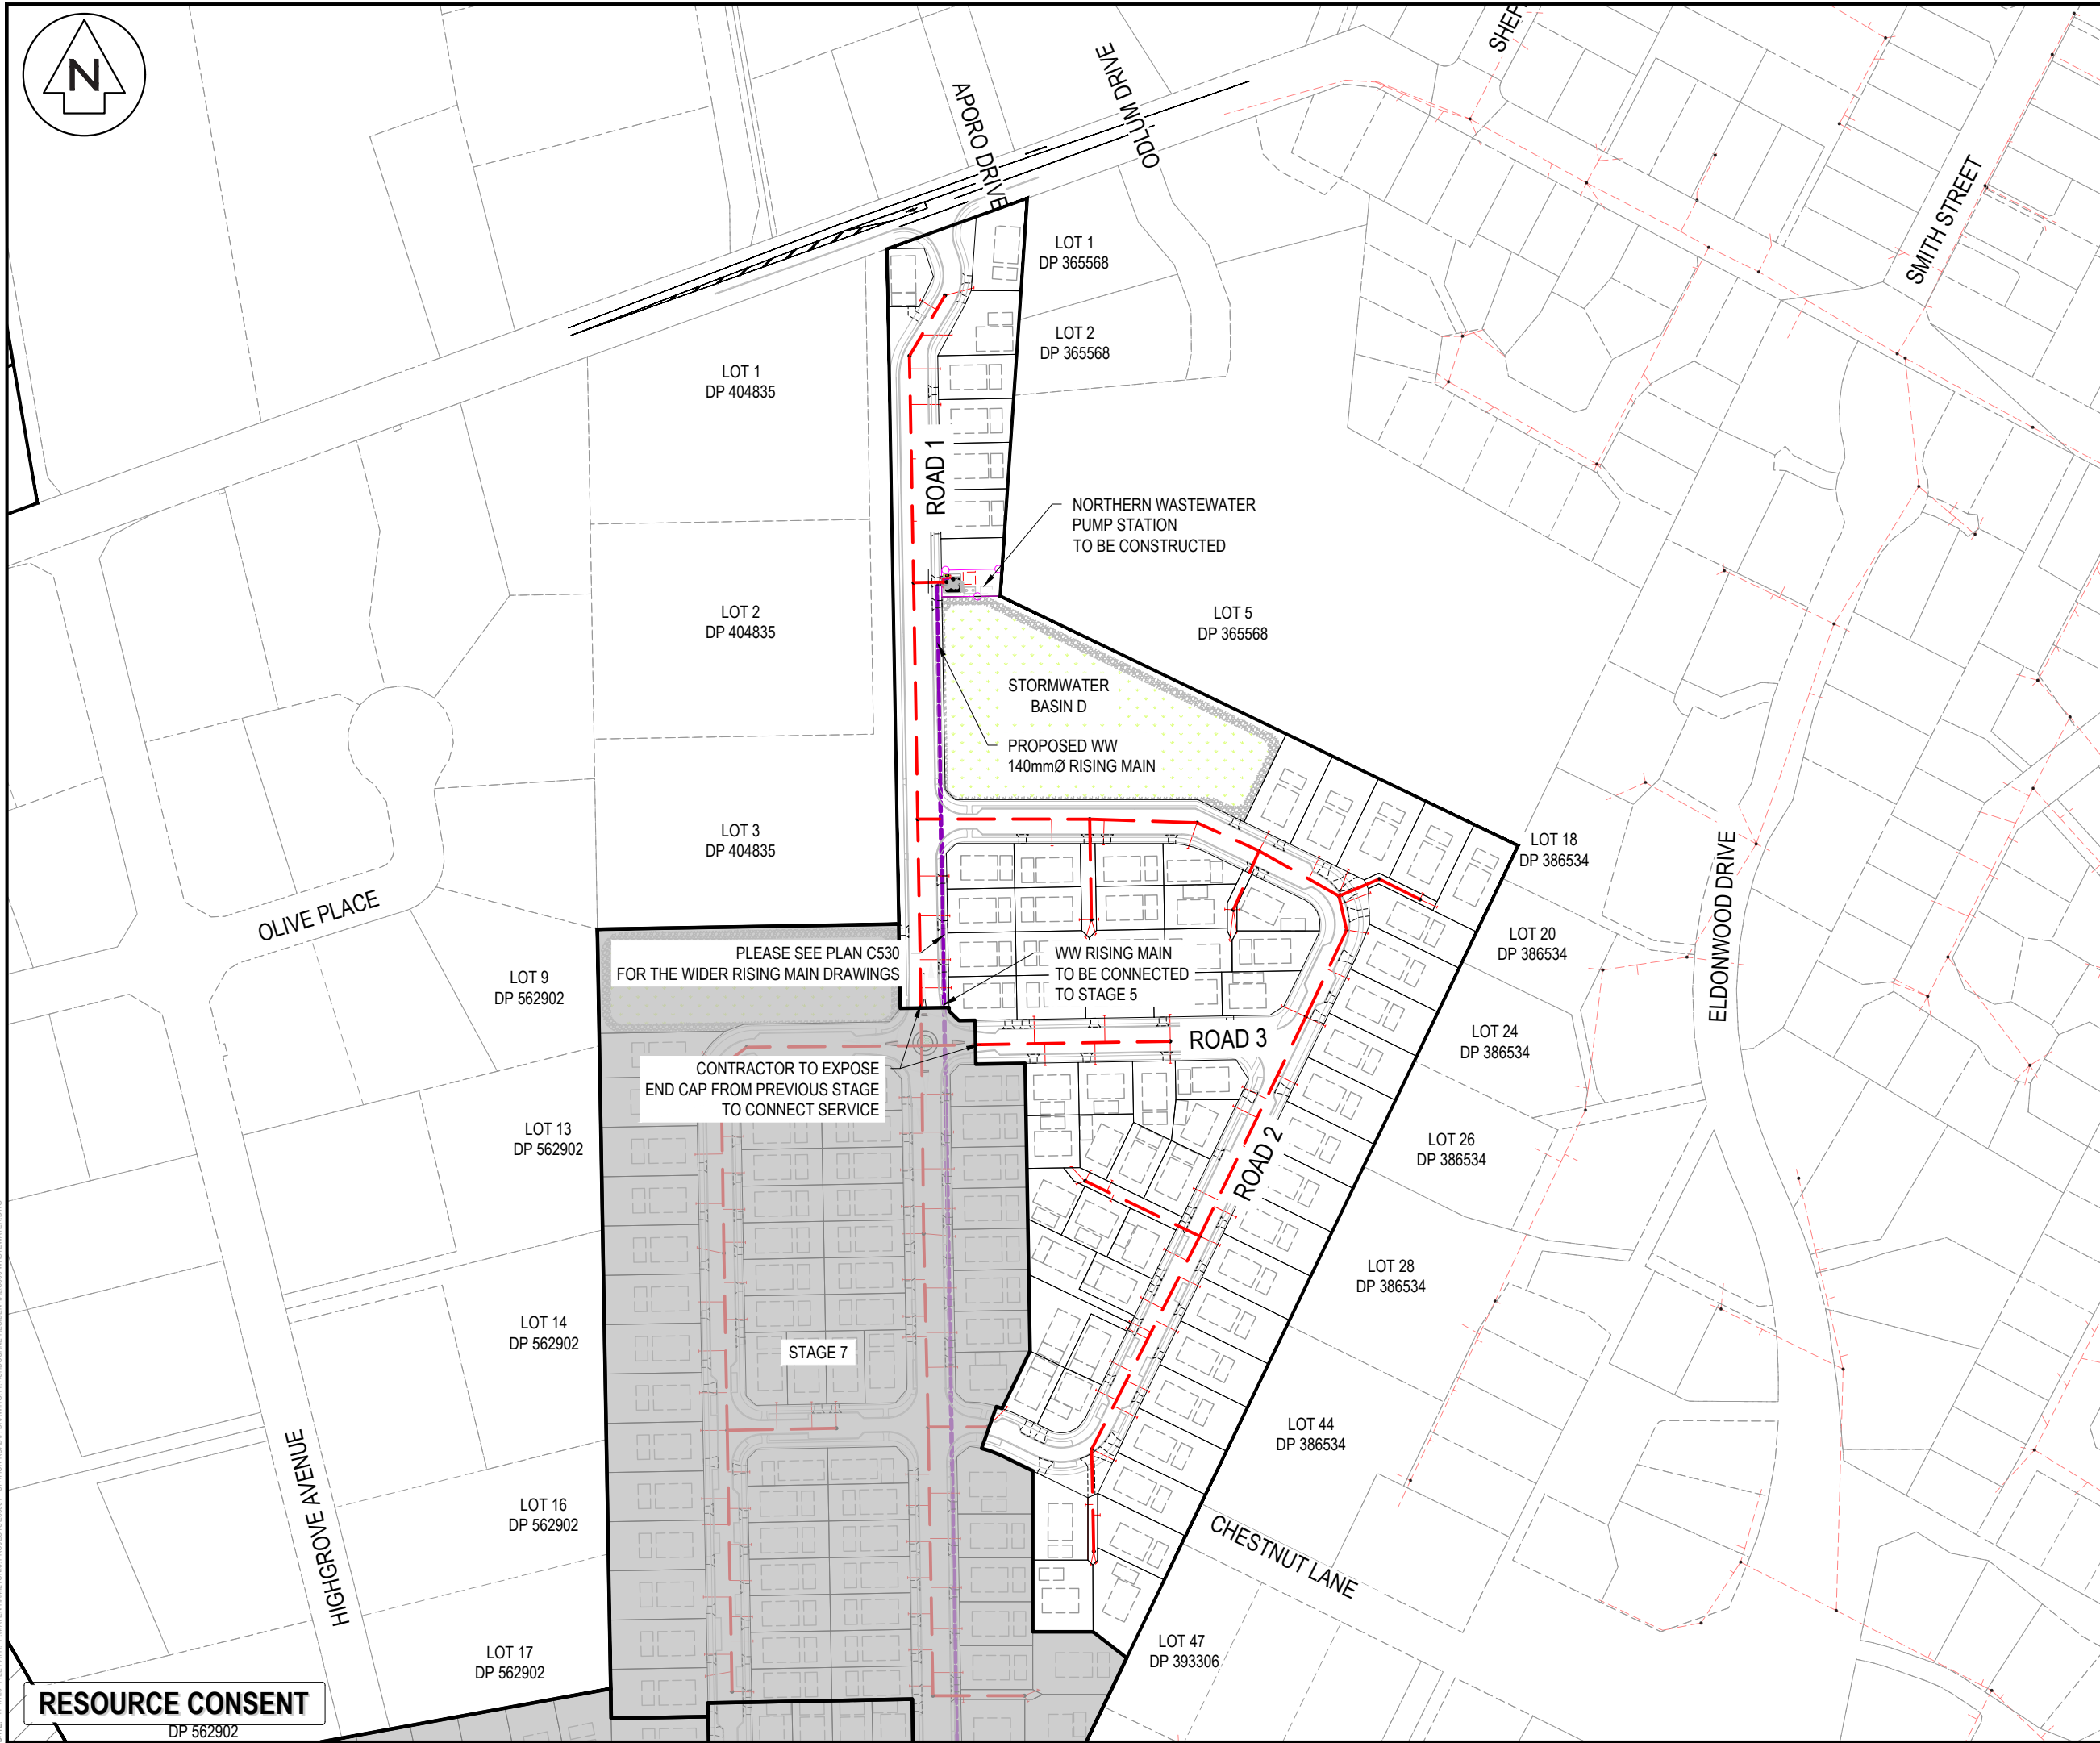

Notes

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Legend

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---	PROP BOUNDARY
---	EX WASTEWATER
---	PR WASTEWATER
---	WW RISING MAIN
○	EX/PROP WWMH
+	WW LOT CONNECTION

C	FAST TRACK APP	RJM	11/2025
B	FAST TRACK APP	MKS	06/2025
A	FAST TRACK APP	MKS	05/2025
Rev	Description	By	Date
Survey	MAVEN		05/2024
Design	MKS		04/2025
Drawn	MKS		04/2025
Checked	DJM		05/2025


**M** Maven Associates  
09 571 0050  
info@maven.co.nz  
www.maven.co.nz  
5 Owens Road, Epsom  
Auckland 1023

Project  
**ASHBOURNE  
RESIDENTIAL  
FOR  
MATAMATA  
DEVELOPMENTS LTD**

Title  
**PROPOSED  
WASTEWATER DRAINAGE  
PLAN STAGE 8**

Project no.	289001		
Scale	1:2500 @ A3		
Cad file	C500-WASTEWATER.DWG		
Drawing no.	C500-18	Rev	<b>C</b>

DATE: 11/11/25 FILEPATH: F:\MAVEN\HAMITONG PROJECTS\289001 - STATION ROAD.DWG11.ASHBOURNE RESIDENTIAL\CS500\WASTEWATER.DWG

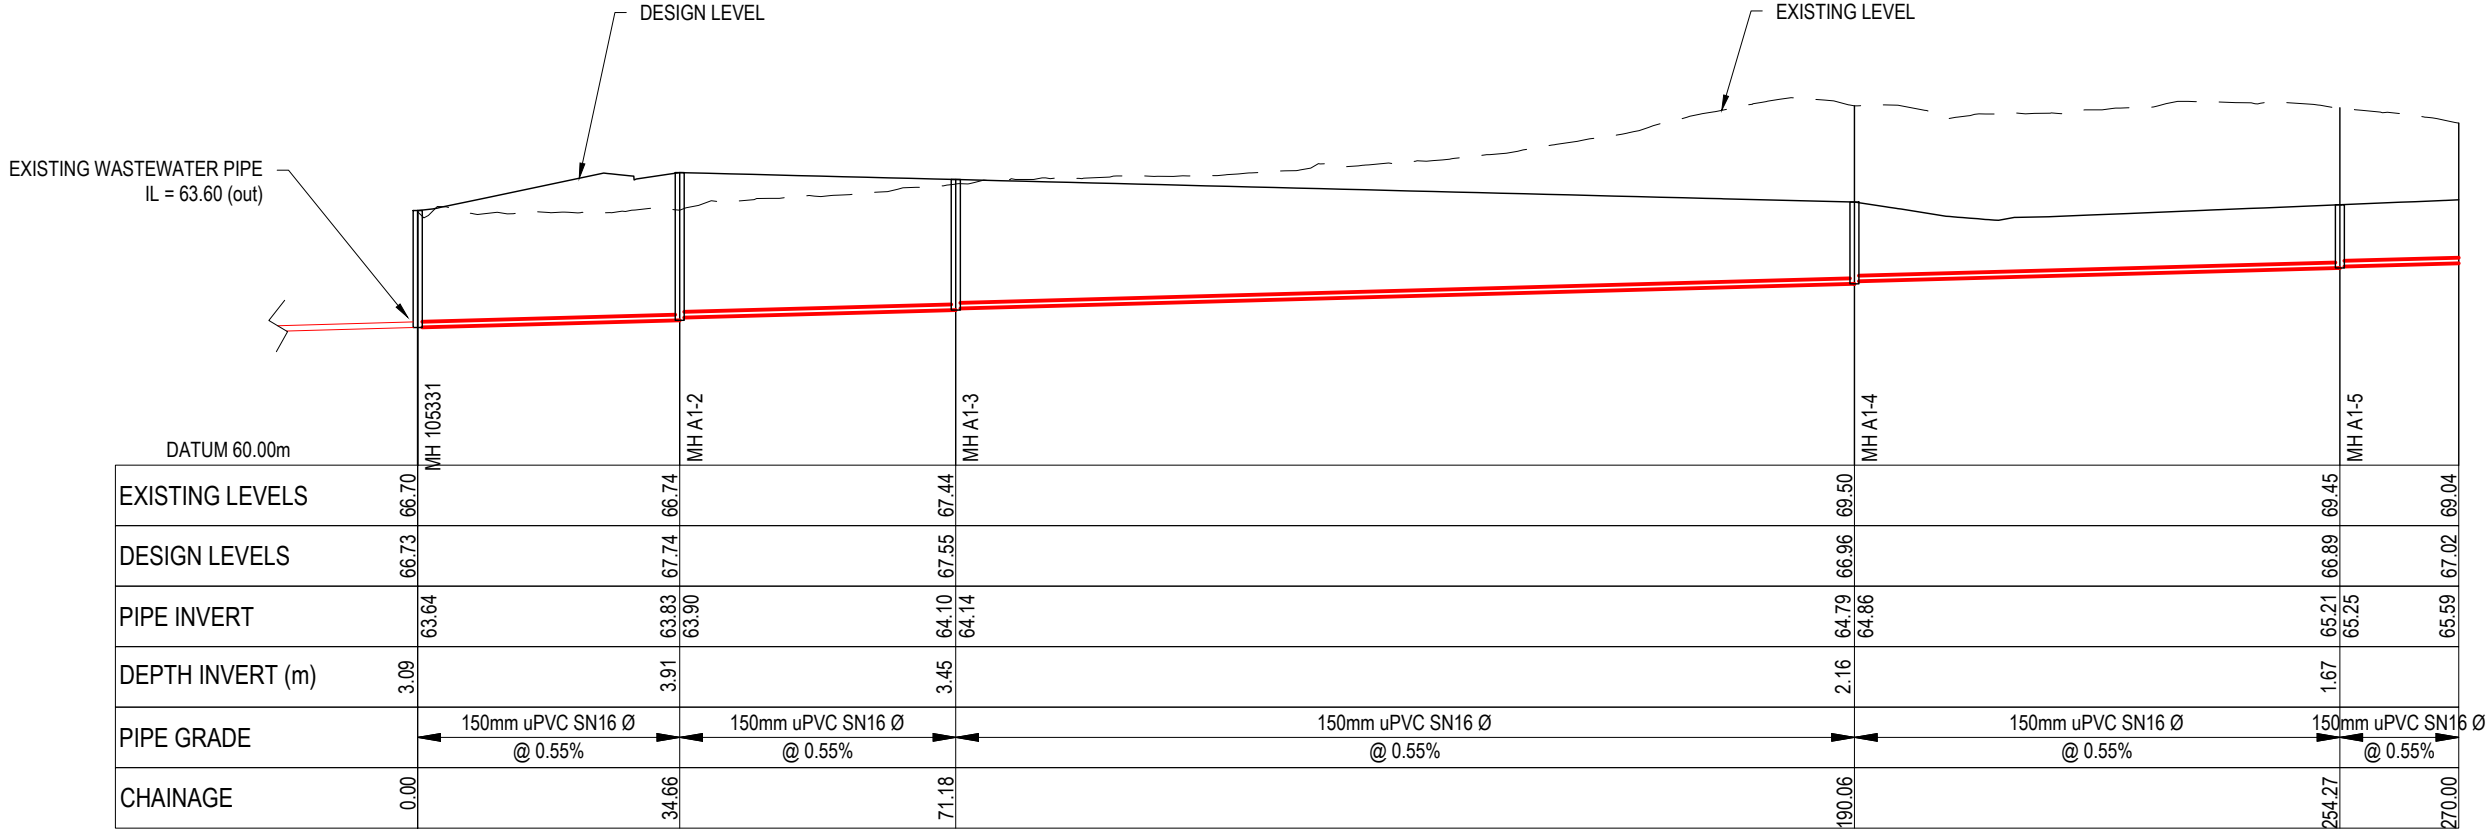

LONGSECTION - CATCHMENT A1 - LINE 1  
SCALE 1:1000 HORI & 1:200 VERTICAL @ A3

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Legend

EX GROUND LEVEL

PROP GROUND LEVEL

D	FAST TRACK APP	RJM	11/2025
C	FAST TRACK APP	MKS	05/2025
B	FAST TRACK APP	RJM	04/2025
A	FAST TRACK APP	MKS	04/2025
Rev	Description	By	Date
		By	Date
Survey	MAVEN		05/2024
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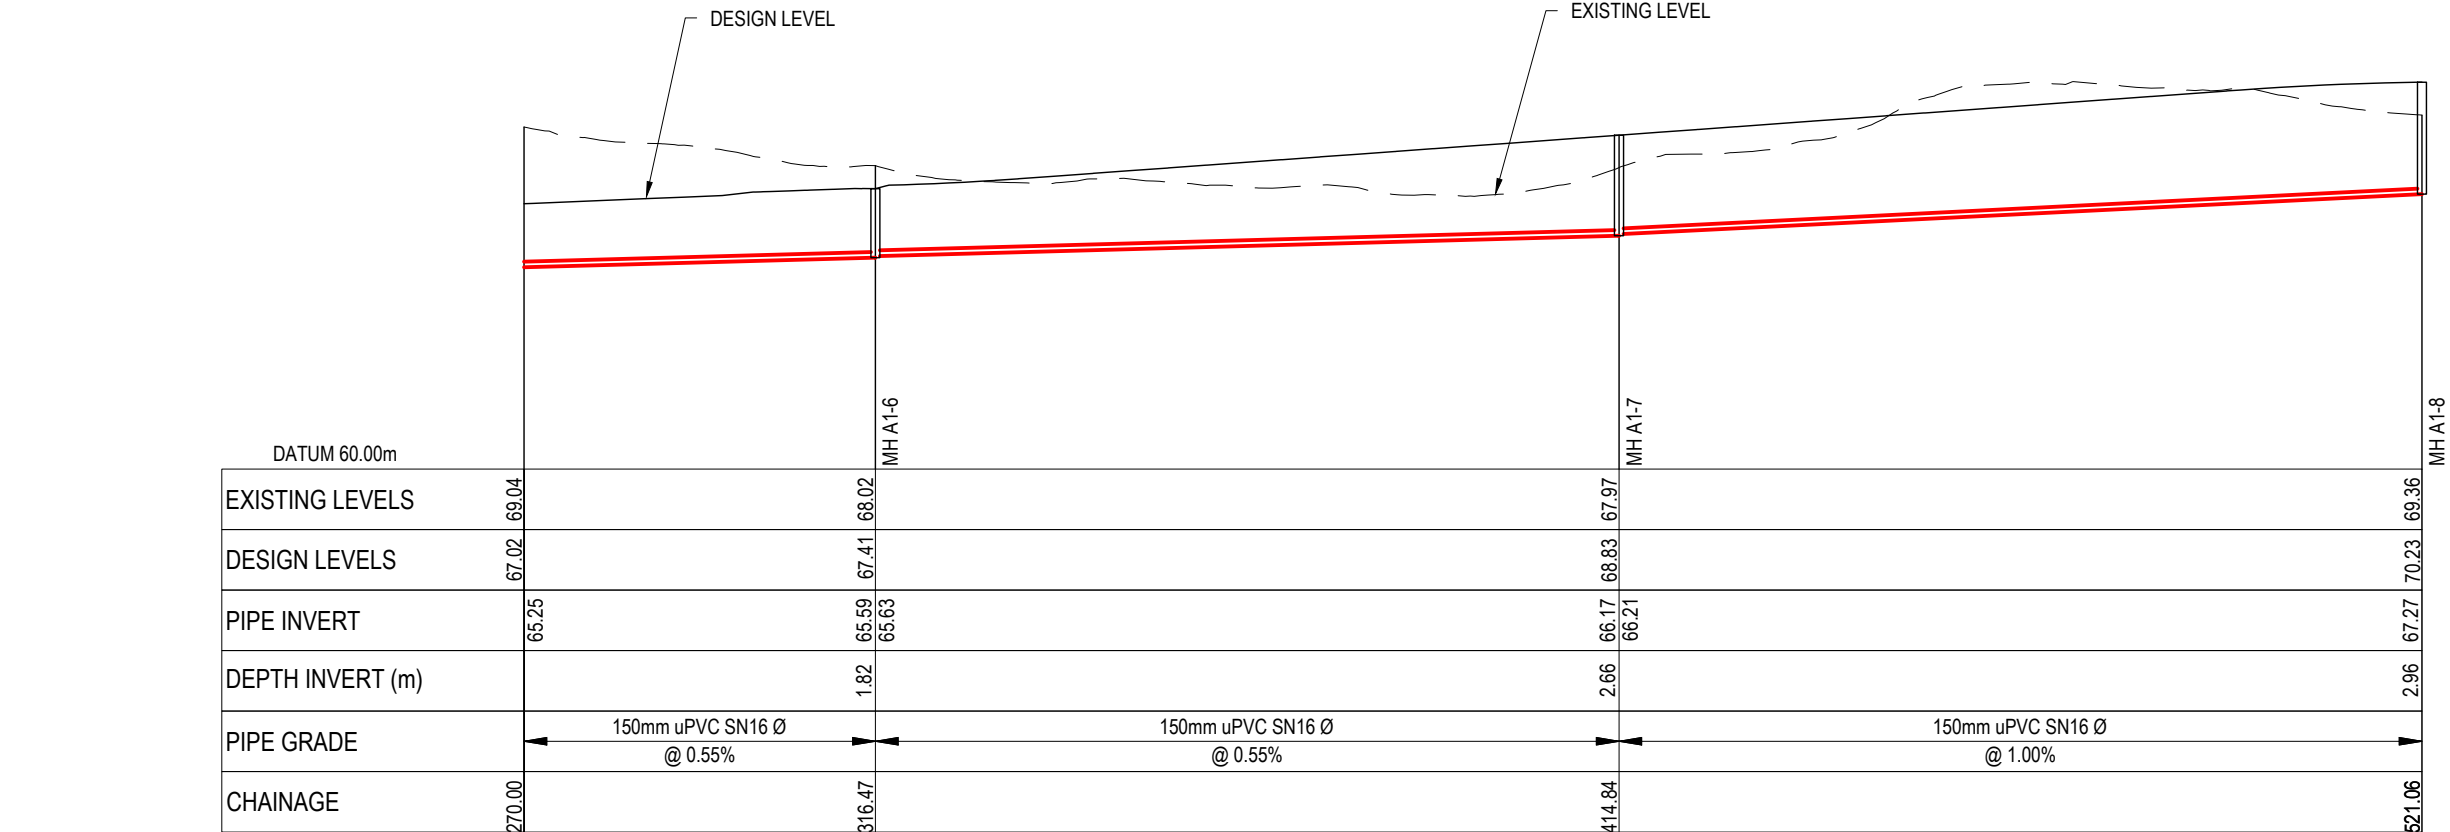
Project

**ASHBOURNE  
RESIDENTIAL  
FOR  
MATAMATA  
DEVELOPMENTS LTD**

Title

**PROPOSED  
WASTEWATER  
LONGSECTIONS**

Project no.	289001		
Scale	AS SHOWN		
Cad file	C500-WASTEWATER.DWG		
Drawing no.	C520-1	Rev	D




LONGSECTION - CATCHMENT A1 - LINE 1 CONT.  
SCALE 1:1000 HORI & 1:200 VERTICAL @ A3

RESOURCE CONSENT




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RESOURCE CONSENT

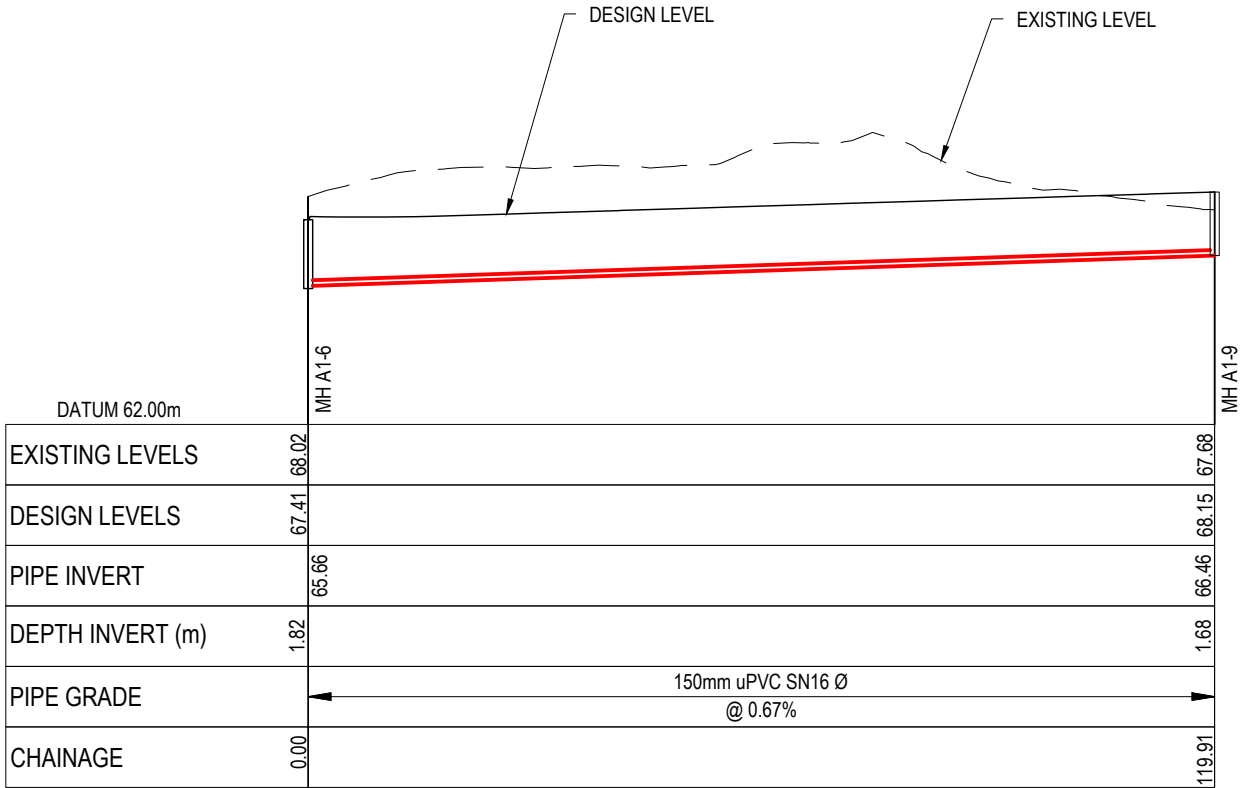

LONGSECTION - CATCHMENT A1 - LINE 2  
SCALE 1:1000 HORI & 1:200 VERTICAL @ A3

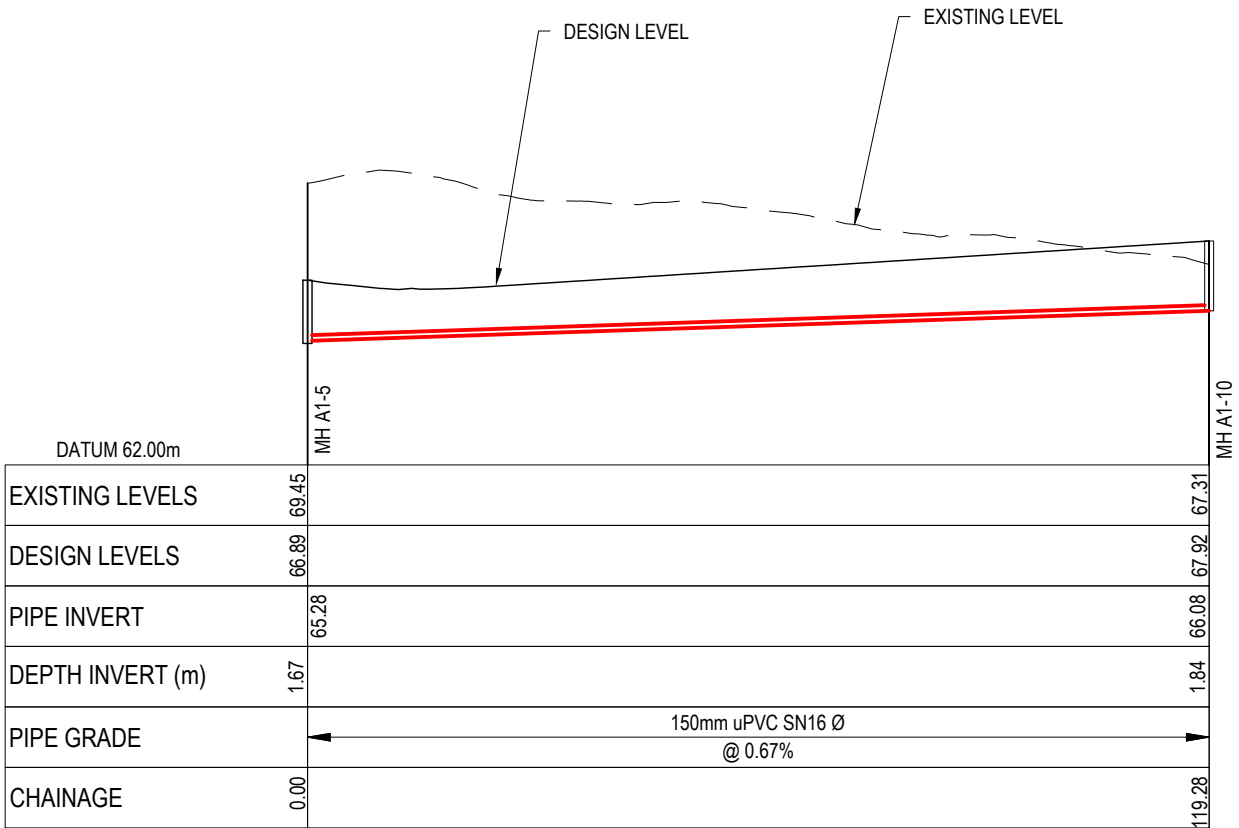

LONGSECTION - CATCHMENT A1 - LINE 3  
SCALE 1:1000 HORI & 1:200 VERTICAL @ A3

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- Legend
- EX GROUND LEVEL  
PROP GROUND LEVEL


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C	FAST TRACK APP	MKS	05/2025
B	FAST TRACK APP	RJM	04/2025
A	FAST TRACK APP	MKS	04/2025
Rev	Description	By	Date
		By	Date
Survey	MAVEN		05/2024
Design	MKS		04/2025
Drawn	MKS		04/2025
Checked	DJM		05/2025

**M** **Maven Associates**  
09 571 0050  
info@maven.co.nz  
www.maven.co.nz  
5 Owens Road, Epsom  
Auckland 1023

Project  
**ASHBOURNE  
RESIDENTIAL  
FOR  
MATAMATA  
DEVELOPMENTS LTD**

Title  
**PROPOSED  
WASTEWATER  
LONGSECTIONS**

Project no.	289001		
Scale	AS SHOWN		
Cad file	C500-WASTEWATER.DWG		
Drawing no.	C520-2	Rev	<b>D</b>

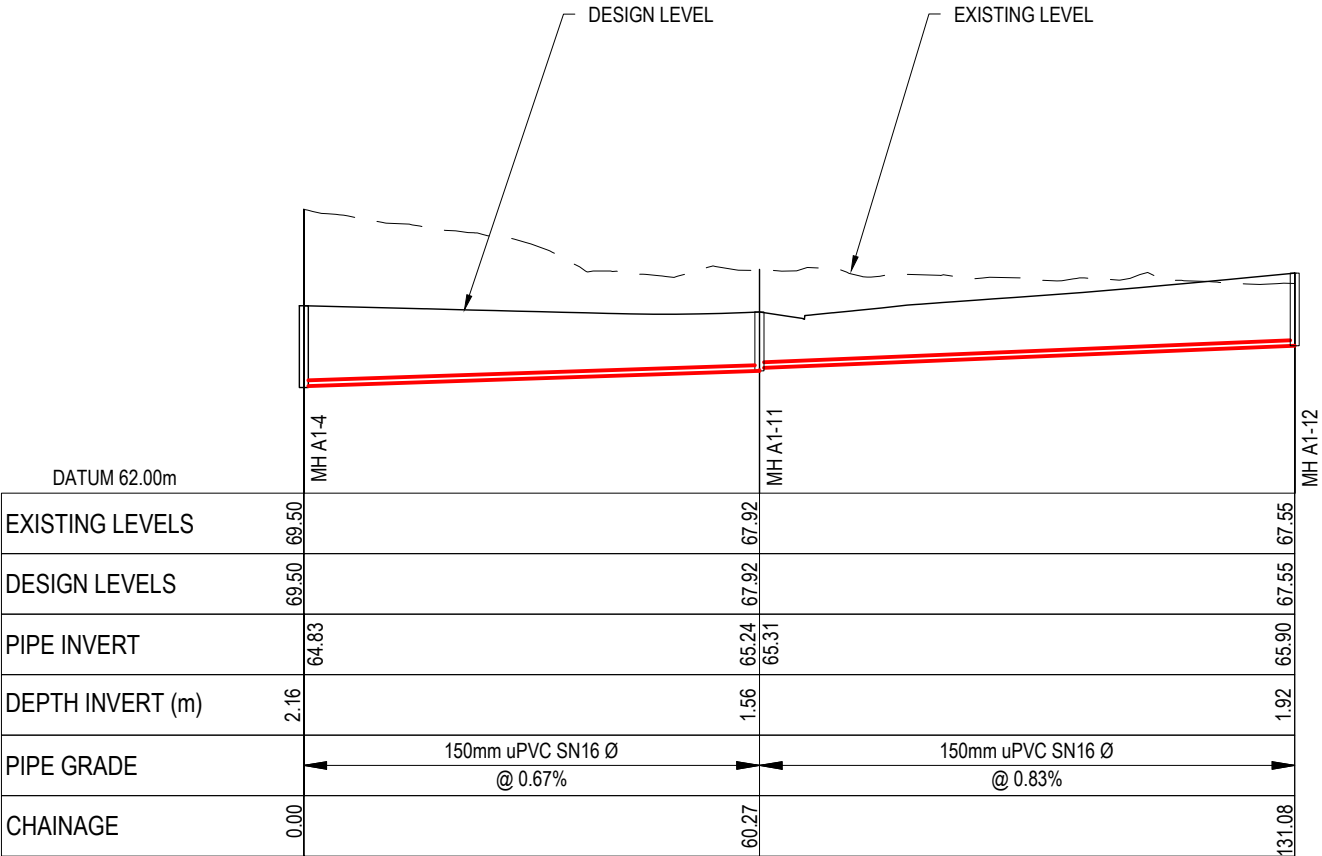

LONGSECTION - CATCHMENT A1 - LINE 4  
SCALE 1:1000 HORI & 1:200 VERTICAL @ A3

- Notes
1. All works to be in accordance with Waikato Regional Infrastructure Technical Specifications.
  2. Co-ordinates in terms of NZ Geodetic Datum Mount Eden 2000.
  3. Levels in terms of the New Zealand Vertical Datum 2016.
  4. It is the Contractors responsibility to locate all services that may be affected by his operations.
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  7. All lines are to be 150mmØ PVC Class SN16 unless shown otherwise.
  8. All lot connections are to be 100mmØ PVC unless shown otherwise.
  9. 150mmØ pipes that do not terminate in a manhole must be terminated with a 100mmØ on a 150mmØ london junction and blank cap.
  10. Manhole diameters shown on structure label are internal diameter.
  11. Measurements shown on the lot connections are the distance from the centre of the downstream manhole to the lot connection position within the lot boundary.
  12. Manhole slab and cover to be rotated to avoid the footpath edge for manholes on footpath.
  13. Pipe lengths shown on plan are from upstream pipe invert to downstream pipe invert.

Legend

EX GROUND LEVEL

PROP GROUND LEVEL

D	FAST TRACK APP	RJM	11/2025
C	FAST TRACK APP	MKS	05/2025
B	FAST TRACK APP	RJM	04/2025
A	FAST TRACK APP	MKS	04/2025
Rev	Description	By	Date
	By	Date	
Survey	MAVEN	05/2024	
Design	MKS	04/2025	
Drawn	MKS	04/2025	
Checked	DJM	05/2025	

M

MAVEN

**Maven Associates**  
09 571 0050  
info@maven.co.nz  
www.maven.co.nz  
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Auckland 1023

Project

**ASHBOURNE  
RESIDENTIAL  
FOR  
MATAMATA  
DEVELOPMENTS LTD**

Title


**PROPOSED  
WASTEWATER  
LONGSECTIONS**

Project no.	289001		
Scale	AS SHOWN		
Cad file	C500-WASTEWATER.DWG		
Drawing no.	C520-3	Rev	D

RESOURCE CONSENT



DATE: 11/11/25 FILEPATH: F:\MAVEN\HAMITONG PROJECTS\289001 - STATION ROAD\ DRAWING\11. ASHBOURNE RESIDENTIAL\C500\WASTEWATER.DWG

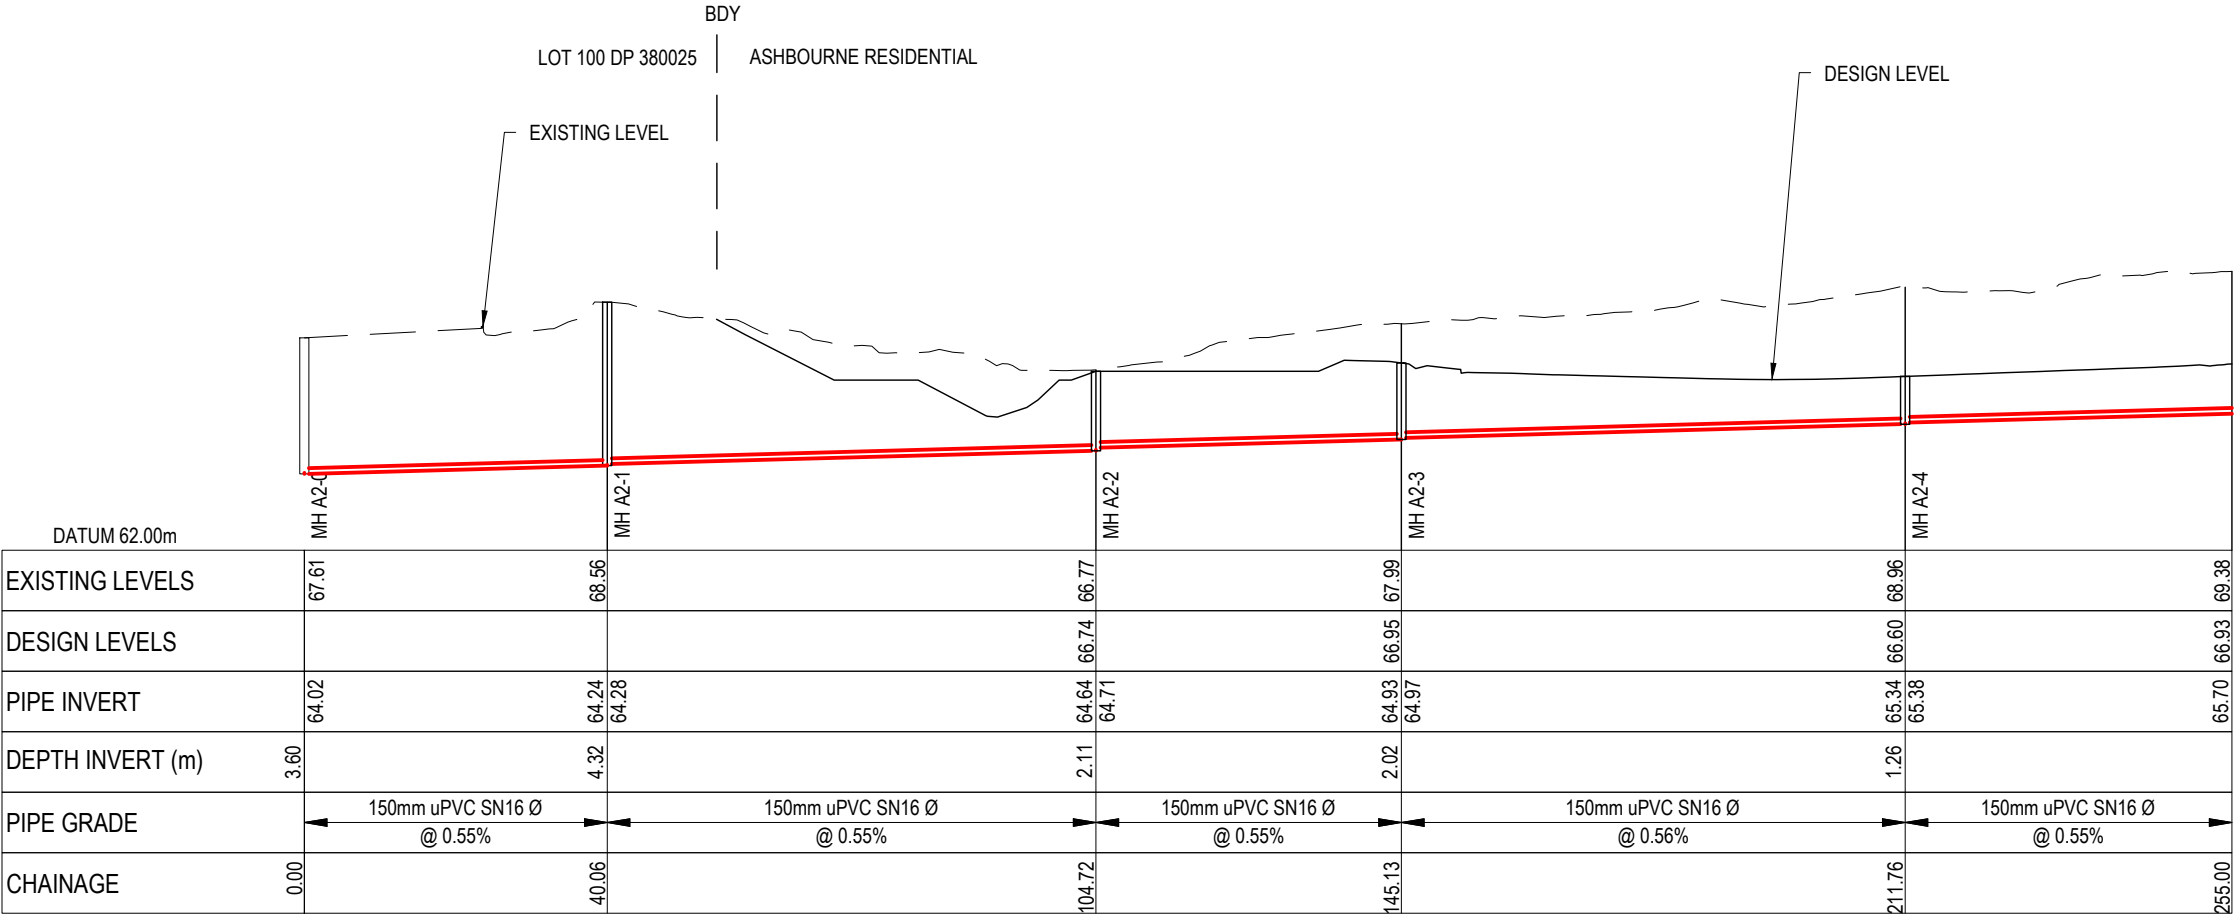

LONGSECTION - CATCHMENT A2 - LINE 5  
SCALE 1:1000 HORI & 1:200 VERTICAL @ A3

- Notes
1. All works to be in accordance with Waikato Regional Infrastructure Technical Specifications.
  2. Co-ordinates in terms of NZ Geodetic Datum Mount Eden 2000.
  3. Levels in terms of the New Zealand Vertical Datum 2016.
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  12. Manhole slab and cover to be rotated to avoid the footpath edge for manholes on footpath.
  13. Pipe lengths shown on plan are from upstream pipe invert to downstream pipe invert.

Legend

EX GROUND LEVEL

PROP GROUND LEVEL

D	FAST TRACK APP	RJM	11/2025
C	FAST TRACK APP	MKS	05/2025
B	FAST TRACK APP	RJM	04/2025
A	FAST TRACK APP	MKS	04/2025
Rev	Description	By	Date
		By	Date
Survey	MAVEN		05/2024
Design	MKS		04/2025
Drawn	MKS		04/2025
Checked	DJM		05/2025



Project

**ASHBOURNE  
RESIDENTIAL  
FOR  
MATAMATA  
DEVELOPMENTS LTD**


Title

**PROPOSED  
WASTEWATER  
LONGSECTIONS**

Project no.	289001		
Scale	AS SHOWN		
Cad file	C500-WASTEWATER.DWG		
Drawing no.	C520-4	Rev	<b>D</b>


RESOURCE CONSENT

LONGSECTION - CATCHMENT A2 - LINE 5 CONT.  
SCALE 1:1000 HORI & 1:200 VERTICAL @ A3

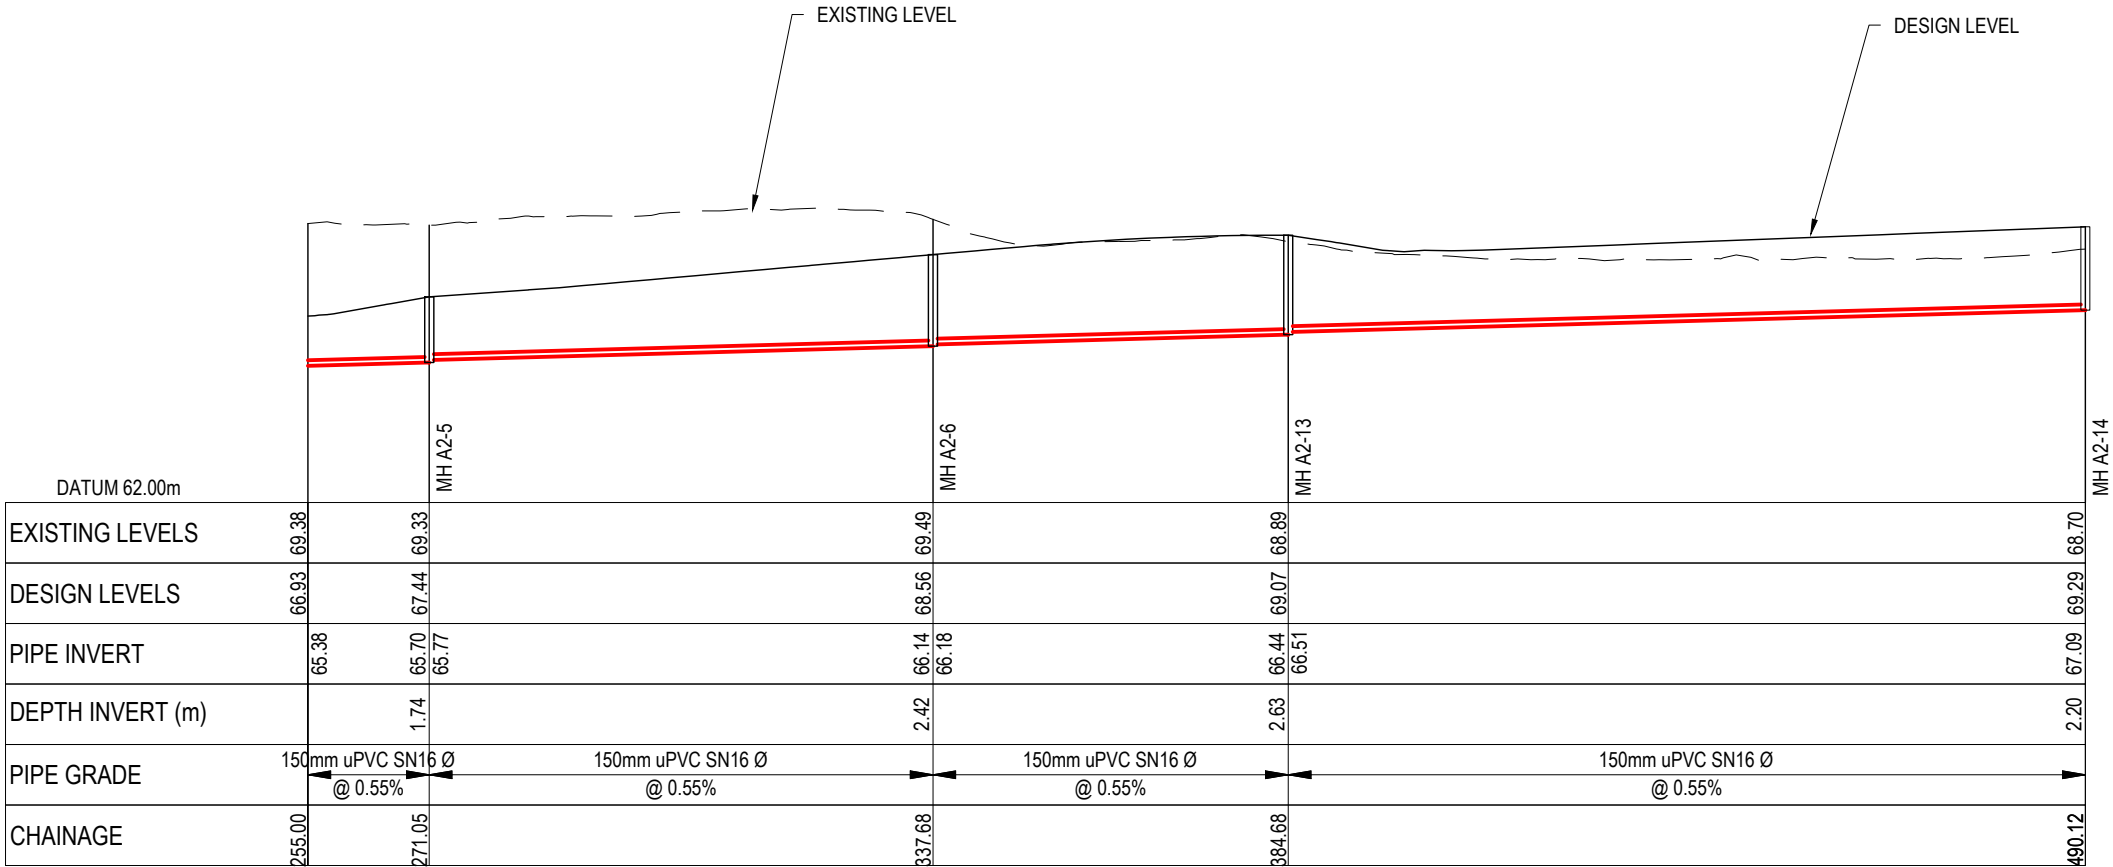


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RESOURCE CONSENT

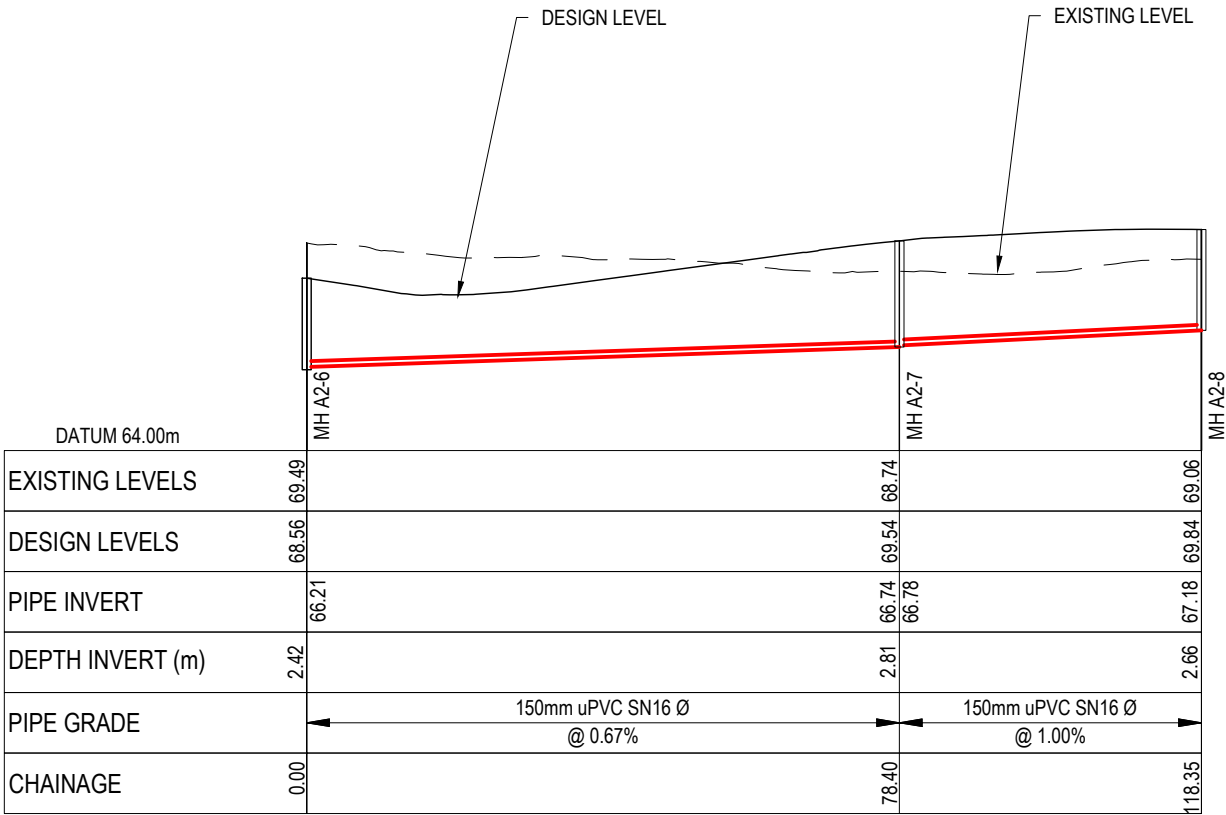

LONGSECTION - CATCHMENT A2 - LINE 6  
SCALE 1:1000 HORI & 1:200 VERTICAL @ A3

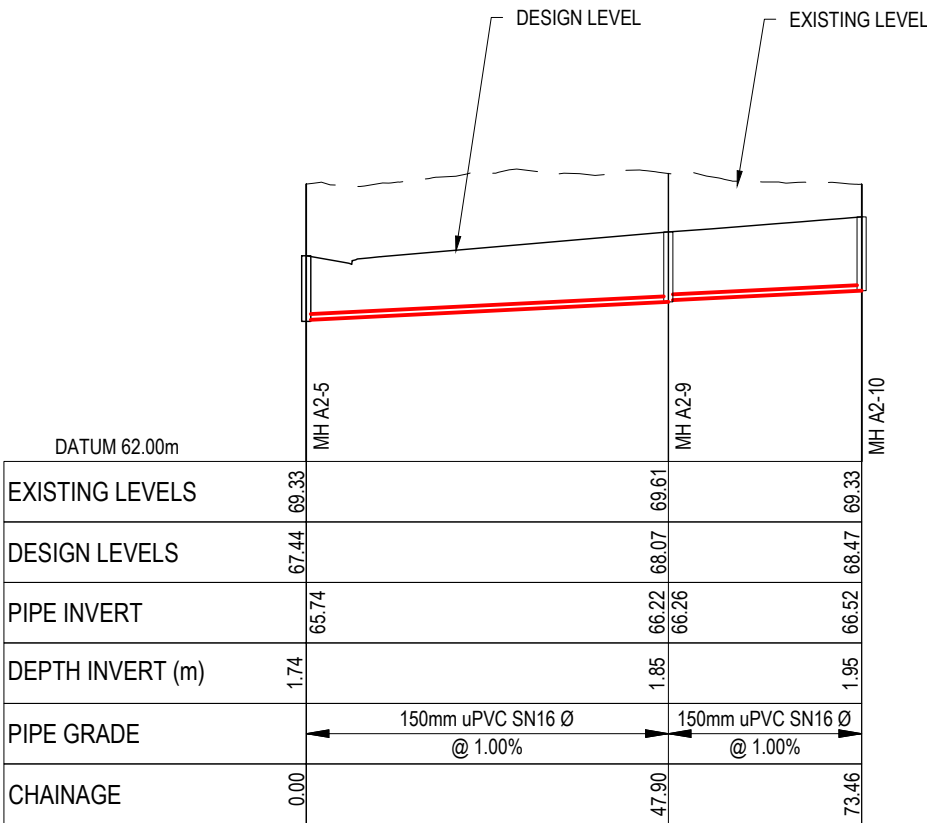

LONGSECTION - CATCHMENT A2 - LINE 7  
SCALE 1:1000 HORI & 1:200 VERTICAL @ A3

- Notes
- All works to be in accordance with Waikato Regional Infrastructure Technical Specifications.
  - Co-ordinates in terms of NZ Geodetic Datum Mount Eden 2000.
  - Levels in terms of the New Zealand Vertical Datum 2016.
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  - 150mmØ pipes that do not terminate in a manhole must be terminated with a 100mmØ on a 150mmØ london junction and blank cap.
  - Manhole diameters shown on structure label are internal diameter.
  - Measurements shown on the lot connections are the distance from the centre of the downstream manhole to the lot connection position within the lot boundary.
  - Manhole slab and cover to be rotated to avoid the footpath edge for manholes on footpath.
  - Pipe lengths shown on plan are from upstream pipe invert to downstream pipe invert.

Legend

EX GROUND LEVEL

PROP GROUND LEVEL

D	FAST TRACK APP	RJM	11/2025
C	FAST TRACK APP	MKS	05/2025
B	FAST TRACK APP	RJM	04/2025
A	FAST TRACK APP	MKS	04/2025
Rev	Description	By	Date
		By	Date
Survey	MAVEN		05/2024
Design	MKS		04/2025
Drawn	MKS		04/2025
Checked	DJM		05/2025

M

MAVEN

Maven Associates

09 571 0050

info@maven.co.nz

www.maven.co.nz

5 Owens Road, Epsom

Auckland 1023

Project

**ASHBOURNE  
RESIDENTIAL  
FOR  
MATAMATA  
DEVELOPMENTS LTD**

Title


**PROPOSED  
WASTEWATER  
LONGSECTIONS**

Project no.	289001		
Scale	AS SHOWN		
Cad file	C500-WASTEWATER.DWG		
Drawing no.	C520-5	Rev	<b>D</b>



DATE: 11/17/25 FILE PATH: F:\MAVEN\HAMILTON\6 PROJECTS\289001 - STATION ROAD\7 DRAWING\11 ASHBOURNE RESIDENTIAL\CS500\WASTEWATER.DWG

RESOURCE CONSENT

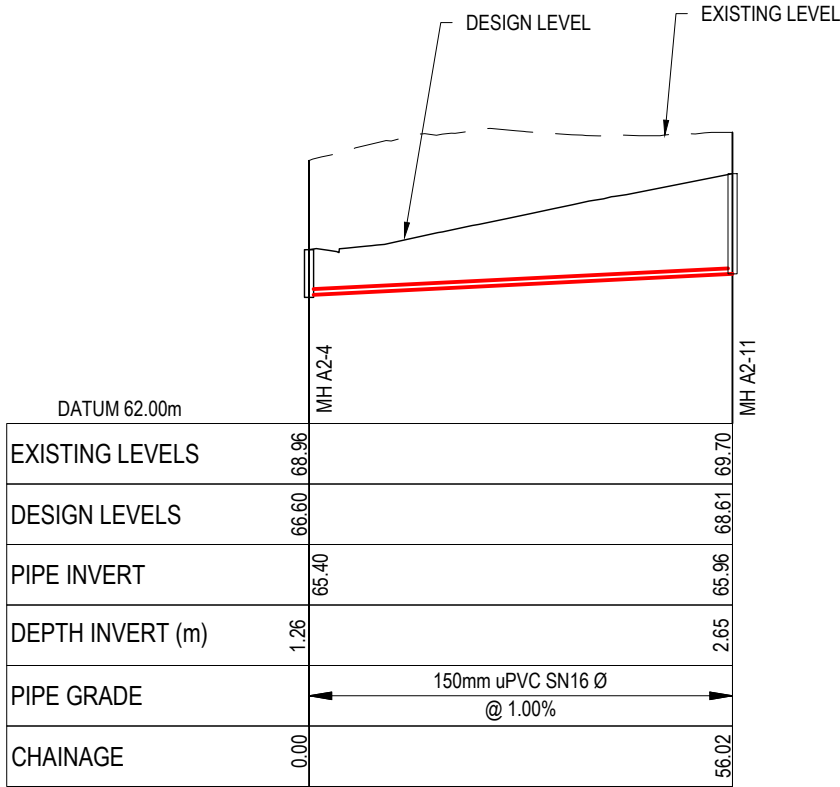

LONGSECTION - CATCHMENT A2 - LINE 8  
SCALE 1:1000 HORI & 1:200 VERTICAL @ A3

- Notes
- All works to be in accordance with Waikato Regional Infrastructure Technical Specifications.
  - Co-ordinates in terms of NZ Geodetic Datum Mount Eden 2000.
  - Levels in terms of the New Zealand Vertical Datum 2016.
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Legend

EX GROUND LEVEL

PROP GROUND LEVEL

D	FAST TRACK APP	RJM	11/2025
C	FAST TRACK APP	MKS	05/2025
B	FAST TRACK APP	RJM	04/2025
A	FAST TRACK APP	MKS	04/2025
Rev	Description	By	Date
	By	Date	
Survey	MAVEN	05/2024	
Design	MKS	04/2025	
Drawn	MKS	04/2025	
Checked	DJM	05/2025	

M

MAVEN

**Maven Associates**  
09 571 0050  
info@maven.co.nz  
www.maven.co.nz  
5 Owens Road, Epsom  
Auckland 1023

Project


**ASHBOURNE  
RESIDENTIAL  
FOR  
MATAMATA  
DEVELOPMENTS LTD**

Title


**PROPOSED  
WASTEWATER  
LONGSECTIONS**

Project no.	289001		
Scale	AS SHOWN		
Cad file	C500-WASTEWATER.DWG		
Drawing no.	C520-6	Rev	<b>D</b>

DATE: 11/11/25 FILE PATH: F:\MAVEN\HAMITONG PROJECTS\289001 - STATION ROAD\ DRAWING\11. ASHBOURNE RESIDENTIAL\C520\WASTEWATER.DWG

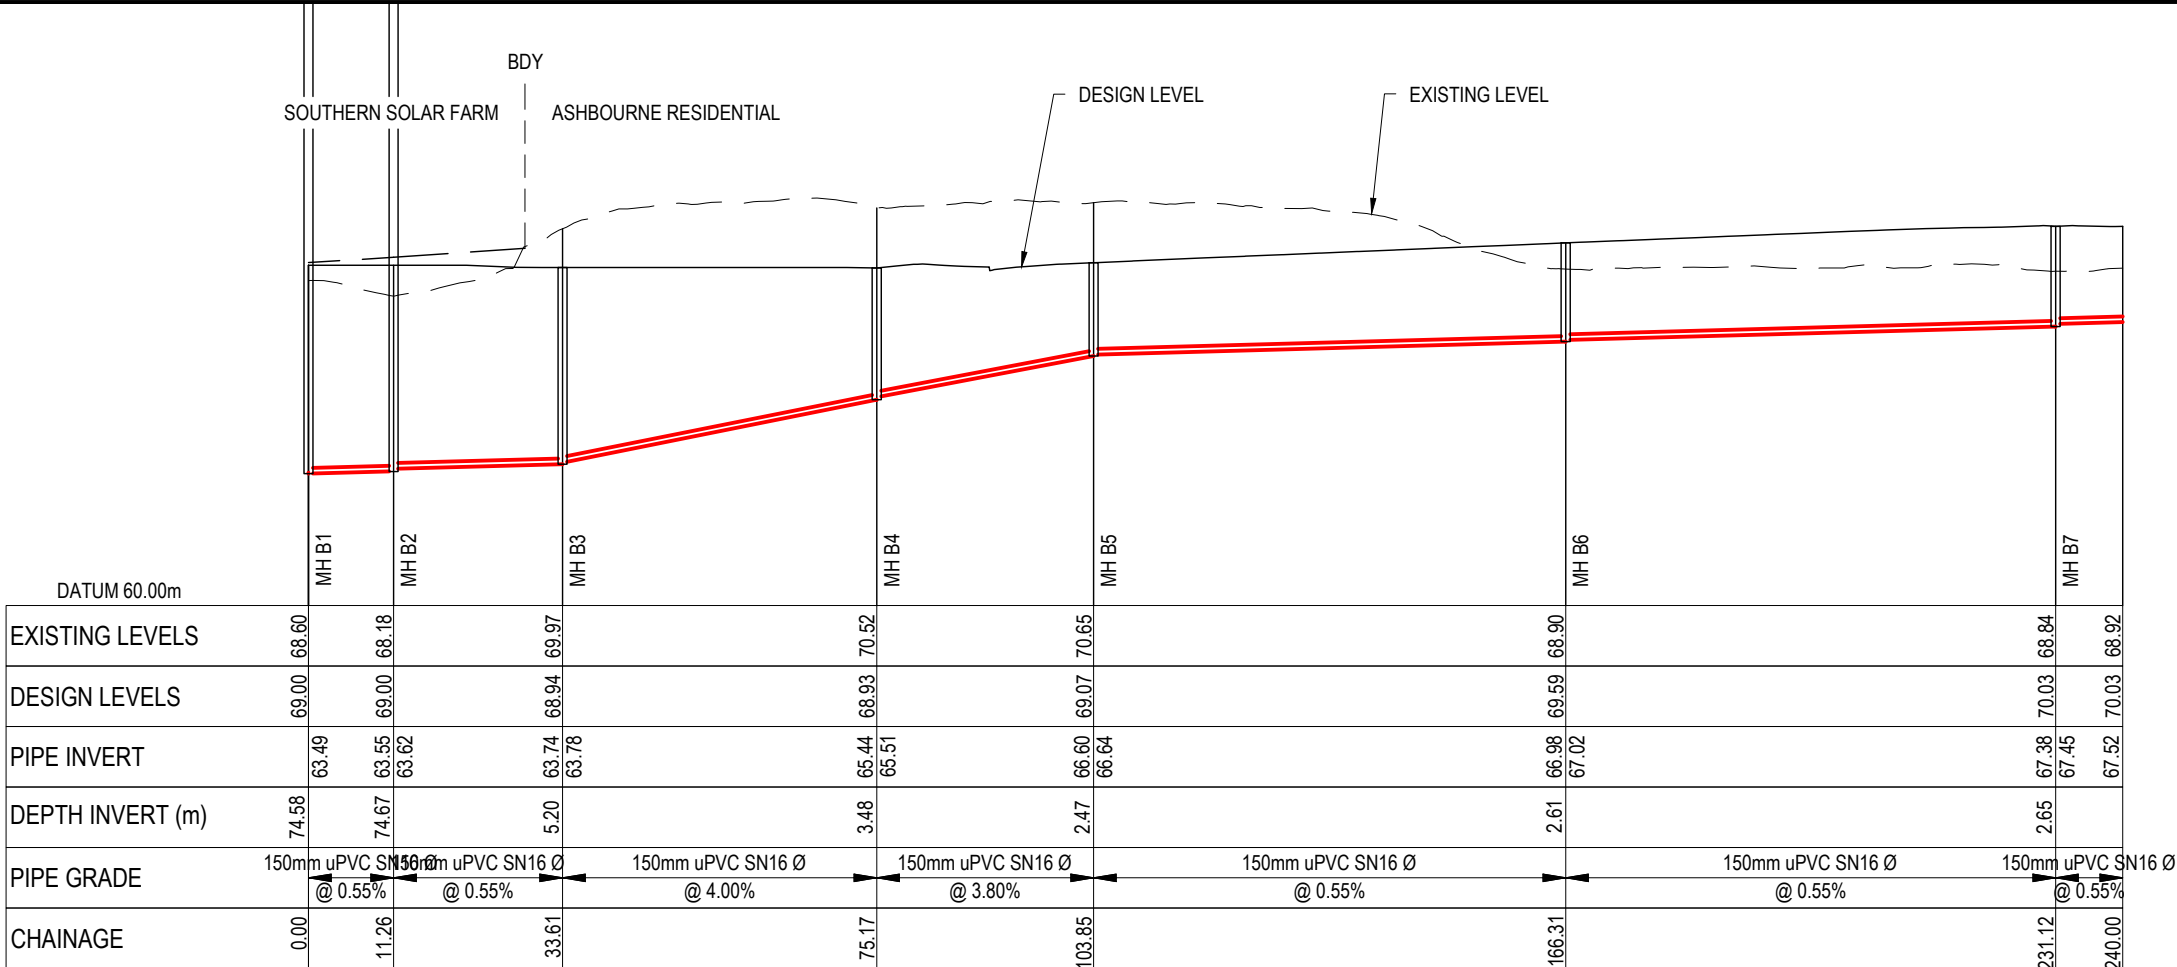

LONGSECTION - CATCHMENT B - LINE 1  
SCALE 1:1000 HORI & 1:200 VERTICAL @ A3

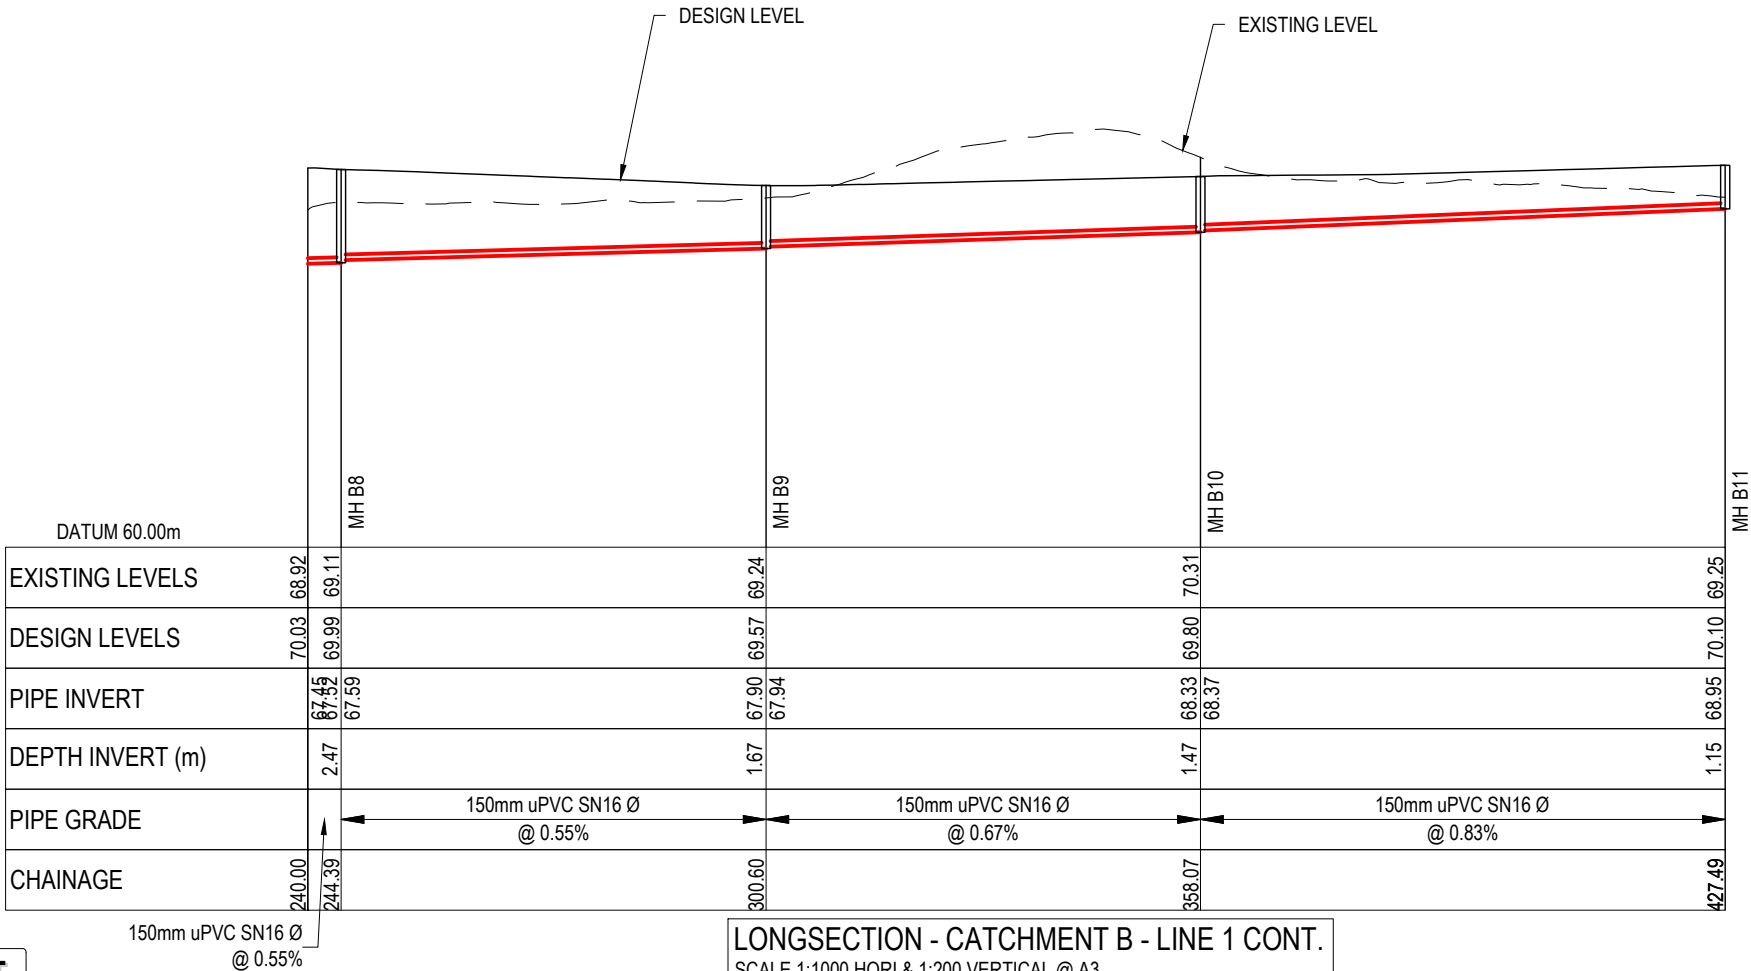

LONGSECTION - CATCHMENT B - LINE 1 CONT.  
SCALE 1:1000 HORI & 1:200 VERTICAL @ A3

RESOURCE CONSENT

- Notes
1. All works to be in accordance with Waikato Regional Infrastructure Technical Specifications.
  2. Co-ordinates in terms of NZ Geodetic Datum Mount Eden 2000.
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  13. Pipe lengths shown on plan are from upstream pipe invert to downstream pipe invert.

Legend

EX GROUND LEVEL

PROP GROUND LEVEL

D	FAST TRACK APP	RJM	11/2025
C	FAST TRACK APP	MKS	05/2025
B	FAST TRACK APP	RJM	04/2025
A	FAST TRACK APP	MKS	04/2025
Rev	Description	By	Date
	By	Date	
Survey	MAVEN	05/2024	
Design	MKS	04/2025	
Drawn	MKS	04/2025	
Checked	DJM	05/2025	



Project

**ASHBOURNE  
RESIDENTIAL  
FOR  
MATAMATA  
DEVELOPMENTS LTD**

Title


**PROPOSED  
WASTEWATER  
LONGSECTIONS**

Project no.	289001		
Scale	AS SHOWN		
Cad file	C500-WASTEWATER.DWG		
Drawing no.	C520-7	Rev	D




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RESOURCE CONSENT

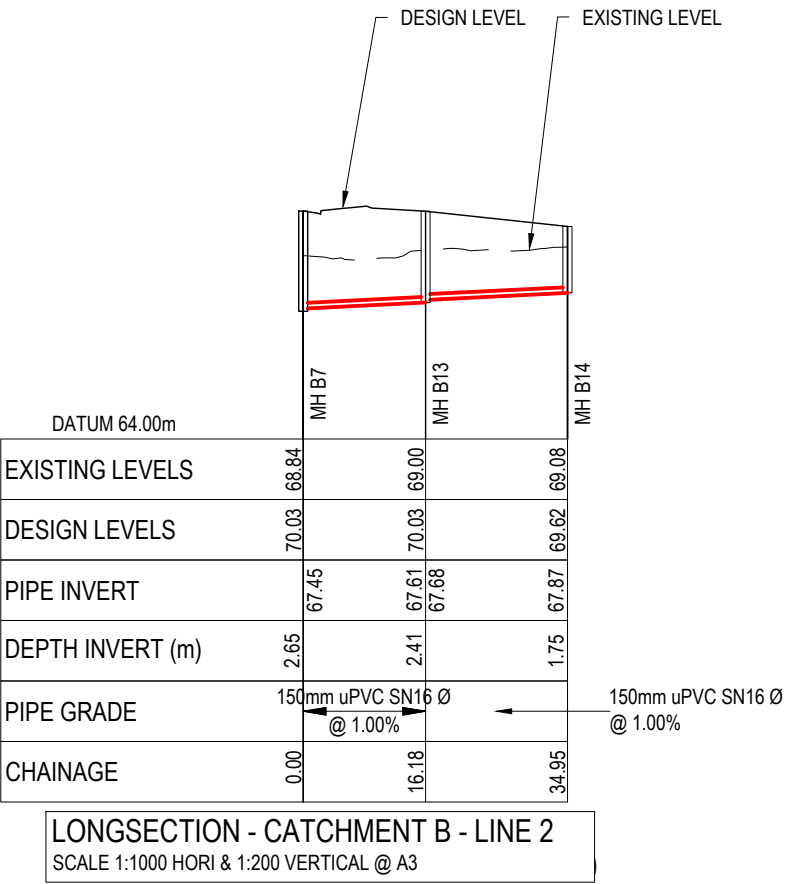



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  - Pipe lengths shown on plan are from upstream pipe invert to downstream pipe invert.
- Legend
- EX GROUND LEVEL  
PROP GROUND LEVEL

D	FAST TRACK APP	RJM	11/2025
C	FAST TRACK APP	MKS	05/2025
B	FAST TRACK APP	RJM	04/2025
A	FAST TRACK APP	MKS	04/2025
Rev	Description	By	Date
	By	Date	
Survey	MAVEN	05/2024	
Design	MKS	04/2025	
Drawn	MKS	04/2025	
Checked	DJM	05/2025	
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Project			
ASHBOURNE RESIDENTIAL FOR MATAMATA DEVELOPMENTS LTD			
Title			
PROPOSED WASTEWATER LONGSECTIONS			
Project no.	289001		
Scale	AS SHOWN		
Cad file	C500-WASTEWATER.DWG		
Drawing no.	C520-8	Rev	D

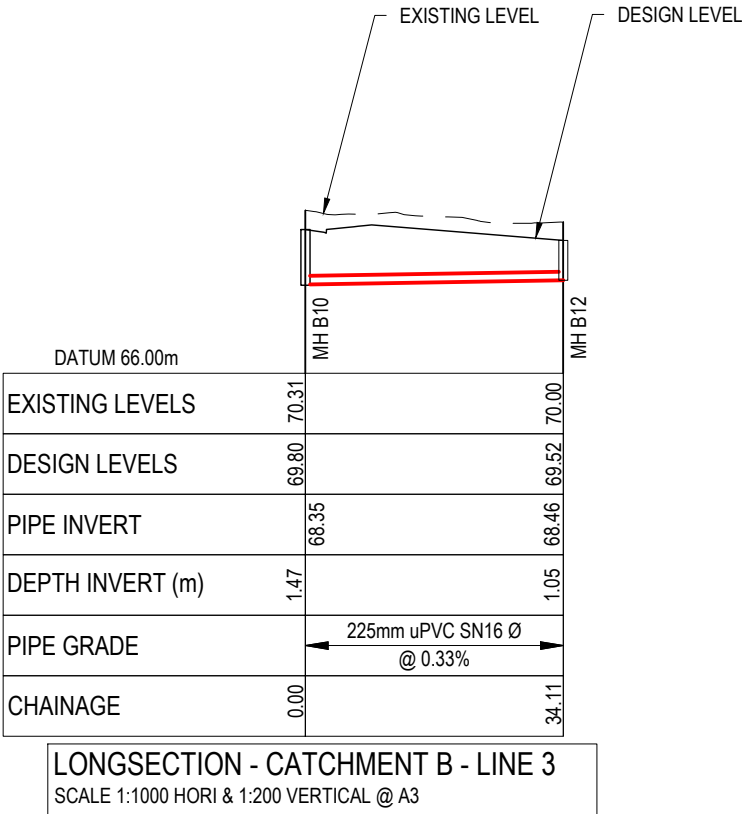

DATE: 11/17/25 FILEPATH: F:\MAVEN\HAMITON6 PROJECTS\289001 - STATION ROAD\7 DRAWING\11 ASHBORNE RESIDENTIAL\CS500\WASTEWATER.DWG

RESOURCE CONSENT

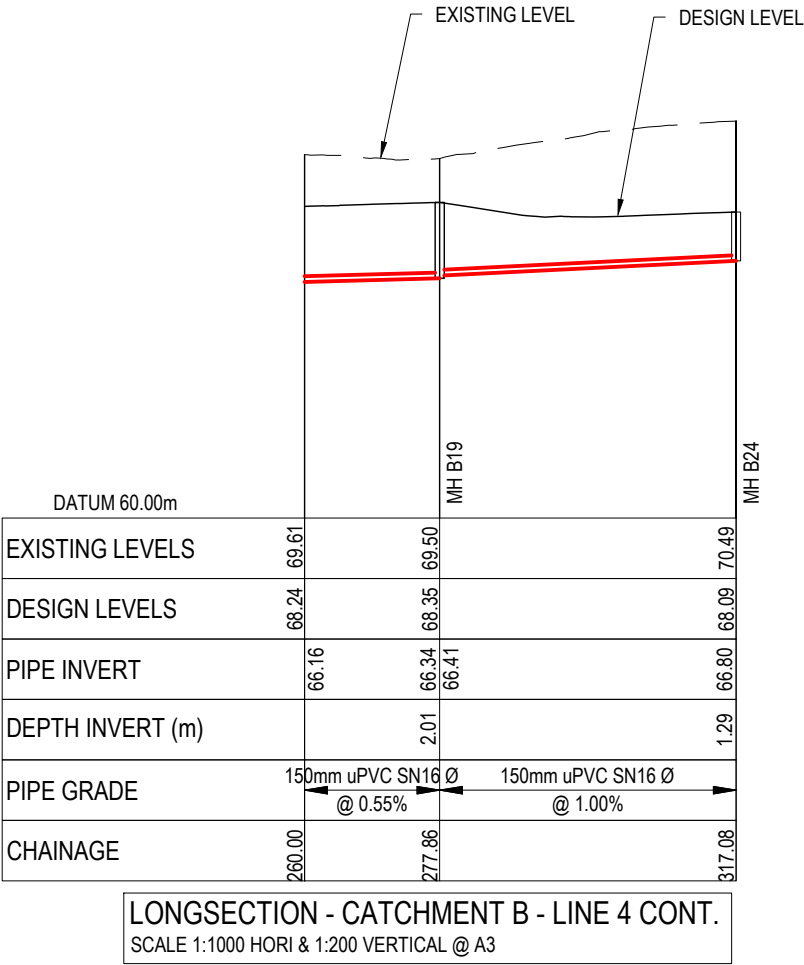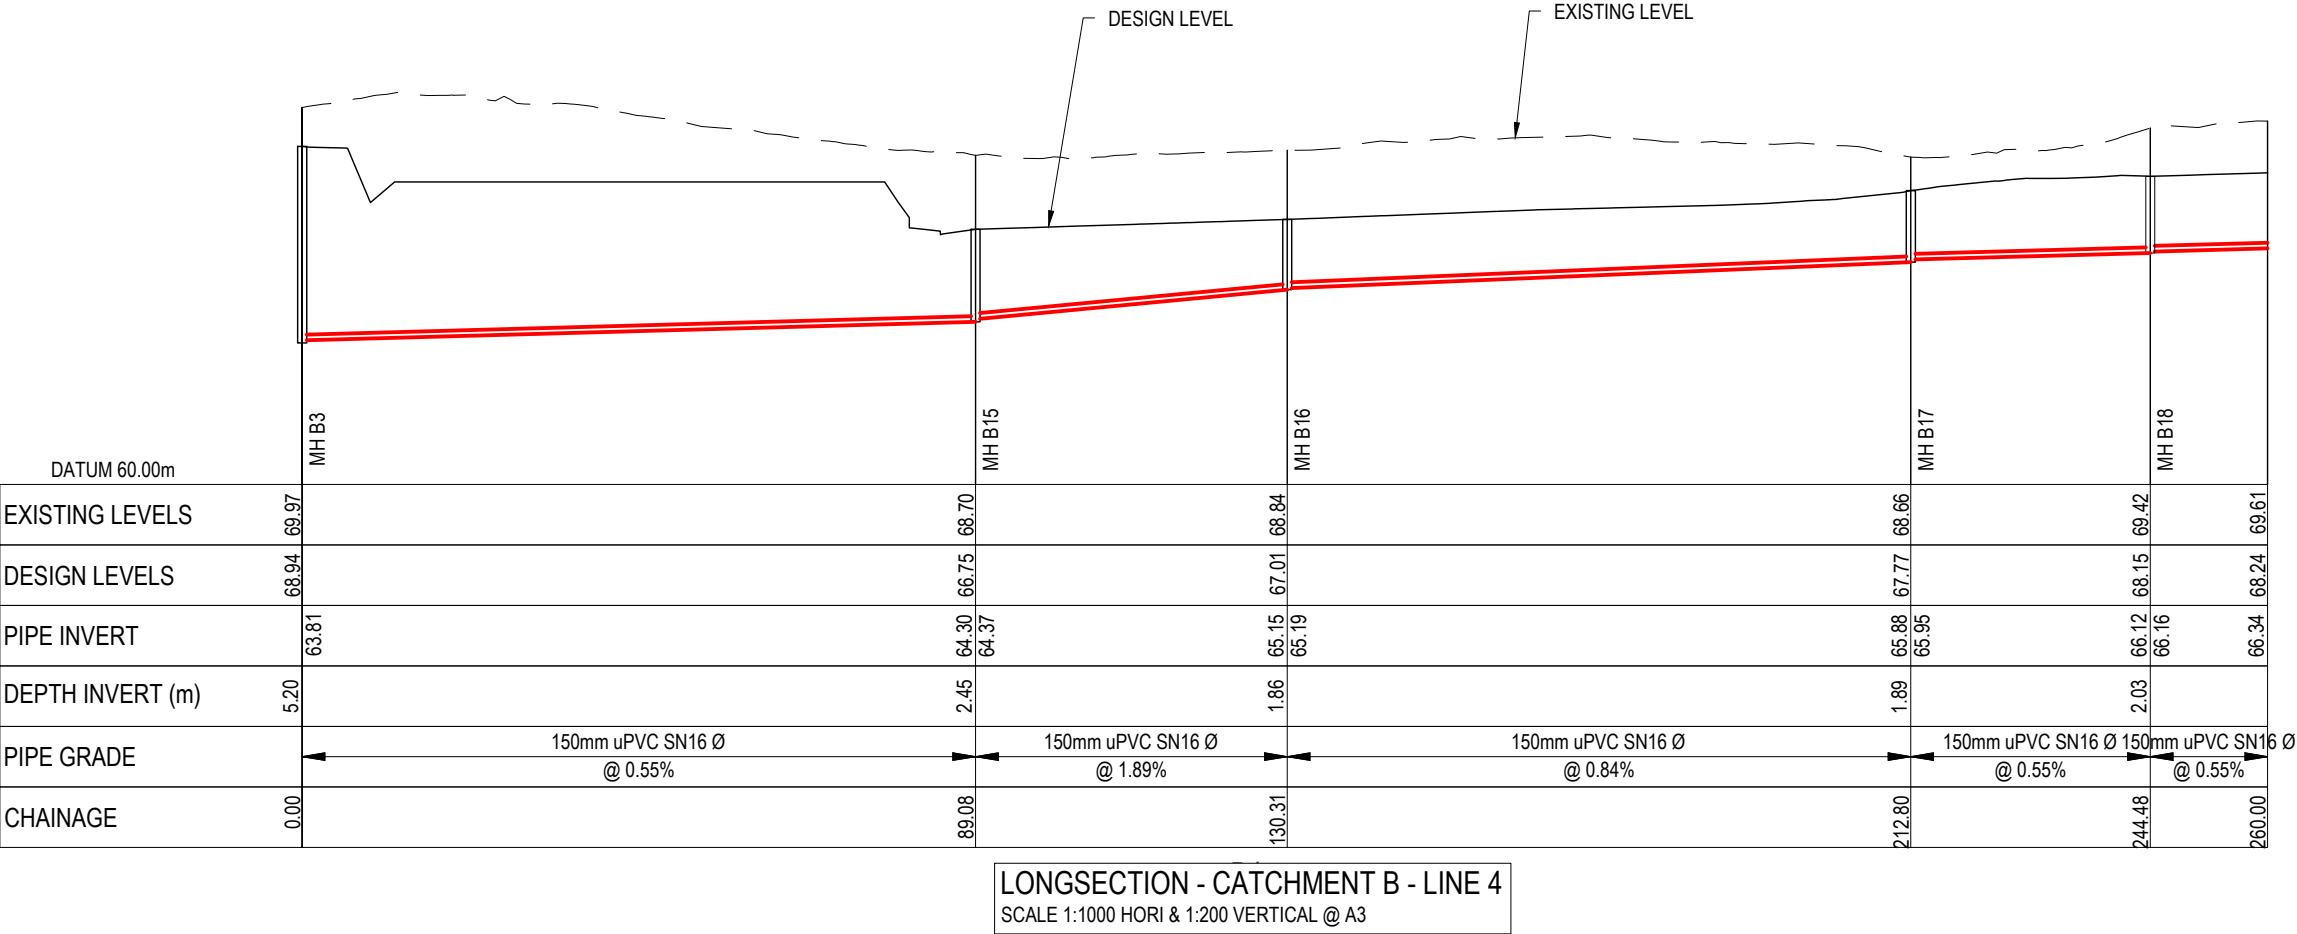


- Notes
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- Legend
- EX GROUND LEVEL
  - PROP GROUND LEVEL

D	FAST TRACK APP	RJM	11/2025
C	FAST TRACK APP	MKS	05/2025
B	FAST TRACK APP	RJM	04/2025
A	FAST TRACK APP	MKS	04/2025
Rev	Description	By	Date
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Survey	MAVEN	05/2024	
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Project			
ASHBOURNE RESIDENTIAL FOR MATAMATA DEVELOPMENTS LTD			
Title			
PROPOSED WASTEWATER LONGSECTIONS			
Project no.	289001		
Scale	AS SHOWN		
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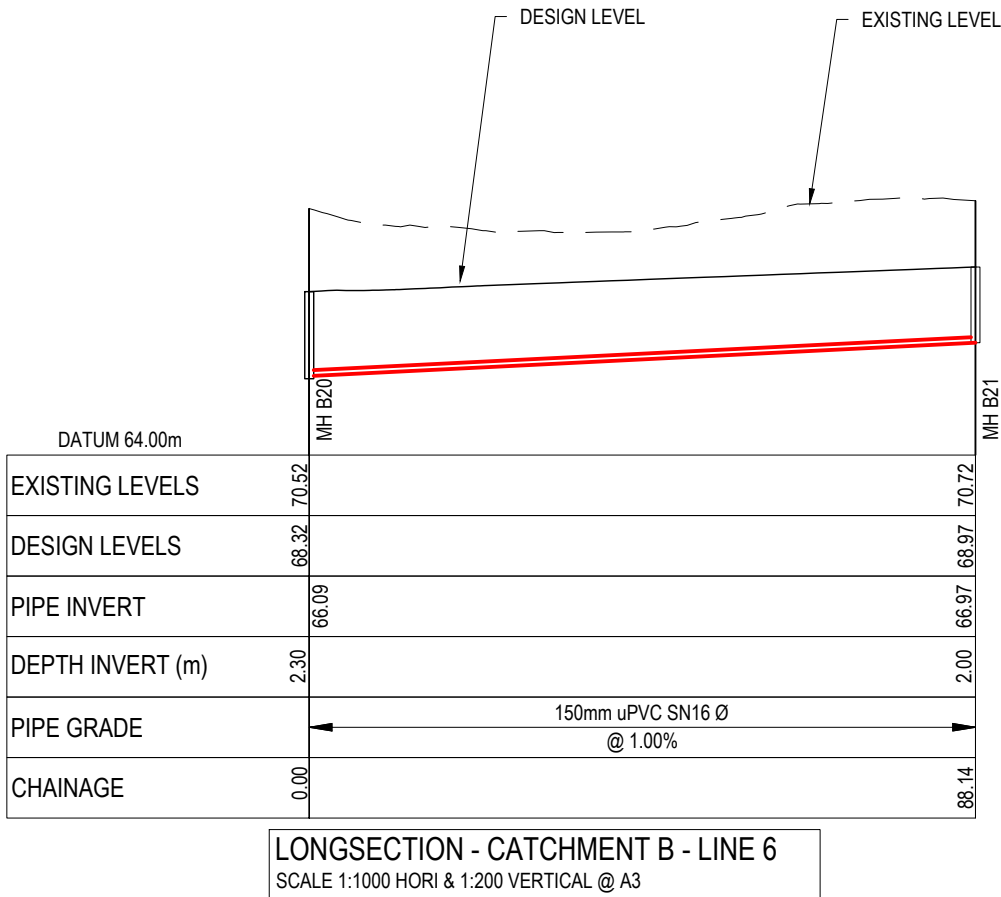


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RESOURCE CONSENT



- Notes
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- Legend
- EX GROUND LEVEL
- PROP GROUND LEVEL

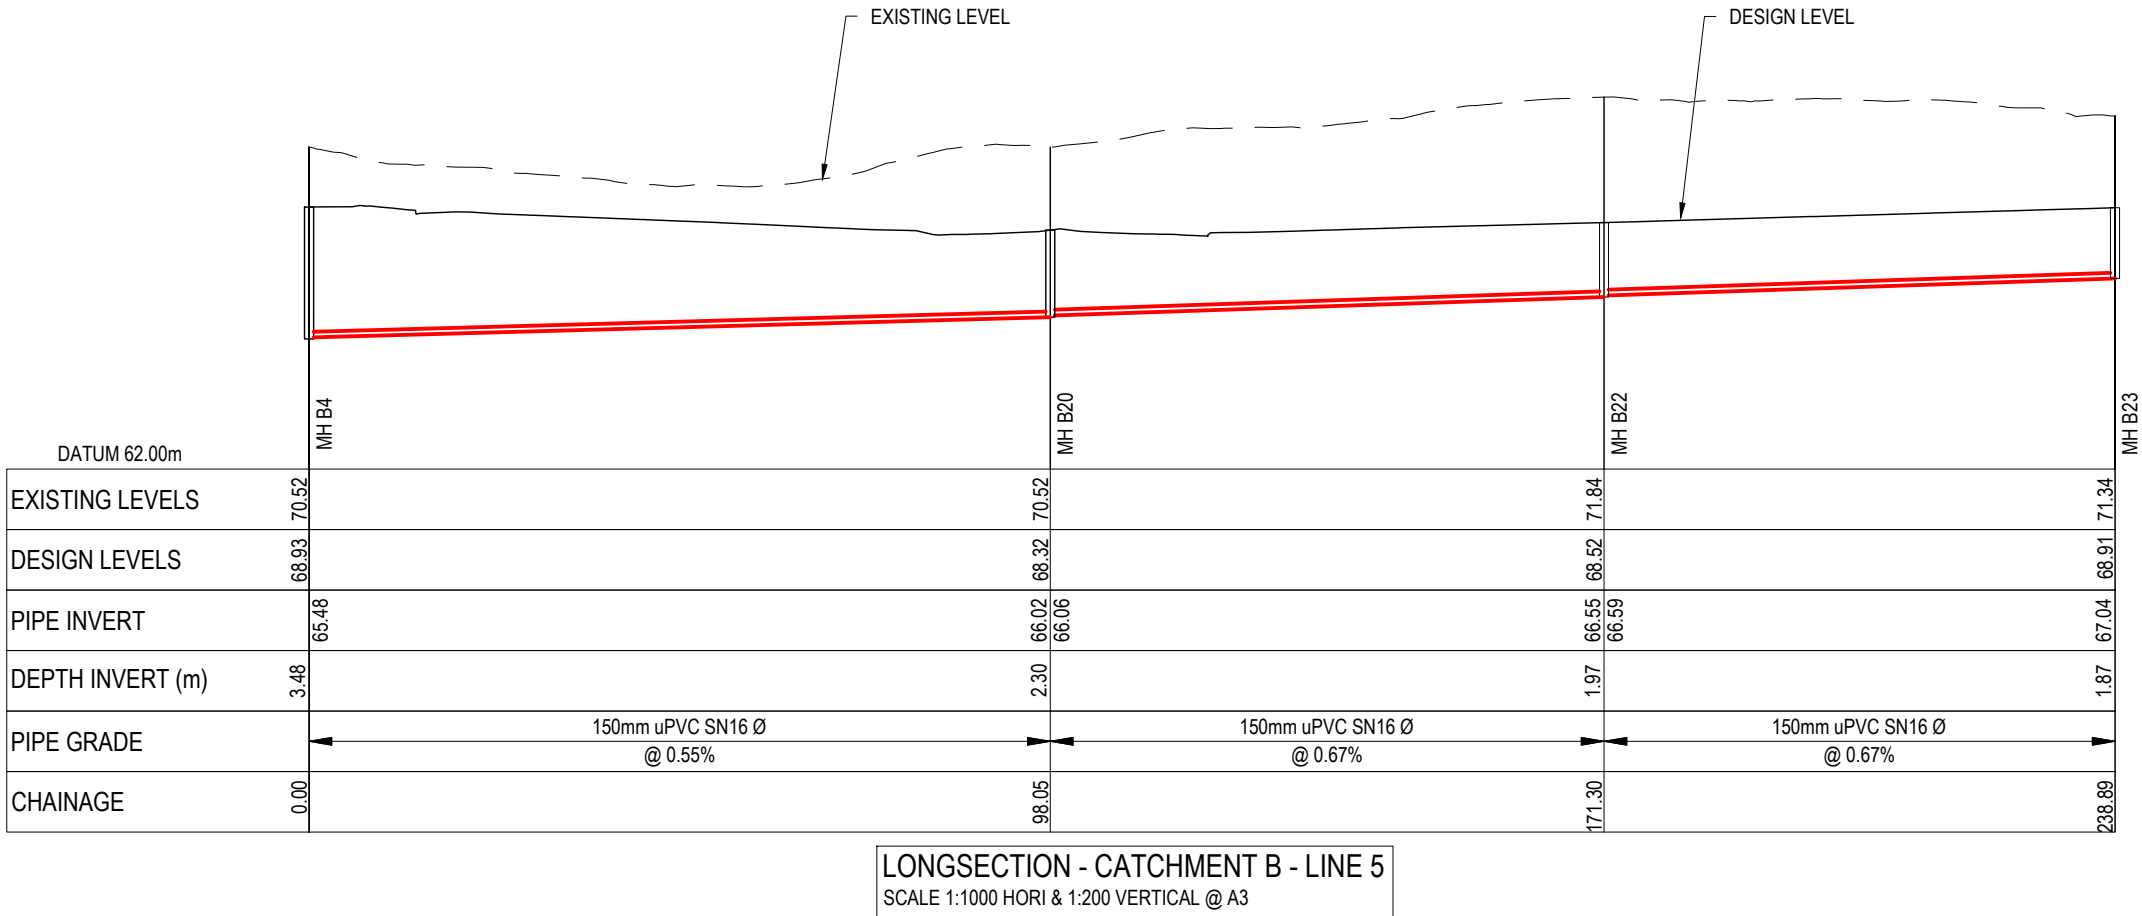

D	FAST TRACK APP	RJM	11/2025
C	FAST TRACK APP	MKS	05/2025
B	FAST TRACK APP	RJM	04/2025
A	FAST TRACK APP	MKS	04/2025
Rev	Description	By	Date
		By	Date
Survey	MAVEN		05/2024
Design	MKS		04/2025
Drawn	MKS		04/2025
Checked	DJM		05/2025

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MAVEN Associates

09 571 0050

info@maven.co.nz

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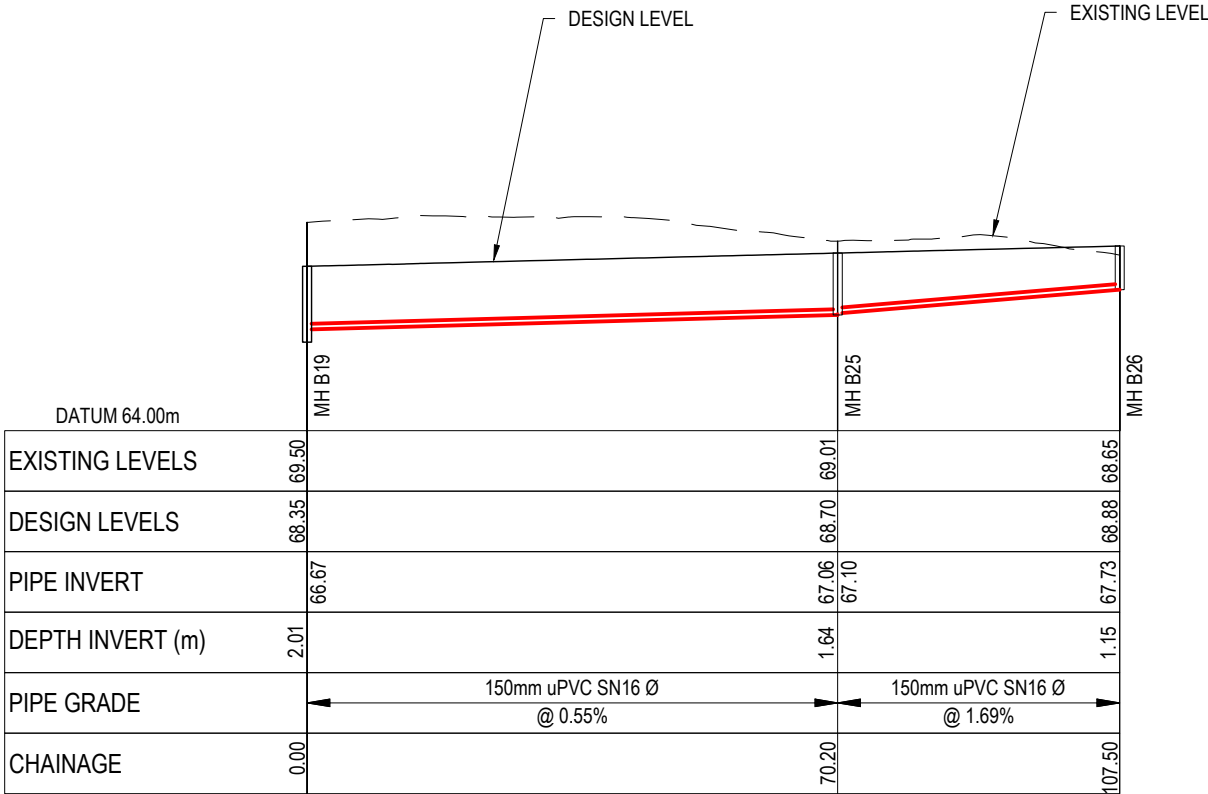
5 Owens Road, Epsom

Auckland 1023


Project			
ASHBOURNE RESIDENTIAL FOR MATAMATA DEVELOPMENTS LTD			
Title			
PROPOSED WASTEWATER LONGSECTIONS			
Project no.	289001		
Scale	AS SHOWN		
Cad file	C500-WASTEWATER.DWG		
Drawing no.	C520-10	Rev	D

DATE: 11/17/25 FILE PATH: F:\MAVEN\HAMITON\6 PROJECTS\289001 - STATION ROAD\7 DRAWING\11 ASHBOURNE RESIDENTIAL\CS500\WASTEWATER.DWG

RESOURCE CONSENT



LONGSECTION - CATCHMENT B - LINE 7  
SCALE 1:1000 HORI & 1:200 VERTICAL @ A3

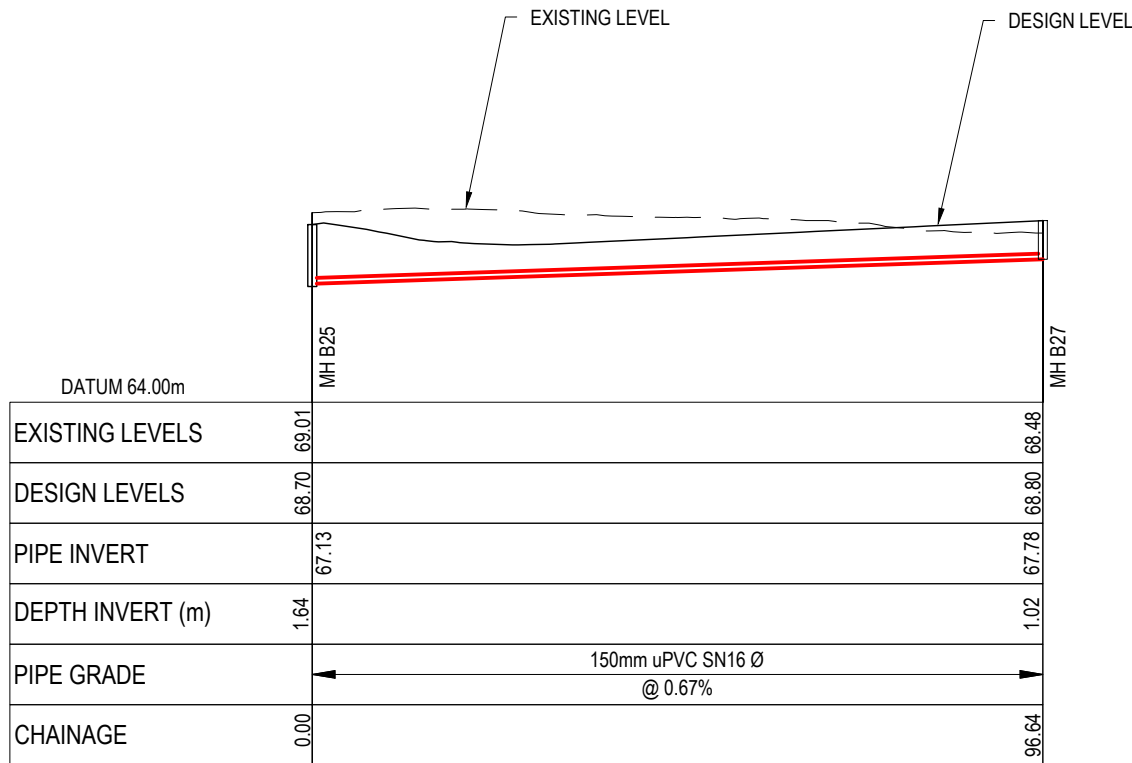

LONGSECTION - CATCHMENT B - LINE 8  
SCALE 1:1000 HORI & 1:200 VERTICAL @ A3

- Notes
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Legend

EX GROUND LEVEL

PROP GROUND LEVEL

D	FAST TRACK APP	RJM	11/2025
C	FAST TRACK APP	MKS	05/2025
B	FAST TRACK APP	RJM	04/2025
A	FAST TRACK APP	MKS	04/2025
Rev	Description	By	Date
		By	Date
Survey	MAVEN		05/2024
Design	MKS		04/2025
Drawn	MKS		04/2025
Checked	DJM		05/2025



Project

**ASHBOURNE  
RESIDENTIAL  
FOR  
MATAMATA  
DEVELOPMENTS LTD**

Title


**PROPOSED  
WASTEWATER  
LONGSECTIONS**

Project no.	289001		
Scale	AS SHOWN		
Cad file	C500-WASTEWATER.DWG		
Drawing no.	C520-11	Rev	D




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RESOURCE CONSENT

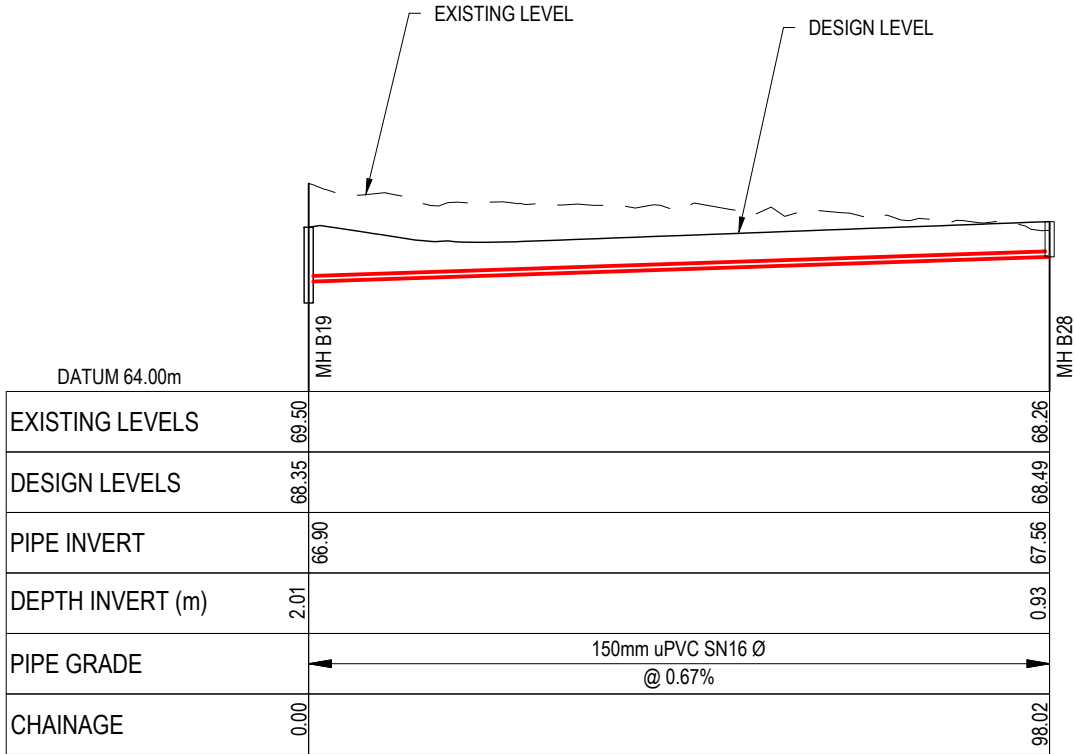

LONGSECTION - CATCHMENT B - LINE 9  
SCALE 1:1000 HORI & 1:200 VERTICAL @ A3

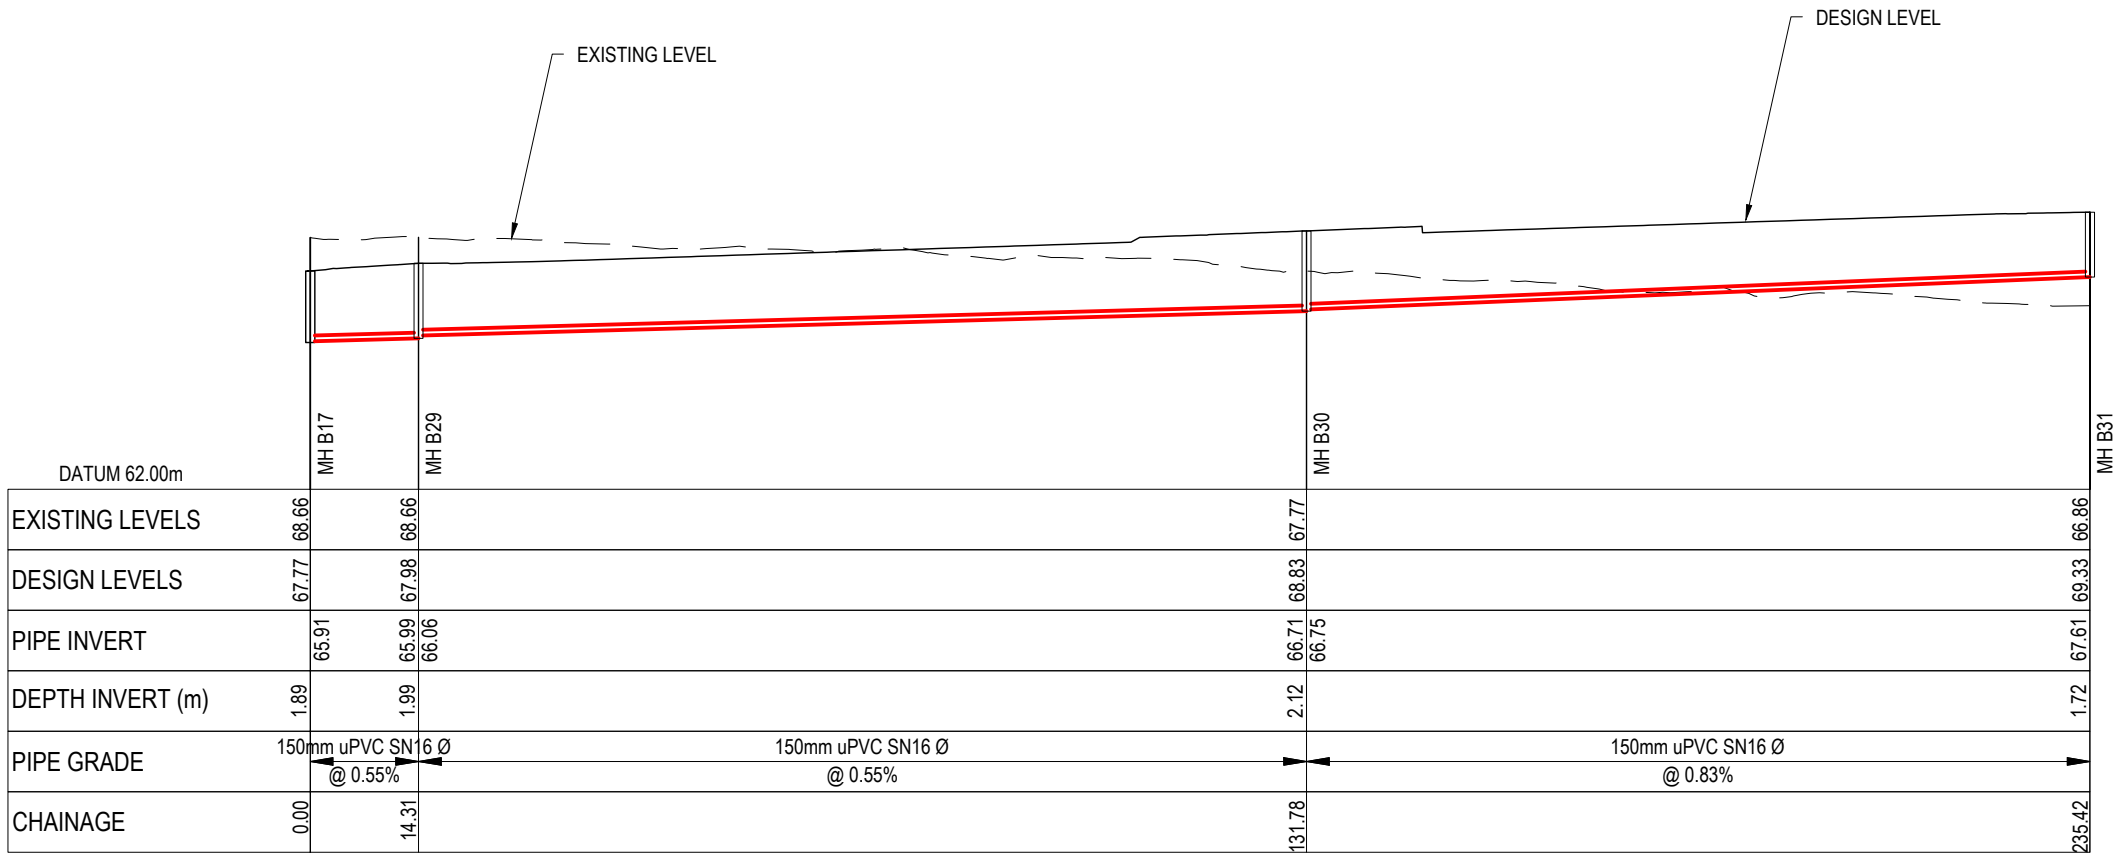

LONGSECTION - CATCHMENT B - LINE 10  
SCALE 1:1000 HORI & 1:200 VERTICAL @ A3

- Notes
- All works to be in accordance with Waikato Regional Infrastructure Technical Specifications.
  - Co-ordinates in terms of NZ Geodetic Datum Mount Eden 2000.
  - Levels in terms of the New Zealand Vertical Datum 2016.
  - It is the Contractors responsibility to locate all services that may be affected by his operations.
  - Approved hardfill is to be used in backfilling of all road crossings to council standards.
  - Heavy duty manhole lids and frames to be used in trafficked areas, all manholes shall have stainless grates installed.
  - All lines are to be 150mmØ PVC Class SN16 unless shown otherwise.
  - All lot connections are to be 100mmØ PVC unless shown otherwise.
  - 150mmØ pipes that do not terminate in a manhole must be terminated with a 100mmØ on a 150mmØ london junction and blank cap.
  - Manhole diameters shown on structure label are internal diameter.
  - Measurements shown on the lot connections are the distance from the centre of the downstream manhole to the lot connection position within the lot boundary.
  - Manhole slab and cover to be rotated to avoid the footpath edge for manholes on footpath.
  - Pipe lengths shown on plan are from upstream pipe invert to downstream pipe invert.

Legend

EX GROUND LEVEL  
PROP GROUND LEVEL

D	FAST TRACK APP	RJM	11/2025
C	FAST TRACK APP	MKS	05/2025
B	FAST TRACK APP	RJM	04/2025
A	FAST TRACK APP	MKS	04/2025
Rev	Description	By	Date
		By	Date
Survey	MAVEN		05/2024
Design	MKS		04/2025
Drawn	MKS		04/2025
Checked	DJM		05/2025




Project  
**ASHBOURNE  
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FOR  
MATAMATA  
DEVELOPMENTS LTD**

Title  
**PROPOSED  
WASTEWATER  
LONGSECTIONS**


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Scale	AS SHOWN		
Cad file	C500-WASTEWATER.DWG		
Drawing no.	C520-12	Rev	<b>D</b>

DATE: 11/1/25 FILEPATH: F:\MAVEN\HAMITONG PROJECTS\289001 - STATION ROAD\7 DRAWING\11 ASHBOURNE RESIDENTIAL\CS500\WASTEWATER.DWG

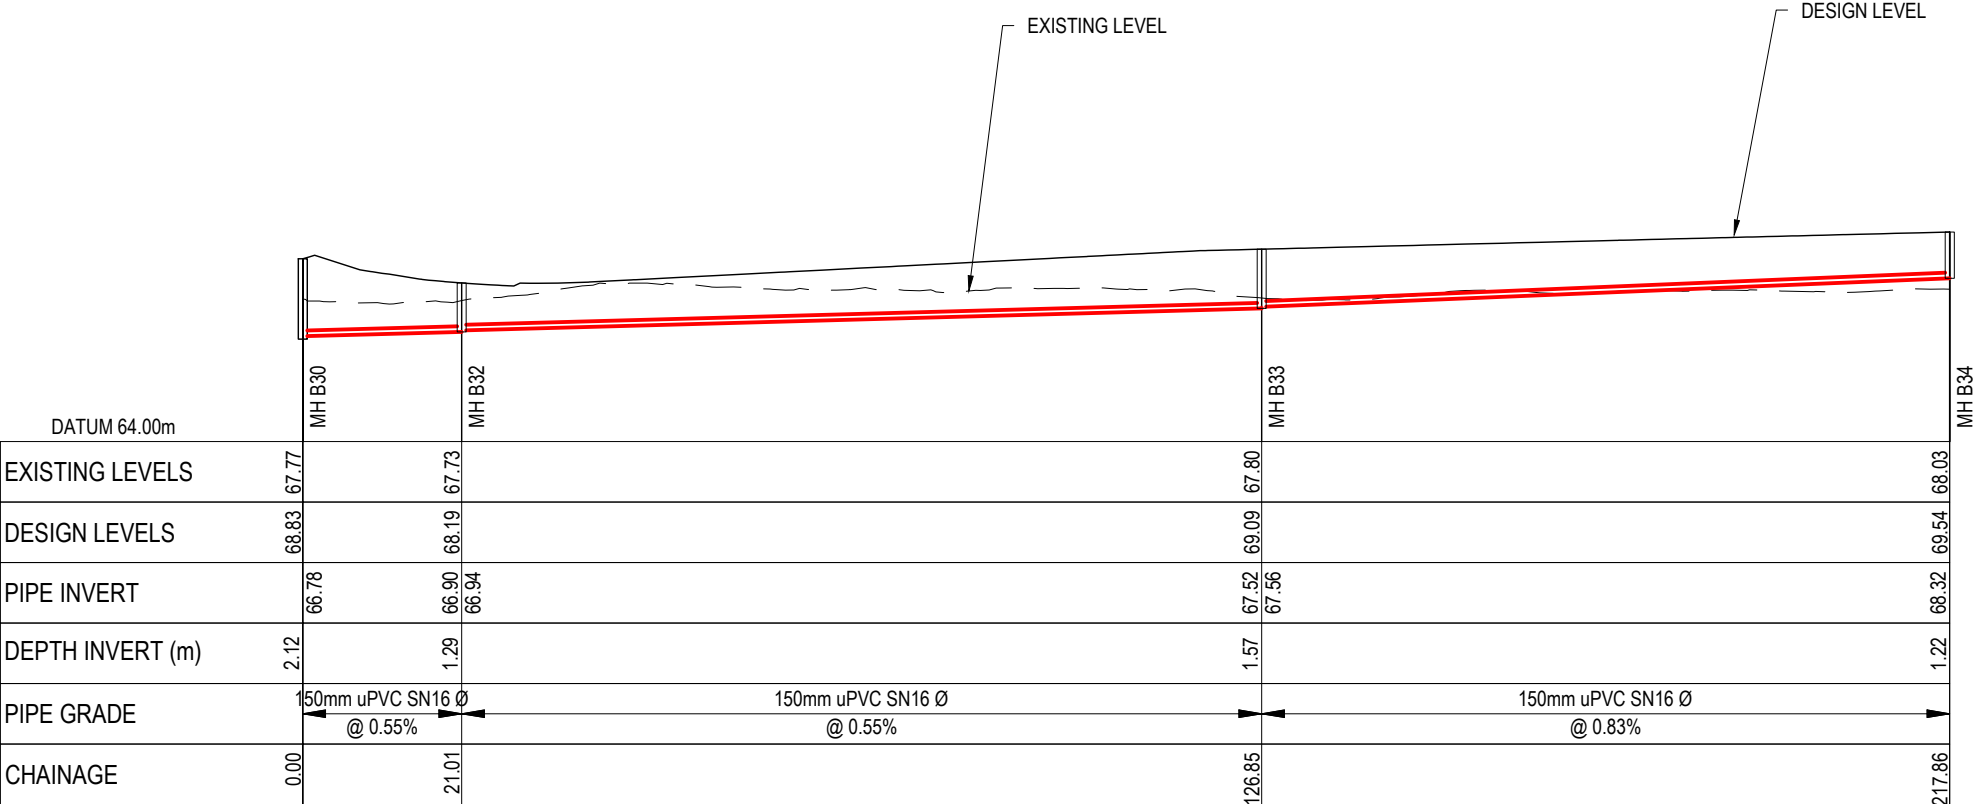

LONGSECTION - CATCHMENT B - LINE 11  
SCALE 1:1000 HORI & 1:200 VERTICAL @ A3

- Notes
1. All works to be in accordance with Waikato Regional Infrastructure Technical Specifications.
  2. Co-ordinates in terms of NZ Geodetic Datum Mount Eden 2000.
  3. Levels in terms of the New Zealand Vertical Datum 2016.
  4. It is the Contractors responsibility to locate all services that may be affected by his operations.
  5. Approved hardfill is to be used in backfilling of all road crossings to council standards.
  6. Heavy duty manhole lids and frames to be used in trafficked areas, all manholes shall have stainless grates installed.
  7. All lines are to be 150mmØ PVC Class SN16 unless shown otherwise.
  8. All lot connections are to be 100mmØ PVC unless shown otherwise.
  9. 150mmØ pipes that do not terminate in a manhole must be terminated with a 100mmØ on a 150mmØ london junction and blank cap.
  10. Manhole diameters shown on structure label are internal diameter.
  11. Measurements shown on the lot connections are the distance from the centre of the downstream manhole to the lot connection position within the lot boundary.
  12. Manhole slab and cover to be rotated to avoid the footpath edge for manholes on footpath.
  13. Pipe lengths shown on plan are from upstream pipe invert to downstream pipe invert.
- Legend
- EX GROUND LEVEL
- PROP GROUND LEVEL

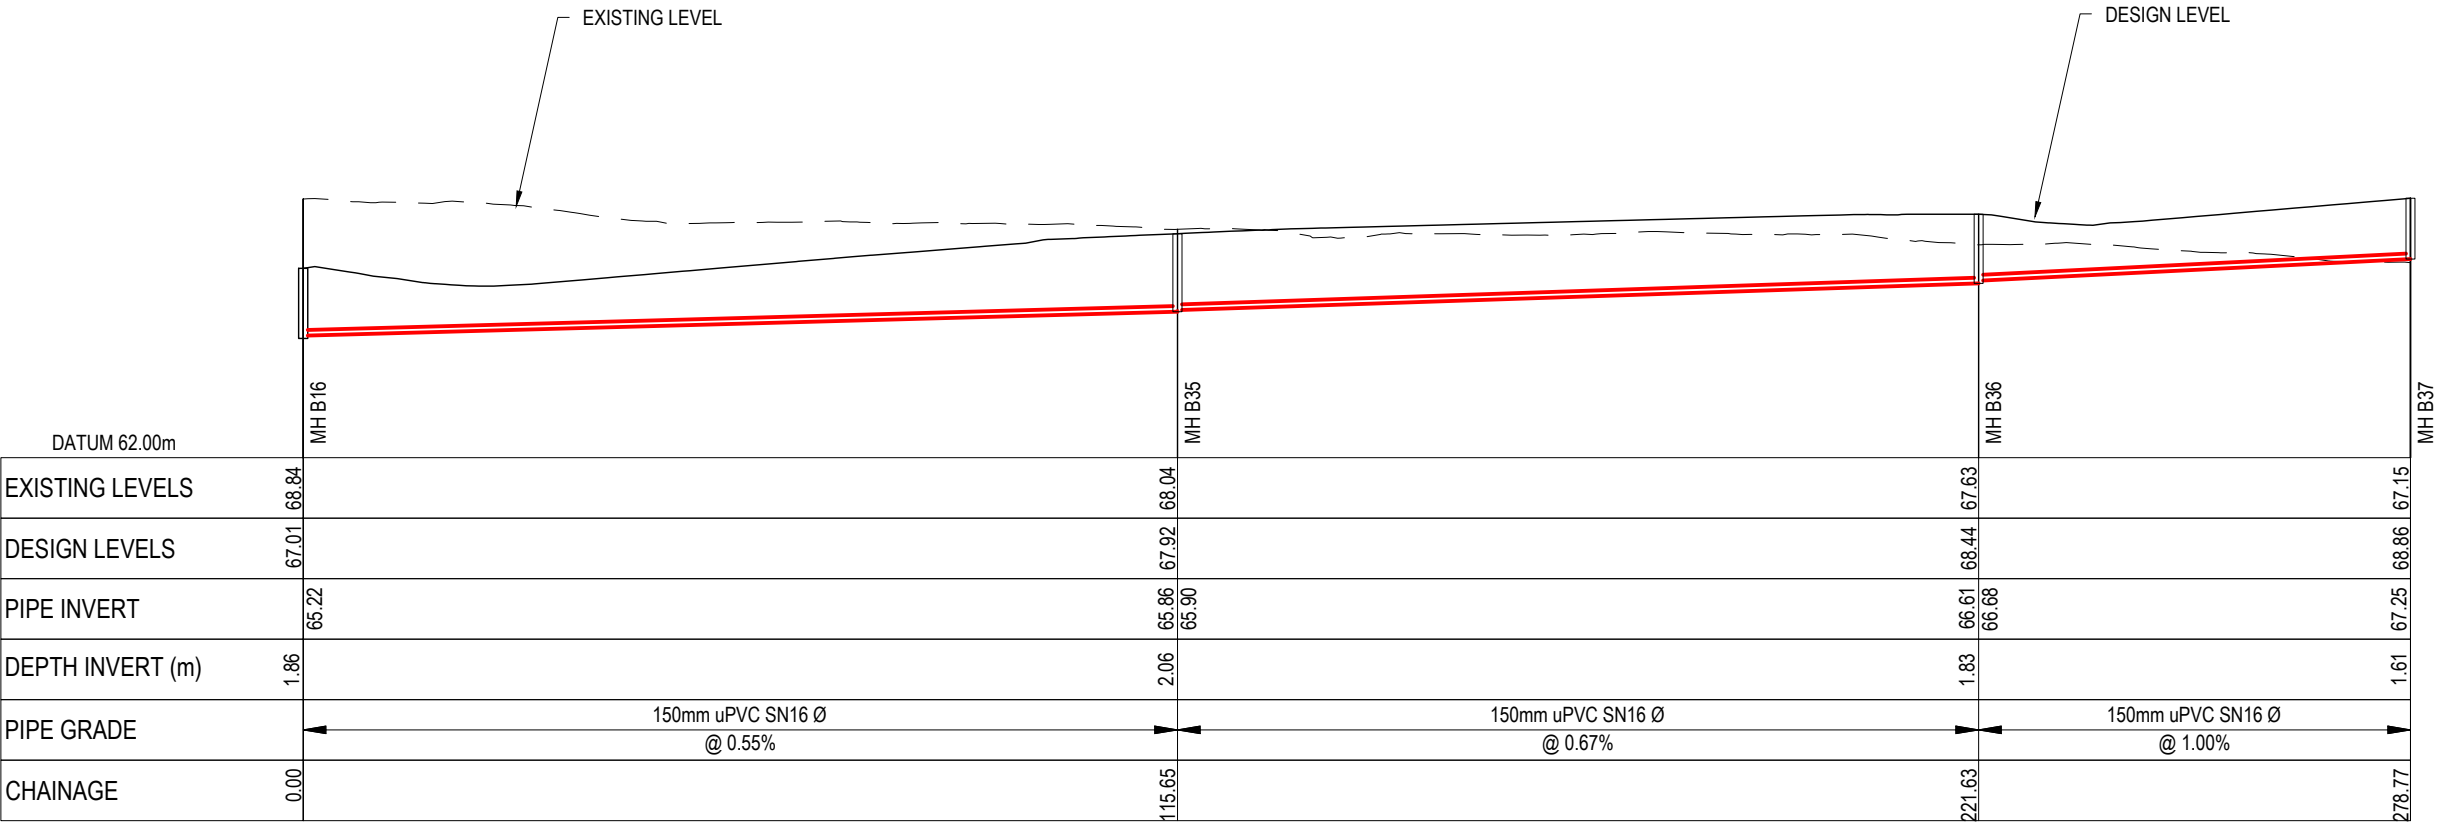

LONGSECTION - CATCHMENT B - LINE 12  
SCALE 1:1000 HORI & 1:200 VERTICAL @ A3

D	FAST TRACK APP	RJM	11/2025
C	FAST TRACK APP	MKS	05/2025
B	FAST TRACK APP	RJM	04/2025
A	FAST TRACK APP	MKS	04/2025
Rev	Description	By	Date
		By	Date
Survey	MAVEN		05/2024
Design	MKS		04/2025
Drawn	MKS		04/2025
Checked	DJM		05/2025

M

MAVEN

**Maven Associates**  
09 571 0050  
info@maven.co.nz  
www.maven.co.nz  
5 Owens Road, Epsom  
Auckland 1023

Project

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Title

**PROPOSED  
WASTEWATER  
LONGSECTIONS**


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Cad file	C500-WASTEWATER.DWG		
Drawing no.	C520-13	Rev	D

RESOURCE CONSENT




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RESOURCE CONSENT

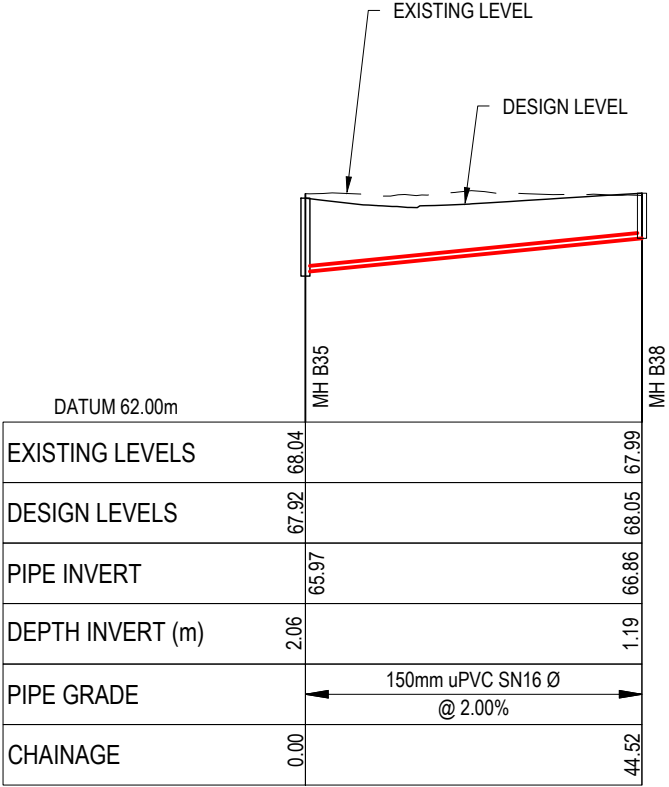

LONGSECTION - CATCHMENT B - LINE 13  
SCALE 1:1000 HORI & 1:200 VERTICAL @ A3

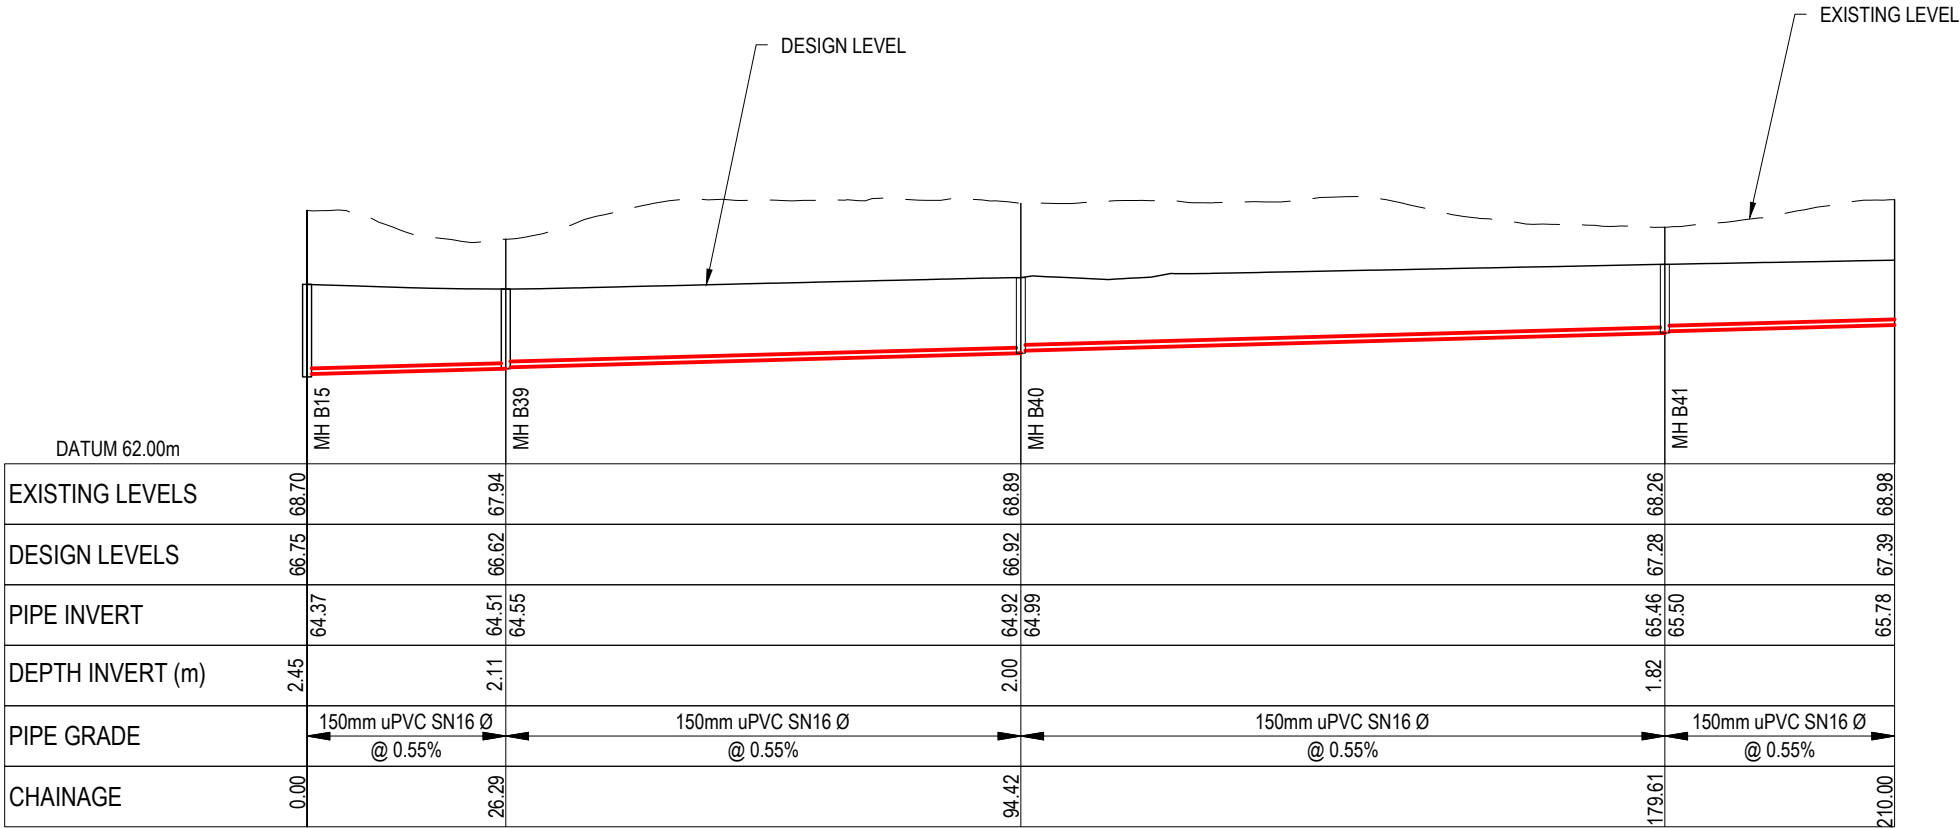

LONGSECTION - CATCHMENT B - LINE 14  
SCALE 1:1000 HORI & 1:200 VERTICAL @ A3

Notes

1.

All works to be in accordance with Waikato Regional Infrastructure Technical Specifications.

2.

Co-ordinates in terms of NZ Geodetic Datum Mount Eden 2000.

3.

Levels in terms of the New Zealand Vertical Datum 2016.

4.

It is the Contractors responsibility to locate all services that may be affected by his operations.

5.

Approved hardfill is to be used in backfilling of all road crossings to council standards.

6.

Heavy duty manhole lids and frames to be used in trafficked areas, all manholes shall have stainless grates installed.

7.

All lines are to be 150mmØ PVC Class SN16 unless shown otherwise.

8.

All lot connections are to be 100mmØ PVC unless shown otherwise.

9.

150mmØ pipes that do not terminate in a manhole must be terminated with a 100mmØ on a 150mmØ london junction and blank cap.

10.

Manhole diameters shown on structure label are internal diameter.

11.

Measurements shown on the lot connections are the distance from the centre of the downstream manhole to the lot connection position within the lot boundary.

12.

Manhole slab and cover to be rotated to avoid the footpath edge for manholes on footpath.

13.

Pipe lengths shown on plan are from upstream pipe invert to downstream pipe invert.

Legend

EX GROUND LEVEL

PROP GROUND LEVEL

D	FAST TRACK APP	RJM	11/2025
C	FAST TRACK APP	MKS	05/2025
B	FAST TRACK APP	RJM	04/2025
A	FAST TRACK APP	MKS	04/2025
Rev	Description	By	Date
		By	Date
Survey	MAVEN		05/2024
Design	MKS		04/2025
Drawn	MKS		04/2025
Checked	DJM		05/2025

M

MAVEN

Maven Associates

09 571 0050

info@maven.co.nz

www.maven.co.nz

5 Owens Road, Epsom

Auckland 1023

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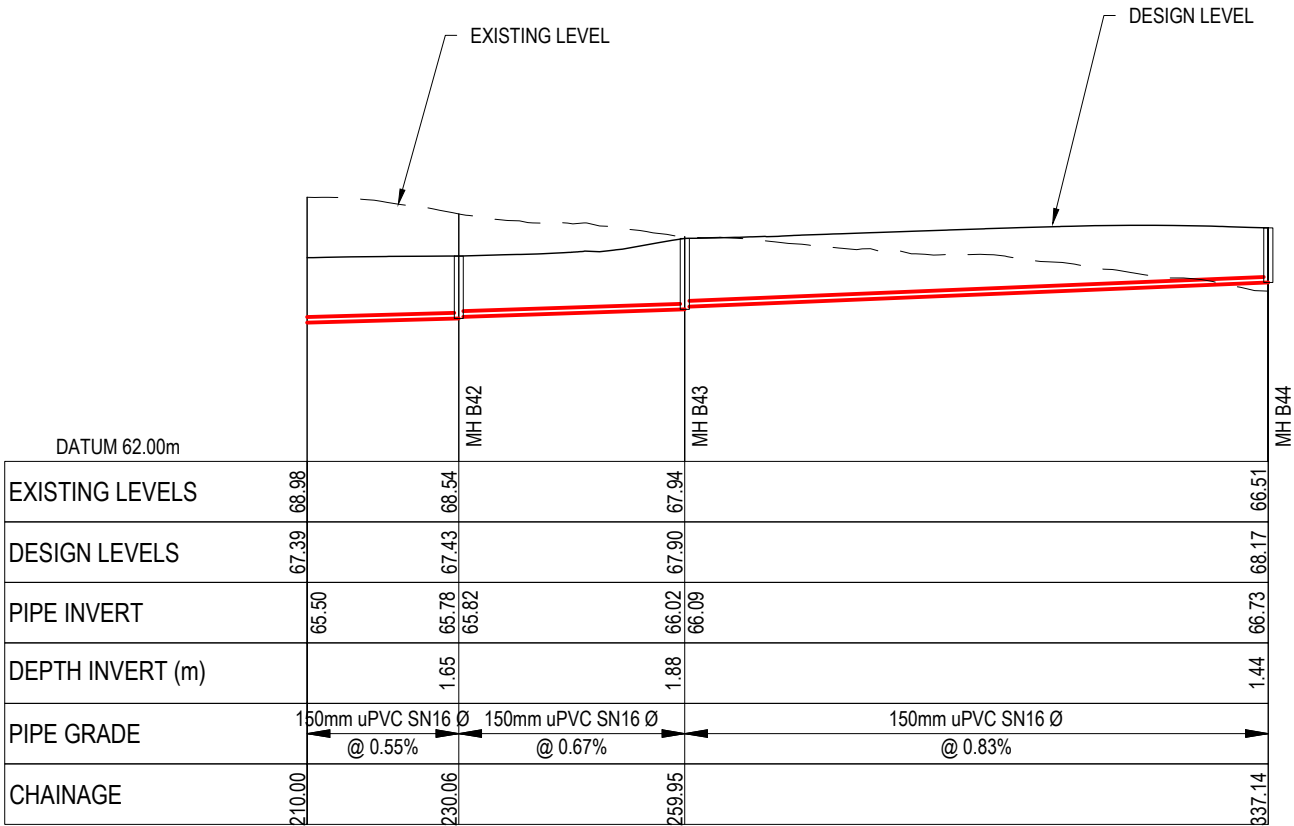
Title

PROPOSED  
WASTEWATER  
LONGSECTIONS


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Drawing no.	C520-14	Rev	D

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RESOURCE CONSENT



LONGSECTION - CATCHMENT B - LINE 14 CONT.  
SCALE 1:1000 HORI & 1:200 VERTICAL @ A3

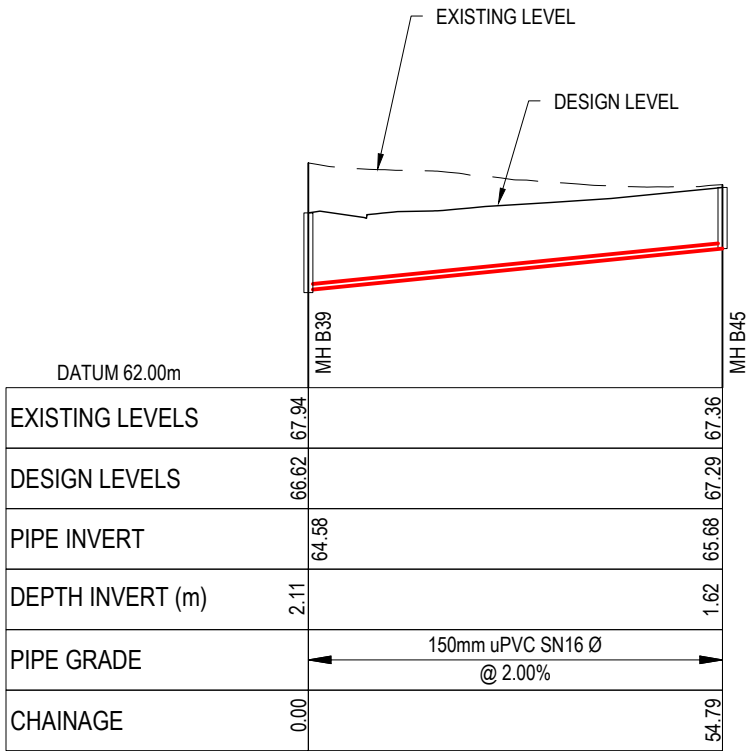

LONGSECTION - CATCHMENT B - LINE 15  
SCALE 1:1000 HORI & 1:200 VERTICAL @ A3

- Notes
1. All works to be in accordance with Waikato Regional Infrastructure Technical Specifications.
  2. Co-ordinates in terms of NZ Geodetic Datum Mount Eden 2000.
  3. Levels in terms of the New Zealand Vertical Datum 2016.
  4. It is the Contractors responsibility to locate all services that may be affected by his operations.
  5. Approved hardfill is to be used in backfilling of all road crossings to council standards.
  6. Heavy duty manhole lids and frames to be used in trafficked areas, all manholes shall have stainless grates installed.
  7. All lines are to be 150mmØ PVC Class SN16 unless shown otherwise.
  8. All lot connections are to be 100mmØ PVC unless shown otherwise.
  9. 150mmØ pipes that do not terminate in a manhole must be terminated with a 100mmØ on a 150mmØ london junction and blank cap.
  10. Manhole diameters shown on structure label are internal diameter.
  11. Measurements shown on the lot connections are the distance from the centre of the downstream manhole to the lot connection position within the lot boundary.
  12. Manhole slab and cover to be rotated to avoid the footpath edge for manholes on footpath.
  13. Pipe lengths shown on plan are from upstream pipe invert to downstream pipe invert.

Legend

EX GROUND LEVEL

PROP GROUND LEVEL

D	FAST TRACK APP	RJM	11/2025
C	FAST TRACK APP	MKS	05/2025
B	FAST TRACK APP	RJM	04/2025
A	FAST TRACK APP	MKS	04/2025
Rev	Description	By	Date
		By	Date
Survey	MAVEN		05/2024
Design	MKS		04/2025
Drawn	MKS		04/2025
Checked	DJM		05/2025

M

MAVEN

**Maven Associates**  
09 571 0050  
info@maven.co.nz  
www.maven.co.nz  
5 Owens Road, Epsom  
Auckland 1023

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Title


**PROPOSED  
WASTEWATER  
LONGSECTIONS**

Project no.	289001		
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Drawing no.	C520-15	Rev	<b>D</b>



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RESOURCE CONSENT

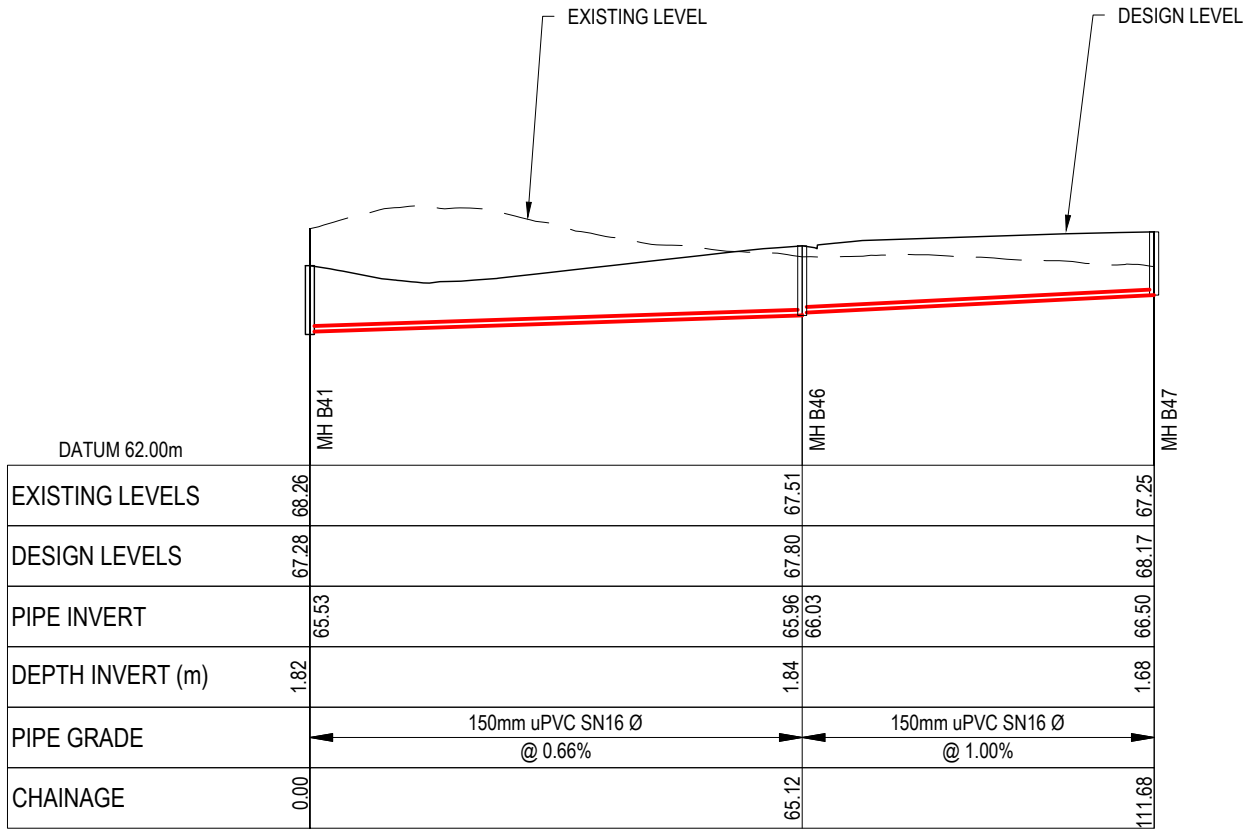

LONGSECTION - CATCHMENT B - LINE 16  
SCALE 1:1000 HORI & 1:200 VERTICAL @ A3

- Notes
1. All works to be in accordance with Waikato Regional Infrastructure Technical Specifications.
  2. Co-ordinates in terms of NZ Geodetic Datum Mount Eden 2000.
  3. Levels in terms of the New Zealand Vertical Datum 2016.
  4. It is the Contractors responsibility to locate all services that may be affected by his operations.
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  10. Manhole diameters shown on structure label are internal diameter.
  11. Measurements shown on the lot connections are the distance from the centre of the downstream manhole to the lot connection position within the lot boundary.
  12. Manhole slab and cover to be rotated to avoid the footpath edge for manholes on footpath.
  13. Pipe lengths shown on plan are from upstream pipe invert to downstream pipe invert.
- Legend
- EX GROUND LEVEL
- PROP GROUND LEVEL

D	FAST TRACK APP	RJM	11/2025
C	FAST TRACK APP	MKS	05/2025
B	FAST TRACK APP	RJM	04/2025
A	FAST TRACK APP	MKS	04/2025
Rev	Description	By	Date
	By	Date	
Survey	MAVEN	05/2024	
Design	MKS	04/2025	
Drawn	MKS	04/2025	
Checked	DJM	05/2025	

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Maven Associates

09 571 0050

info@maven.co.nz

www.maven.co.nz


5 Owens Road, Epsom

Auckland 1023

Project			
ASHBOURNE RESIDENTIAL FOR MATAMATA DEVELOPMENTS LTD			
Title			
PROPOSED WASTEWATER LONGSECTIONS			
Project no.	289001		
Scale	AS SHOWN		
Cad file	C500-WASTEWATER.DWG		
Drawing no.	C520-16	Rev	D

DATE: 11/11/25 FILE PATH: F:\MAVEN\HAMILTON\6 PROJECTS\289001 - STATION ROAD\7 DRAWING\11 ASHBOURNE RESIDENTIAL\CS500\WASTEWATER.DWG

RESOURCE CONSENT

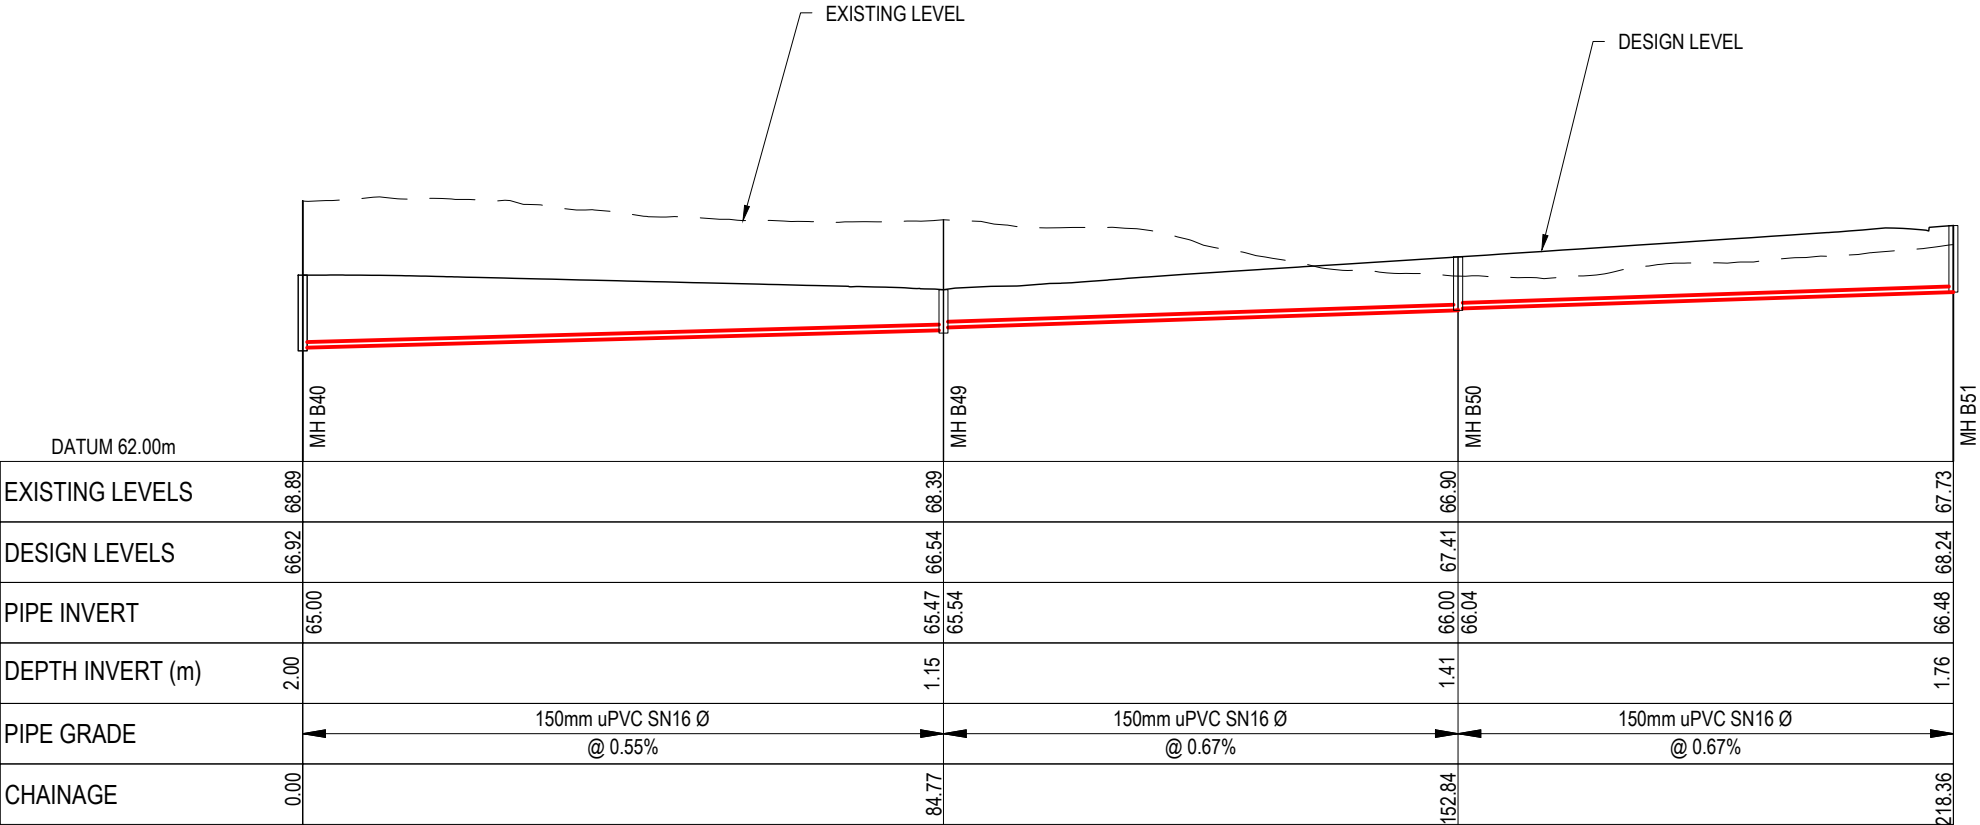

LONGSECTION - CATCHMENT B - LINE 18  
SCALE 1:1000 HORI & 1:200 VERTICAL @ A3

- Notes
1. All works to be in accordance with Waikato Regional Infrastructure Technical Specifications.
  2. Co-ordinates in terms of NZ Geodetic Datum Mount Eden 2000.
  3. Levels in terms of the New Zealand Vertical Datum 2016.
  4. It is the Contractors responsibility to locate all services that may be affected by his operations.
  5. Approved hardfill is to be used in backfilling of all road crossings to council standards.
  6. Heavy duty manhole lids and frames to be used in trafficked areas, all manholes shall have stainless grates installed.
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  8. All lot connections are to be 100mmØ PVC unless shown otherwise.
  9. 150mmØ pipes that do not terminate in a manhole must be terminated with a 100mmØ on a 150mmØ london junction and blank cap.
  10. Manhole diameters shown on structure label are internal diameter.
  11. Measurements shown on the lot connections are the distance from the centre of the downstream manhole to the lot connection position within the lot boundary.
  12. Manhole slab and cover to be rotated to avoid the footpath edge for manholes on footpath.
  13. Pipe lengths shown on plan are from upstream pipe invert to downstream pipe invert.

Legend

EX GROUND LEVEL

PROP GROUND LEVEL

D	FAST TRACK APP	RJM	11/2025
C	FAST TRACK APP	MKS	05/2025
B	FAST TRACK APP	RJM	04/2025
A	FAST TRACK APP	MKS	04/2025
Rev	Description	By	Date
	By	Date	
Survey	MAVEN	05/2024	
Design	MKS	04/2025	
Drawn	MKS	04/2025	
Checked	DJM	05/2025	

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MAVEN

**Maven Associates**  
09 571 0050  
info@maven.co.nz  
www.maven.co.nz  
5 Owens Road, Epsom  
Auckland 1023

Project

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RESIDENTIAL  
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DEVELOPMENTS LTD**


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**PROPOSED  
WASTEWATER  
LONGSECTIONS**

Project no.	289001		
Scale	AS SHOWN		
Cad file	C500-WASTEWATER.DWG		
Drawing no.	C520-17	Rev	<b>D</b>



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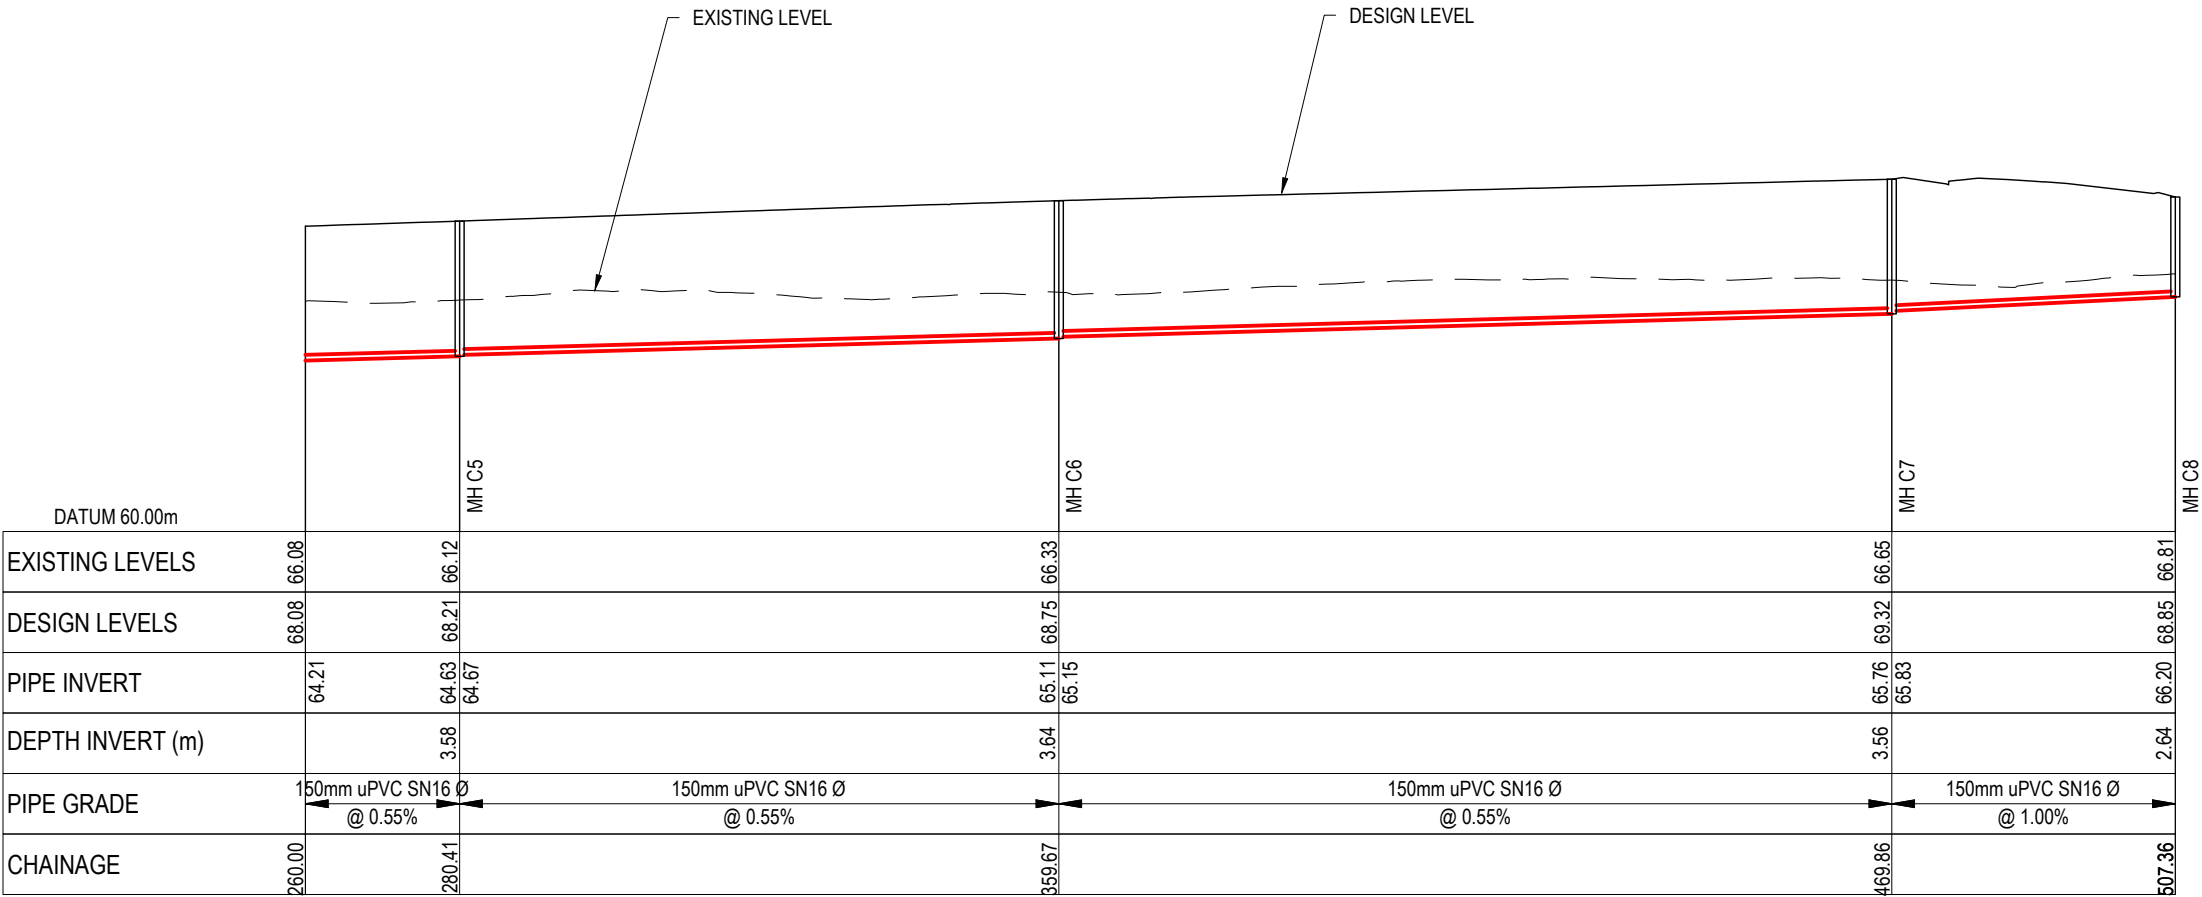
LONGSECTION - CATCHMENT C - LINE 1  
SCALE 1:1000 HORI & 1:200 VERTICAL @ A3

- Notes
1. All works to be in accordance with Waikato Regional Infrastructure Technical Specifications.
  2. Co-ordinates in terms of NZ Geodetic Datum Mount Eden 2000.
  3. Levels in terms of the New Zealand Vertical Datum 2016.
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  8. All lot connections are to be 100mmØ PVC unless shown otherwise.
  9. 150mmØ pipes that do not terminate in a manhole must be terminated with a 100mmØ on a 150mmØ london junction and blank cap.
  10. Manhole diameters shown on structure label are internal diameter.
  11. Measurements shown on the lot connections are the distance from the centre of the downstream manhole to the lot connection position within the lot boundary.
  12. Manhole slab and cover to be rotated to avoid the footpath edge for manholes on footpath.
  13. Pipe lengths shown on plan are from upstream pipe invert to downstream pipe invert.

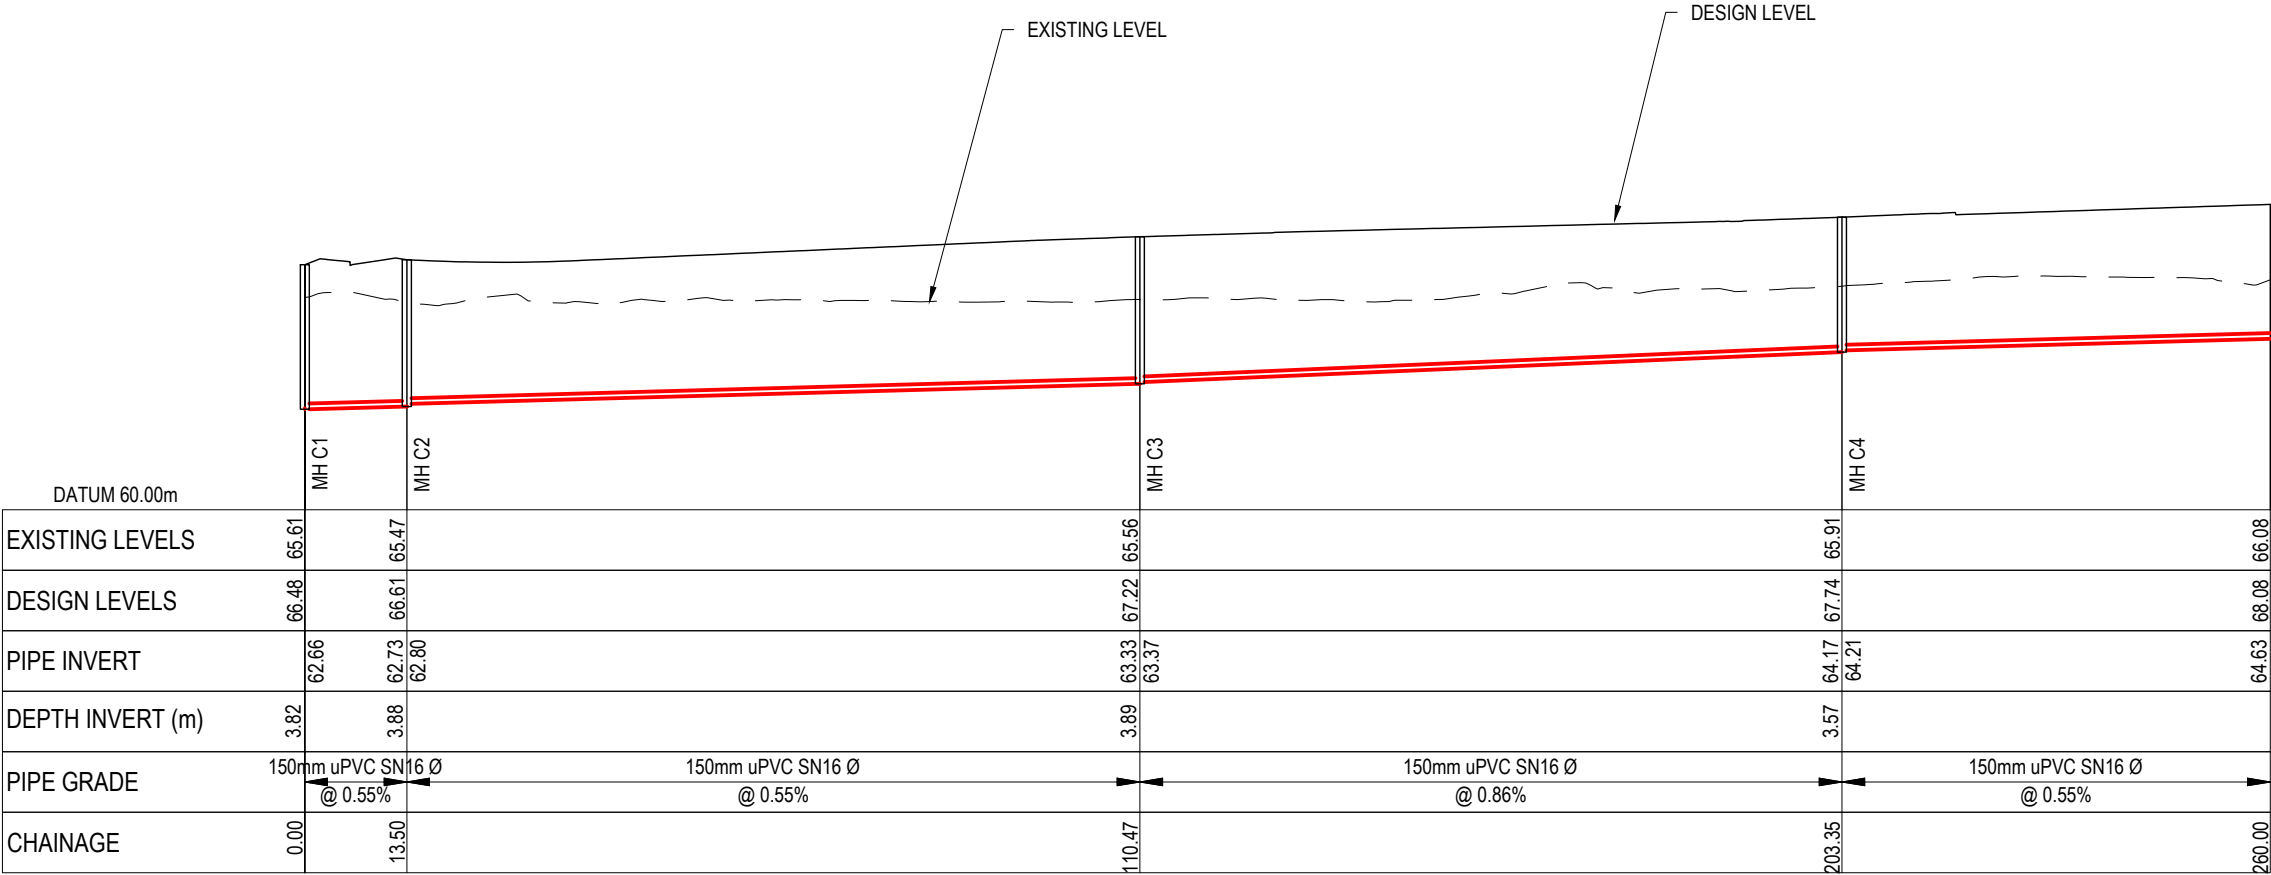Legend

EX GROUND LEVEL

PROP GROUND LEVEL



LONGSECTION - CATCHMENT C - LINE 1 CONT.  
SCALE 1:1000 HORI & 1:200 VERTICAL @ A3

RESOURCE CONSENT

D	FAST TRACK APP	RJM	11/2025
C	FAST TRACK APP	MKS	05/2025
B	FAST TRACK APP	RJM	04/2025
A	FAST TRACK APP	MKS	04/2025
Rev	Description	By	Date
		By	Date
Survey	MAVEN		05/2024
Design	MKS		04/2025
Drawn	MKS		04/2025
Checked	DJM		05/2025



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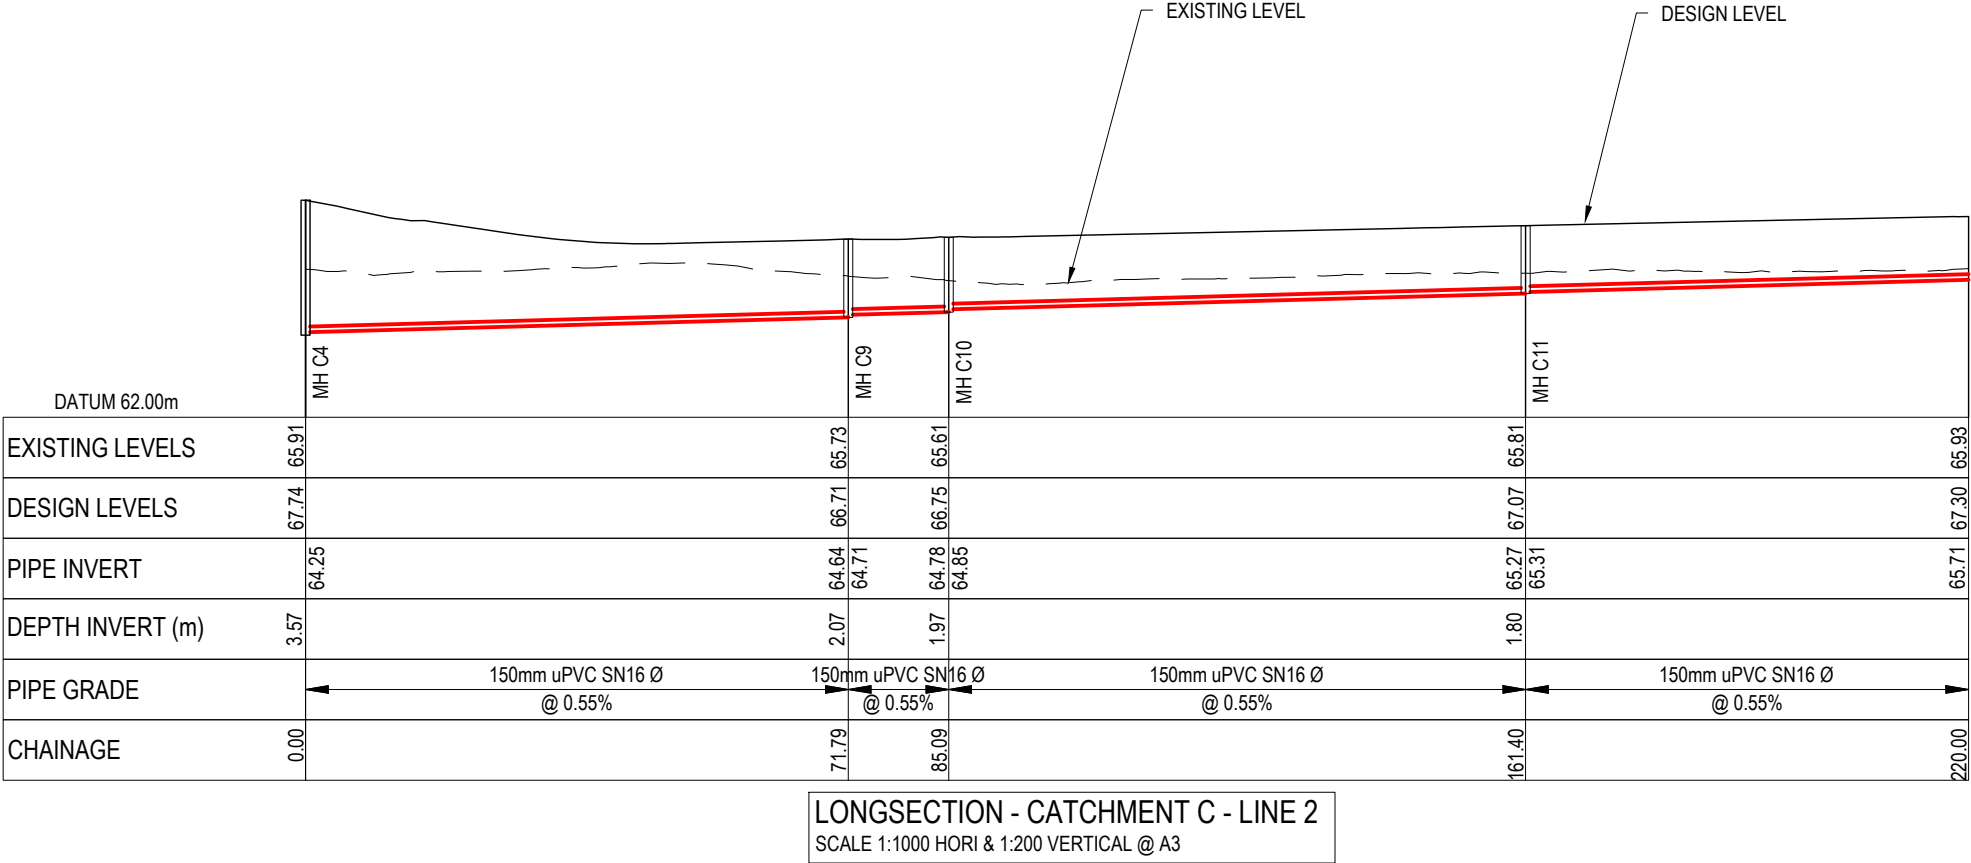
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**PROPOSED  
WASTEWATER  
LONGSECTIONS**


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Drawing no.	C520-18	Rev	<b>D</b>

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RESOURCE CONSENT



- Notes
1. All works to be in accordance with Waikato Regional Infrastructure Technical Specifications.
  2. Co-ordinates in terms of NZ Geodetic Datum Mount Eden 2000.
  3. Levels in terms of the New Zealand Vertical Datum 2016.
  4. It is the Contractors responsibility to locate all services that may be affected by his operations.
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  8. All lot connections are to be 100mmØ PVC unless shown otherwise.
  9. 150mmØ pipes that do not terminate in a manhole must be terminated with a 100mmØ on a 150mmØ london junction and blank cap.
  10. Manhole diameters shown on structure label are internal diameter.
  11. Measurements shown on the lot connections are the distance from the centre of the downstream manhole to the lot connection position within the lot boundary.
  12. Manhole slab and cover to be rotated to avoid the footpath edge for manholes on footpath.
  13. Pipe lengths shown on plan are from upstream pipe invert to downstream pipe invert.
- Legend
- EX GROUND LEVEL  
PROP GROUND LEVEL

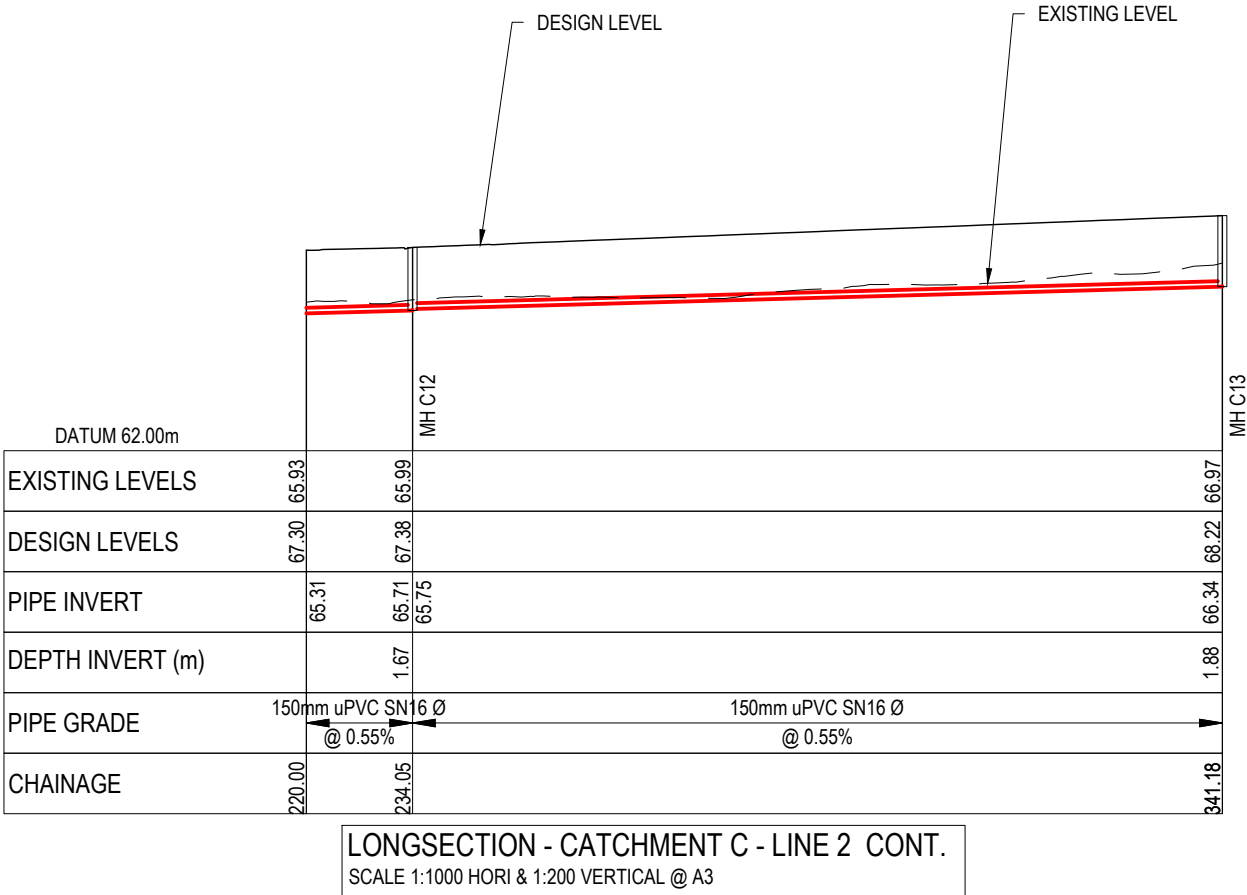

D	FAST TRACK APP	RJM	11/2025
C	FAST TRACK APP	MKS	05/2025
B	FAST TRACK APP	RJM	04/2025
A	FAST TRACK APP	MKS	04/2025
Rev	Description	By	Date
		By	Date
Survey	MAVEN		05/2024
Design	MKS		04/2025
Drawn	MKS		04/2025
Checked	DJM		05/2025

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Maven Associates

09 571 0050

info@maven.co.nz

www.maven.co.nz


5 Owens Road, Epsom

Auckland 1023


Project			
ASHBOURNE RESIDENTIAL FOR MATAMATA DEVELOPMENTS LTD			
Title			
PROPOSED WASTEWATER LONGSECTIONS			
Project no.	289001		
Scale	AS SHOWN		
Cad file	C500-WASTEWATER.DWG		
Drawing no.	C520-19	Rev	D

DATE: 11/17/25 FILE PATH: F:\MAVEN\HAMILTON\6 PROJECTS\289001 - STATION ROAD\7 DRAWING\11 ASHBOURNE RESIDENTIAL\CS500\WASTEWATER.DWG

RESOURCE CONSENT

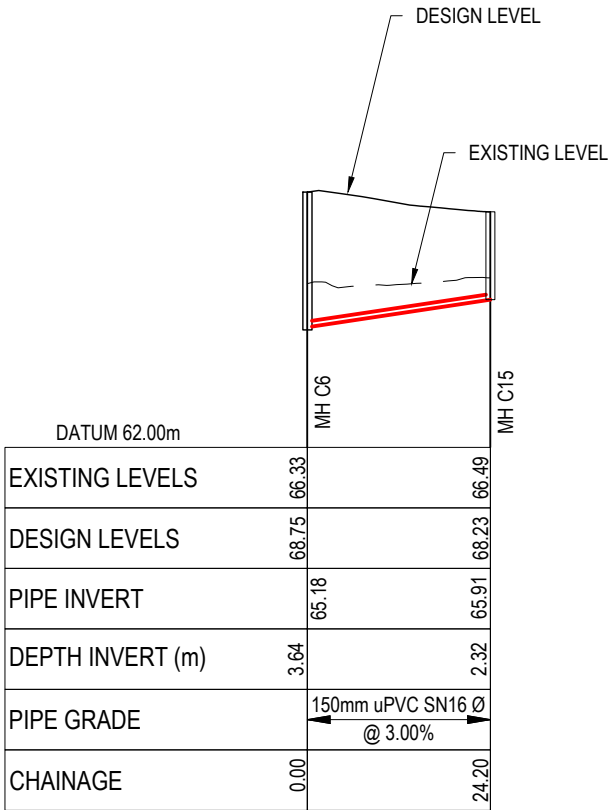

LONGSECTION - CATCHMENT C - LINE 3  
SCALE 1:1000 HORI & 1:200 VERTICAL @ A3

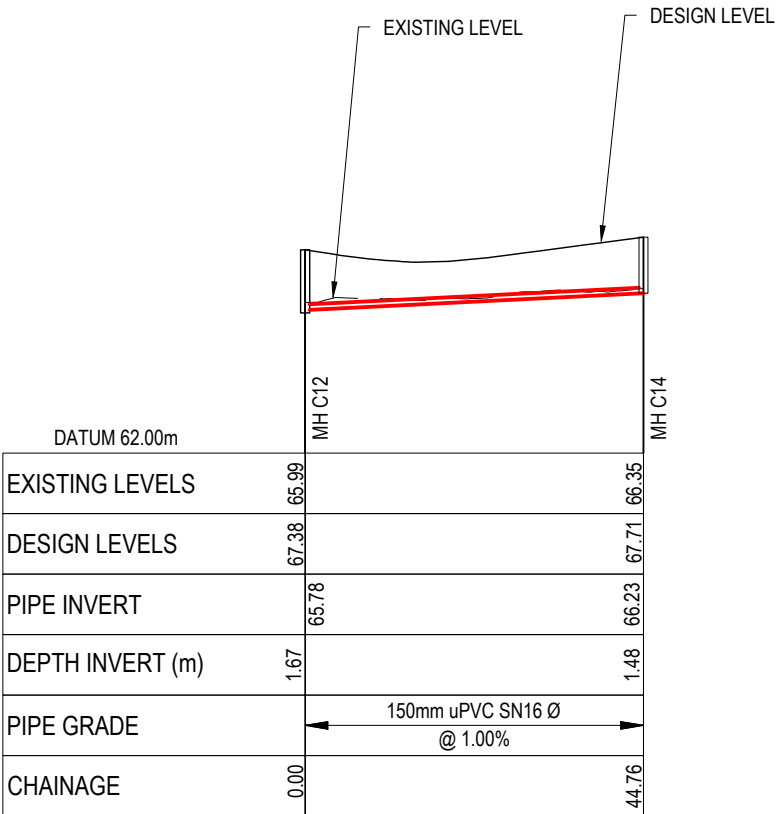

LONGSECTION - CATCHMENT C - LINE 4  
SCALE 1:1000 HORI & 1:200 VERTICAL @ A3

- Notes
1. All works to be in accordance with Waikato Regional Infrastructure Technical Specifications.
  2. Co-ordinates in terms of NZ Geodetic Datum Mount Eden 2000.
  3. Levels in terms of the New Zealand Vertical Datum 2016.
  4. It is the Contractors responsibility to locate all services that may be affected by his operations.
  5. Approved hardfill is to be used in backfilling of all road crossings to council standards.
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  8. All lot connections are to be 100mmØ PVC unless shown otherwise.
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  10. Manhole diameters shown on structure label are internal diameter.
  11. Measurements shown on the lot connections are the distance from the centre of the downstream manhole to the lot connection position within the lot boundary.
  12. Manhole slab and cover to be rotated to avoid the footpath edge for manholes on footpath.
  13. Pipe lengths shown on plan are from upstream pipe invert to downstream pipe invert.

Legend

EX GROUND LEVEL  
PROP GROUND LEVEL

D	FAST TRACK APP	RJM	11/2025
C	FAST TRACK APP	MKS	05/2025
B	FAST TRACK APP	RJM	04/2025
A	FAST TRACK APP	MKS	04/2025
Rev	Description	By	Date
		By	Date
Survey	MAVEN		05/2024
Design	MKS		04/2025
Drawn	MKS		04/2025
Checked	DJM		05/2025

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MAVEN

Maven Associates

09 571 0050

info@maven.co.nz

www.maven.co.nz

5 Owens Road, Epsom

Auckland 1023

Project

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FOR  
MATAMATA  
DEVELOPMENTS LTD**


Title

**PROPOSED  
WASTEWATER  
LONGSECTIONS**

Project no.	289001		
Scale	AS SHOWN		
Cad file	C500-WASTEWATER.DWG		
Drawing no.	C520-20	Rev	D



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LONGSECTION - CATCHMENT C - LINE 5  
SCALE 1:1000 HORI & 1:200 VERTICAL @ A3

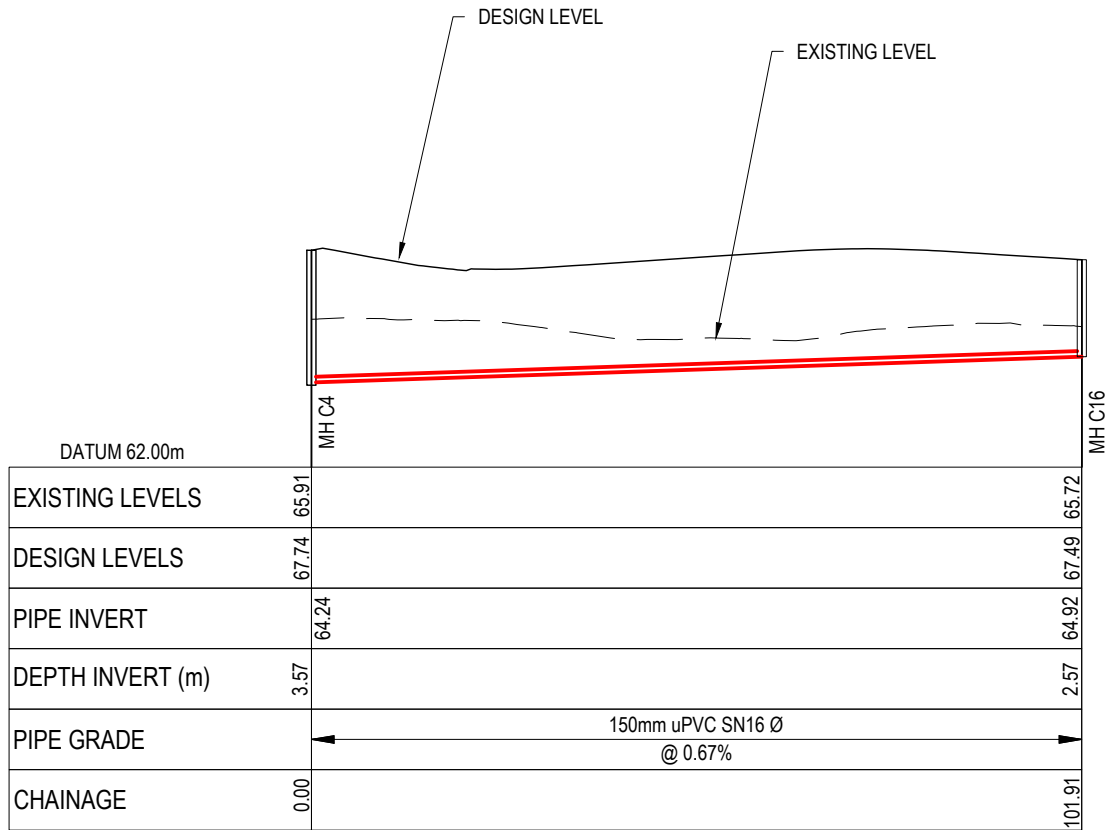- Notes
- All works to be in accordance with Waikato Regional Infrastructure Technical Specifications.
  - Co-ordinates in terms of NZ Geodetic Datum Mount Eden 2000.
  - Levels in terms of the New Zealand Vertical Datum 2016.
  - It is the Contractors responsibility to locate all services that may be affected by his operations.
  - Approved hardfill is to be used in backfilling of all road crossings to council standards.
  - Heavy duty manhole lids and frames to be used in trafficked areas, all manholes shall have stainless grates installed.
  - All lines are to be 150mmØ PVC Class SN16 unless shown otherwise.
  - All lot connections are to be 100mmØ PVC unless shown otherwise.
  - 150mmØ pipes that do not terminate in a manhole must be terminated with a 100mmØ on a 150mmØ london junction and blank cap.
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  - Measurements shown on the lot connections are the distance from the centre of the downstream manhole to the lot connection position within the lot boundary.
  - Manhole slab and cover to be rotated to avoid the footpath edge for manholes on footpath.
  - Pipe lengths shown on plan are from upstream pipe invert to downstream pipe invert.
- Legend
- EX GROUND LEVEL
  - PROP GROUND LEVEL


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C	FAST TRACK APP	MKS	05/2025
B	FAST TRACK APP	RJM	04/2025
A	FAST TRACK APP	MKS	04/2025
Rev	Description	By	Date
		By	Date
Survey	MAVEN		05/2024
Design	MKS		04/2025
Drawn	MKS		04/2025
Checked	DJM		05/2025



Project  
**ASHBOURNE  
RESIDENTIAL  
FOR  
MATAMATA  
DEVELOPMENTS LTD**

Title  
**PROPOSED  
WASTEWATER  
LONGSECTIONS**

Project no.	289001		
Scale	AS SHOWN		
Cad file	C500-WASTEWATER.DWG		
Drawing no.	C520-21	Rev	<b>D</b>

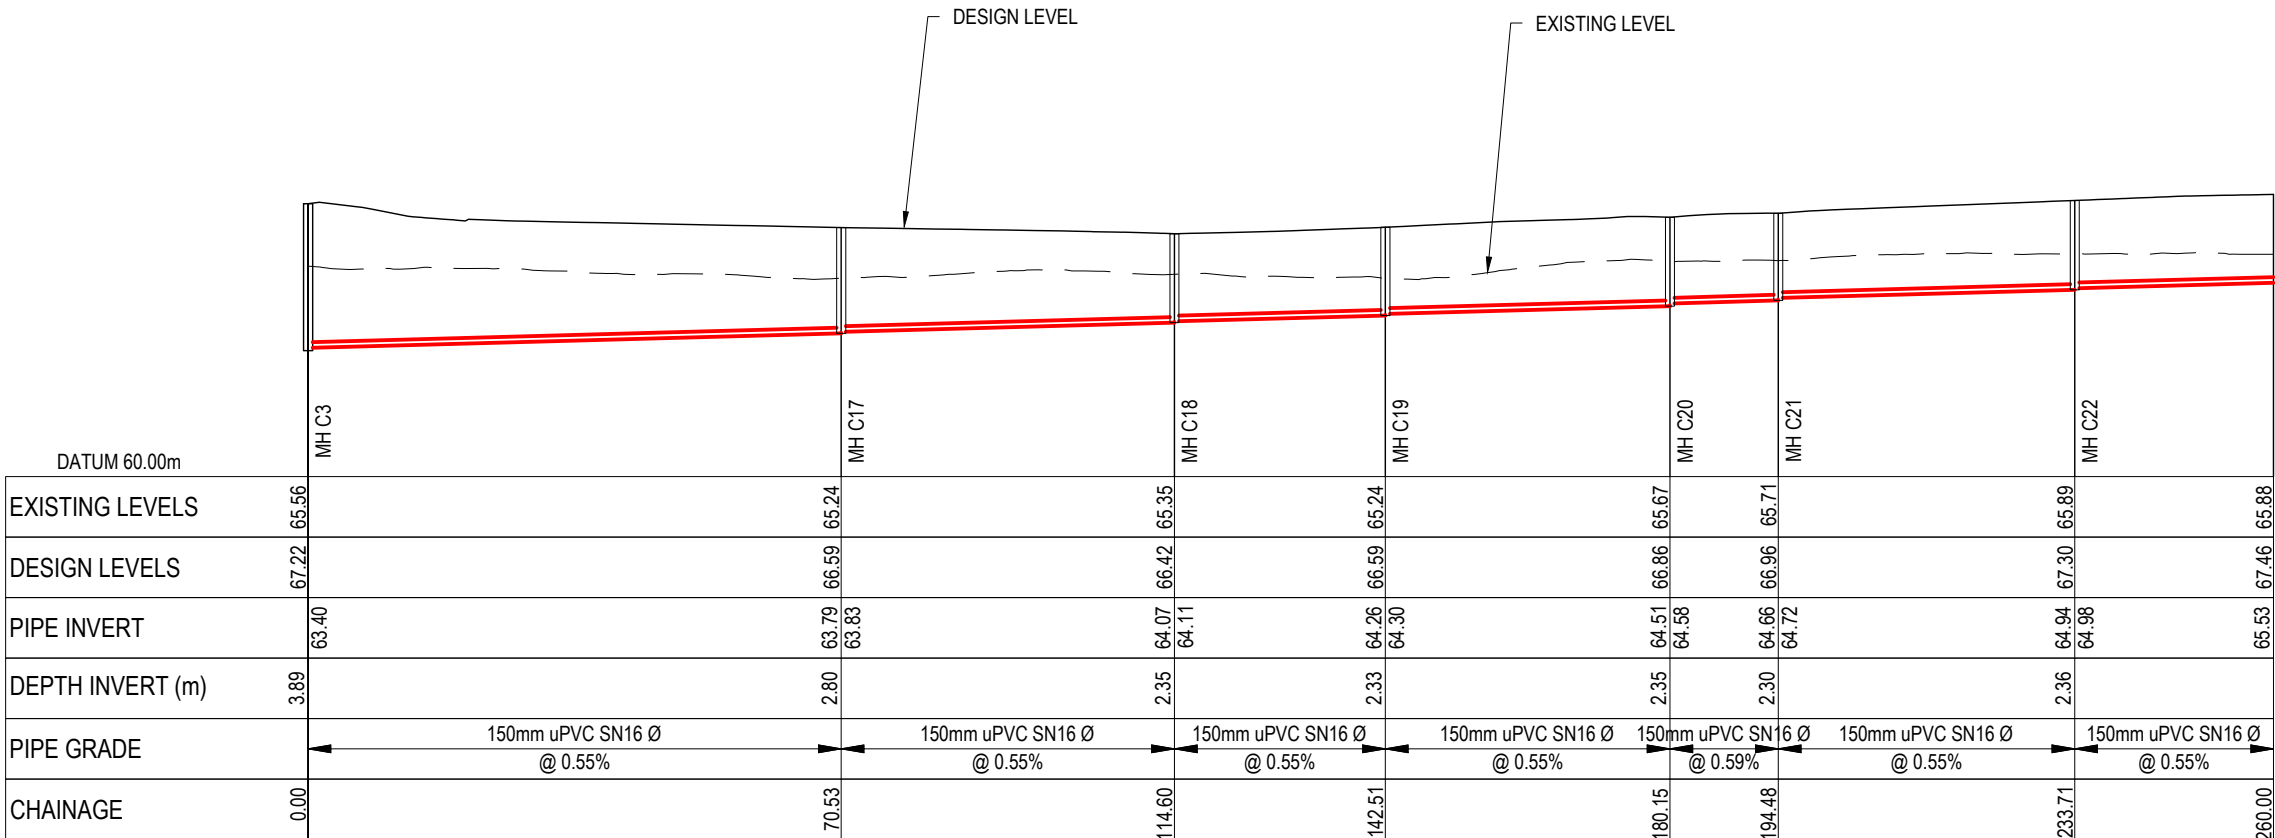


LONGSECTION - CATCHMENT C - LINE 6  
SCALE 1:1000 HORI & 1:200 VERTICAL @ A3


RESOURCE CONSENT

DATE: 11/17/25 FILE PATH: F:\MAVEN\HAM1046 PROJECTS\289001 - STATION ROAD\7 DRAWING\11 ASHBOURNE RESIDENTIAL\CS500\WASTEWATER.DWG

RESOURCE CONSENT

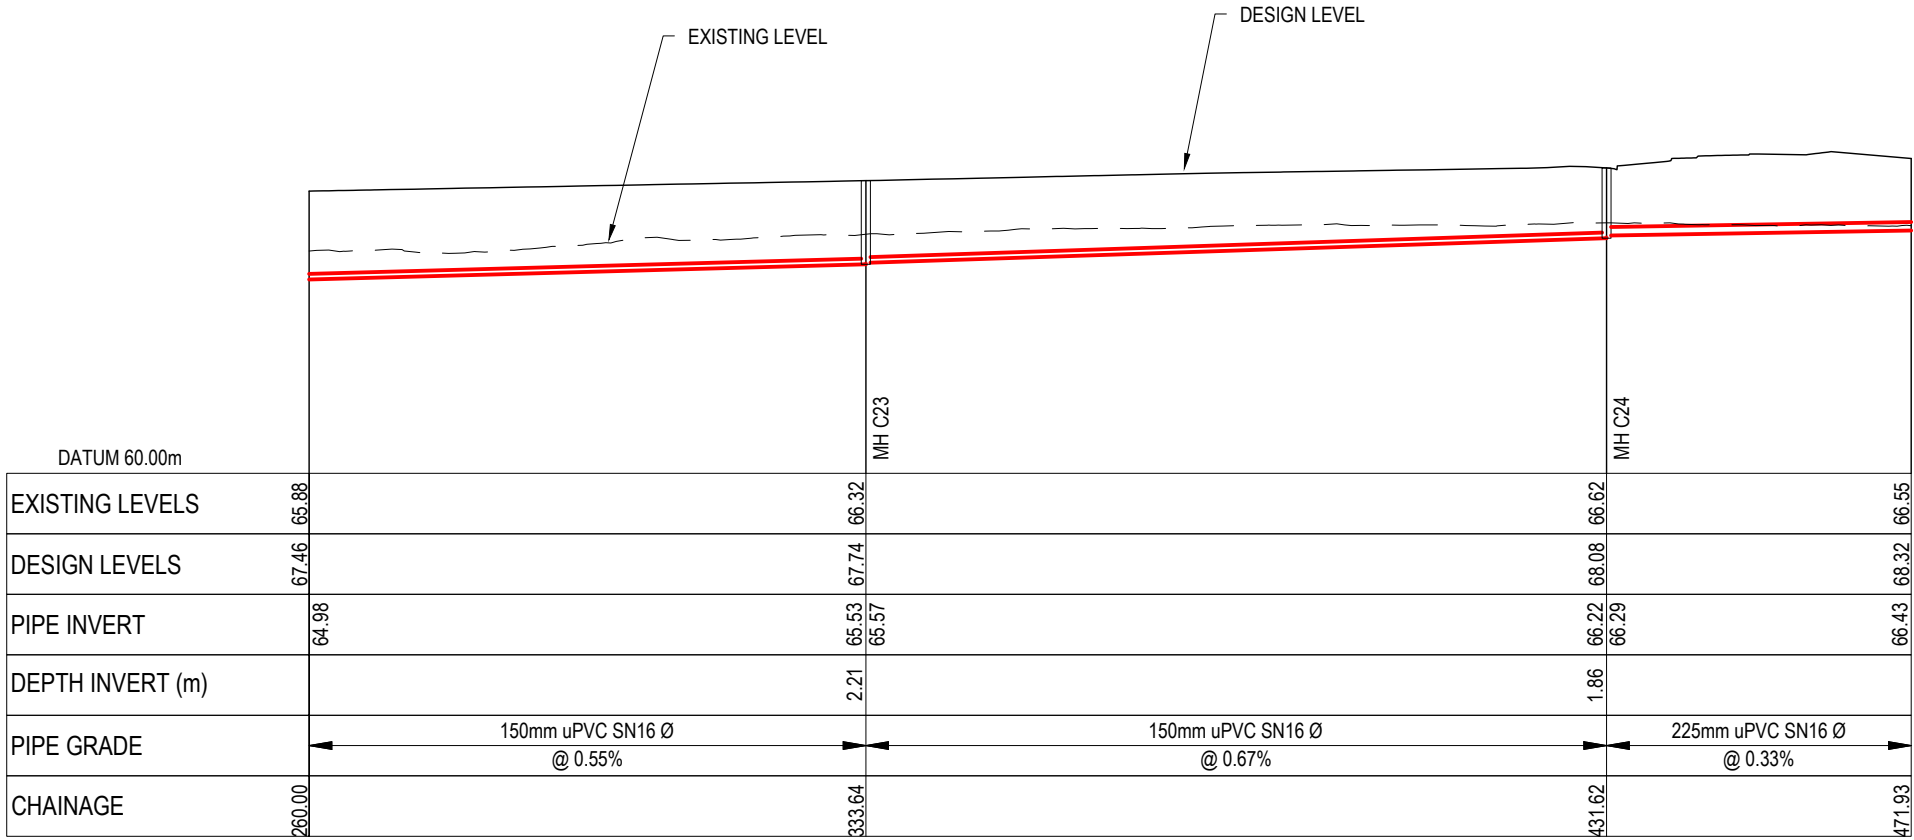

LONGSECTION - CATCHMENT C - LINE 6 CONT.  
SCALE 1:1000 HORI & 1:200 VERTICAL @ A3

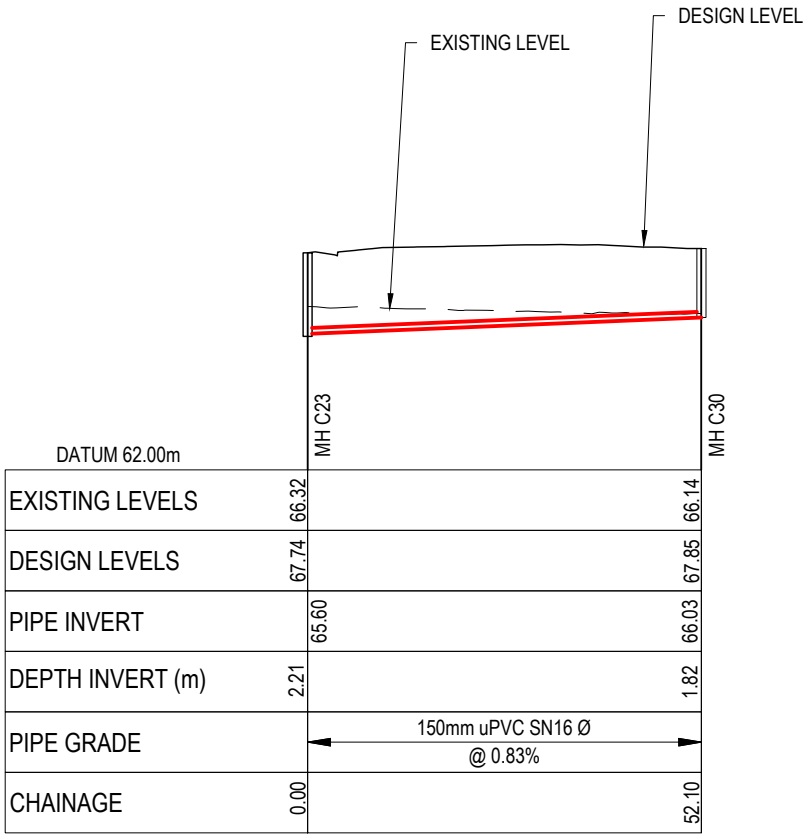

LONGSECTION - CATCHMENT C - LINE 7  
SCALE 1:1000 HORI & 1:200 VERTICAL @ A3

- Notes
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  - Co-ordinates in terms of NZ Geodetic Datum Mount Eden 2000.
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  - Pipe lengths shown on plan are from upstream pipe invert to downstream pipe invert.

Legend

EX GROUND LEVEL

PROP GROUND LEVEL

D	FAST TRACK APP	RJM	11/2025
C	FAST TRACK APP	MKS	05/2025
B	FAST TRACK APP	RJM	04/2025
A	FAST TRACK APP	MKS	04/2025
Rev	Description	By	Date
		By	Date
Survey	MAVEN		05/2024
Design	MKS		04/2025
Drawn	MKS		04/2025
Checked	DJM		05/2025



Project

**ASHBOURNE  
RESIDENTIAL  
FOR  
MATAMATA  
DEVELOPMENTS LTD**


Title

**PROPOSED  
WASTEWATER  
LONGSECTIONS**

Project no.	289001		
Scale	AS SHOWN		
Cad file	C500-WASTEWATER.DWG		
Drawing no.	C520-22	Rev	D

DATE: 11/17/25 FILE PATH: F:\MAVEN\HAMILTON\6 PROJECTS\289001 - STATION ROAD\7 DRAWING\11 ASHBOURNE RESIDENTIAL\CS500\WASTEWATER.DWG

RESOURCE CONSENT

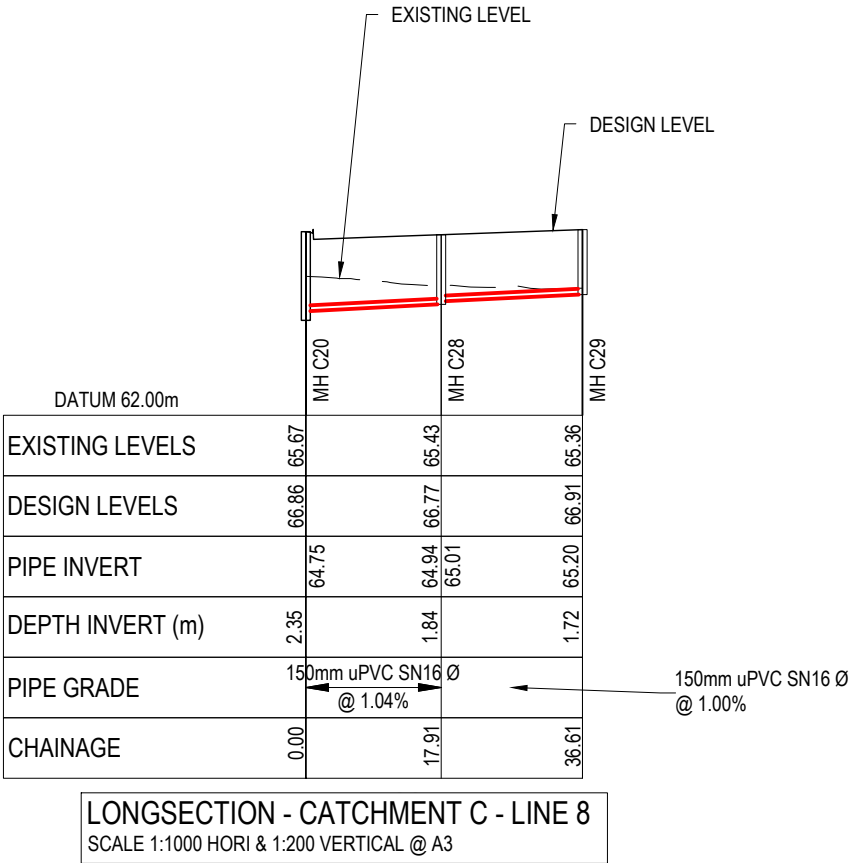

- Notes
1. All works to be in accordance with Waikato Regional Infrastructure Technical Specifications.
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  3. Levels in terms of the New Zealand Vertical Datum 2016.
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  13. Pipe lengths shown on plan are from upstream pipe invert to downstream pipe invert.
- Legend
- EX GROUND LEVEL
- PROP GROUND LEVEL

D	FAST TRACK APP	RJM	11/2025
C	FAST TRACK APP	MKS	05/2025
B	FAST TRACK APP	RJM	04/2025
A	FAST TRACK APP	MKS	04/2025
Rev	Description	By	Date
	By	Date	
Survey	MAVEN	05/2024	
Design	MKS	04/2025	
Drawn	MKS	04/2025	
Checked	DJM	05/2025	

M

MAVEN

Maven Associates

09 571 0050

info@maven.co.nz

www.maven.co.nz

5 Owens Road, Epsom


Auckland 1023

Project			
ASHBOURNE RESIDENTIAL FOR MATAMATA DEVELOPMENTS LTD			
Title			
PROPOSED WASTEWATER LONGSECTIONS			
Project no.	289001		
Scale	AS SHOWN		
Cad file	C500-WASTEWATER.DWG		
Drawing no.	C520-23	Rev	D




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RESOURCE CONSENT

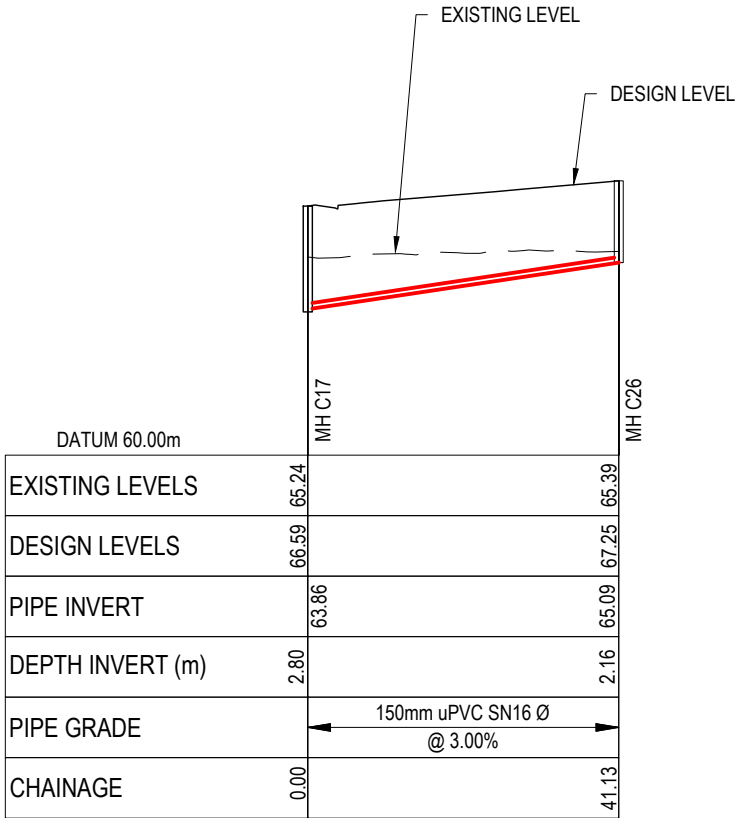

LONGSECTION - CATCHMENT C - LINE 10  
SCALE 1:1000 HORI & 1:200 VERTICAL @ A3

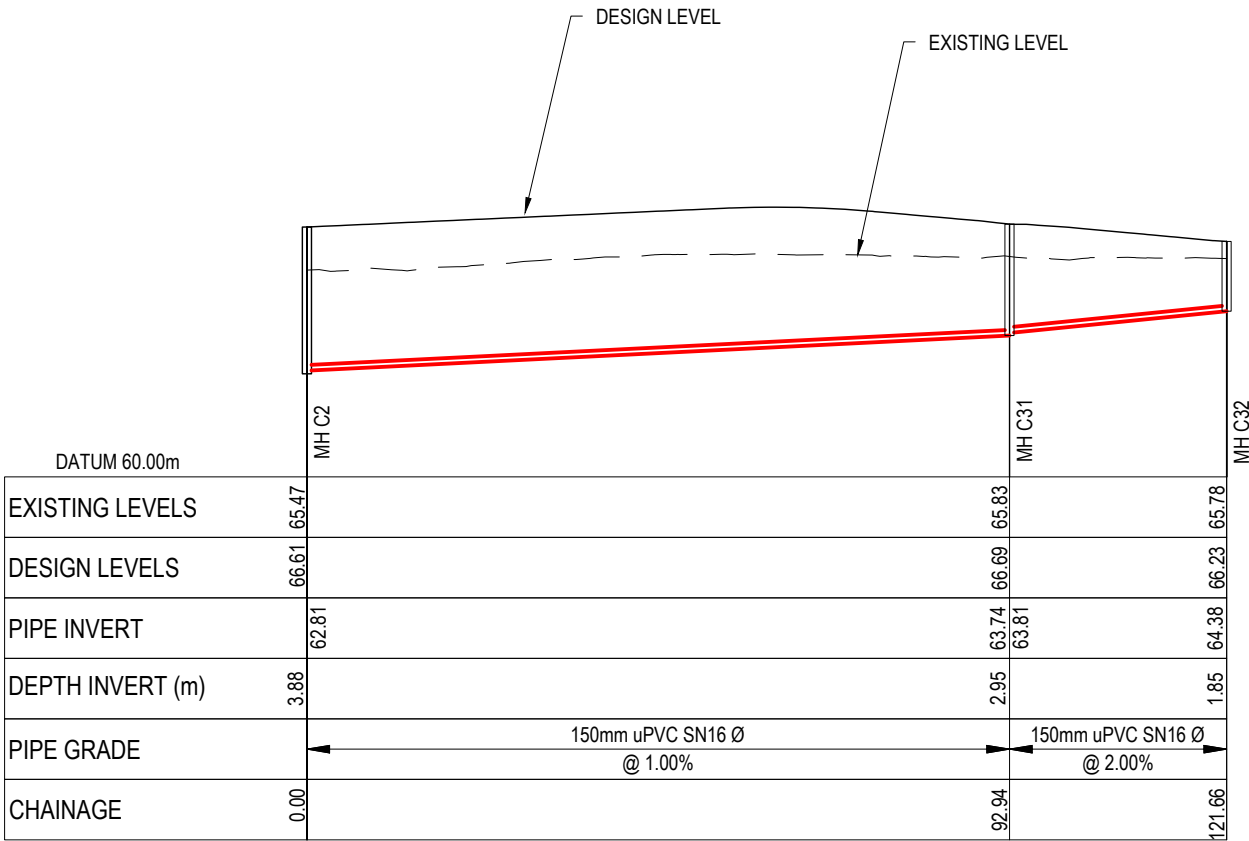

LONGSECTION - CATCHMENT C - LINE 11  
SCALE 1:1000 HORI & 1:200 VERTICAL @ A3

- Notes
1. All works to be in accordance with Waikato Regional Infrastructure Technical Specifications.
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Legend

EX GROUND LEVEL

PROP GROUND LEVEL

D	FAST TRACK APP	RJM	11/2025
C	FAST TRACK APP	MKS	05/2025
B	FAST TRACK APP	RJM	04/2025
A	FAST TRACK APP	MKS	04/2025
Rev	Description	By	Date
		By	Date
Survey	MAVEN		05/2024
Design	MKS		04/2025
Drawn	MKS		04/2025
Checked	DJM		05/2025

M

MAVEN

Maven Associates

09 571 0050

info@maven.co.nz

www.maven.co.nz

5 Owens Road, Epsom

Auckland 1023

Project

**ASHBOURNE  
RESIDENTIAL  
FOR  
MATAMATA  
DEVELOPMENTS LTD**

Title

**PROPOSED  
WASTEWATER  
LONGSECTIONS**

Project no.	289001		
Scale	AS SHOWN		
Cad file	C500-WASTEWATER.DWG		
Drawing no.	C520-24	Rev	D



STATION ROAD

STATION ROAD

NORTHERN WASTEWATER PUMP  
STATION REFER TO C535  
DRAWING SERIES FOR DETAILS

EXISTING WASTEWATER MANHOLE 1050mmØ  
ASSET ID: 300027

CENTRAL WASTEWATER PUMP STATION  
DISCHARGE MANHOLE REFER TO  
DRAWING C530-3 FOR DETAILS

CENTRAL WASTEWATER  
PUMP STATION REFER TO  
C530 DRAWING SERIES  
FOR DETAILS

LOT 1 DP 463448

RESOURCE CONSENT

- Notes
1. All works to be in accordance with Waikato Regional Infrastructure Technical Specifications.
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Legend	
	EX BOUNDARY
	PROP BOUNDARY
	EX WASTEWATER
	PR WASTEWATER
	EX/PROP WWMH
	WW LOT CONNECTION

D	FAST TRACK APP	RJM	11/2025
C	FAST TRACK APP	TCH	05/2025
B	FAST TRACK APP	TCH	05/2025
A	FAST TRACK APP	TCH	04/2025
Rev	Description	By	Date
Survey	MAVEN		05/2024
Design	TCH		04/2025
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Checked	DJM		04/2025




**Maven Associates**  
09 571 0050  
info@maven.co.nz  
www.maven.co.nz  
5 Owens Road, Epsom  
Auckland 1023

Project  
**ASHBOURNE  
RESIDENTIAL  
FOR  
MATAMATA  
DEVELOPMENTS LTD**

Title  
**PROPOSED  
WASTEWATER PUMP  
STATIONS OVERVIEW PLAN**

Project no.	289001		
Scale	1:7000 @ A3		
Cad file	C530-WASTEWATER-PUMP STATION.DWG		
Drawing no.	C530	Rev	<b>D</b>



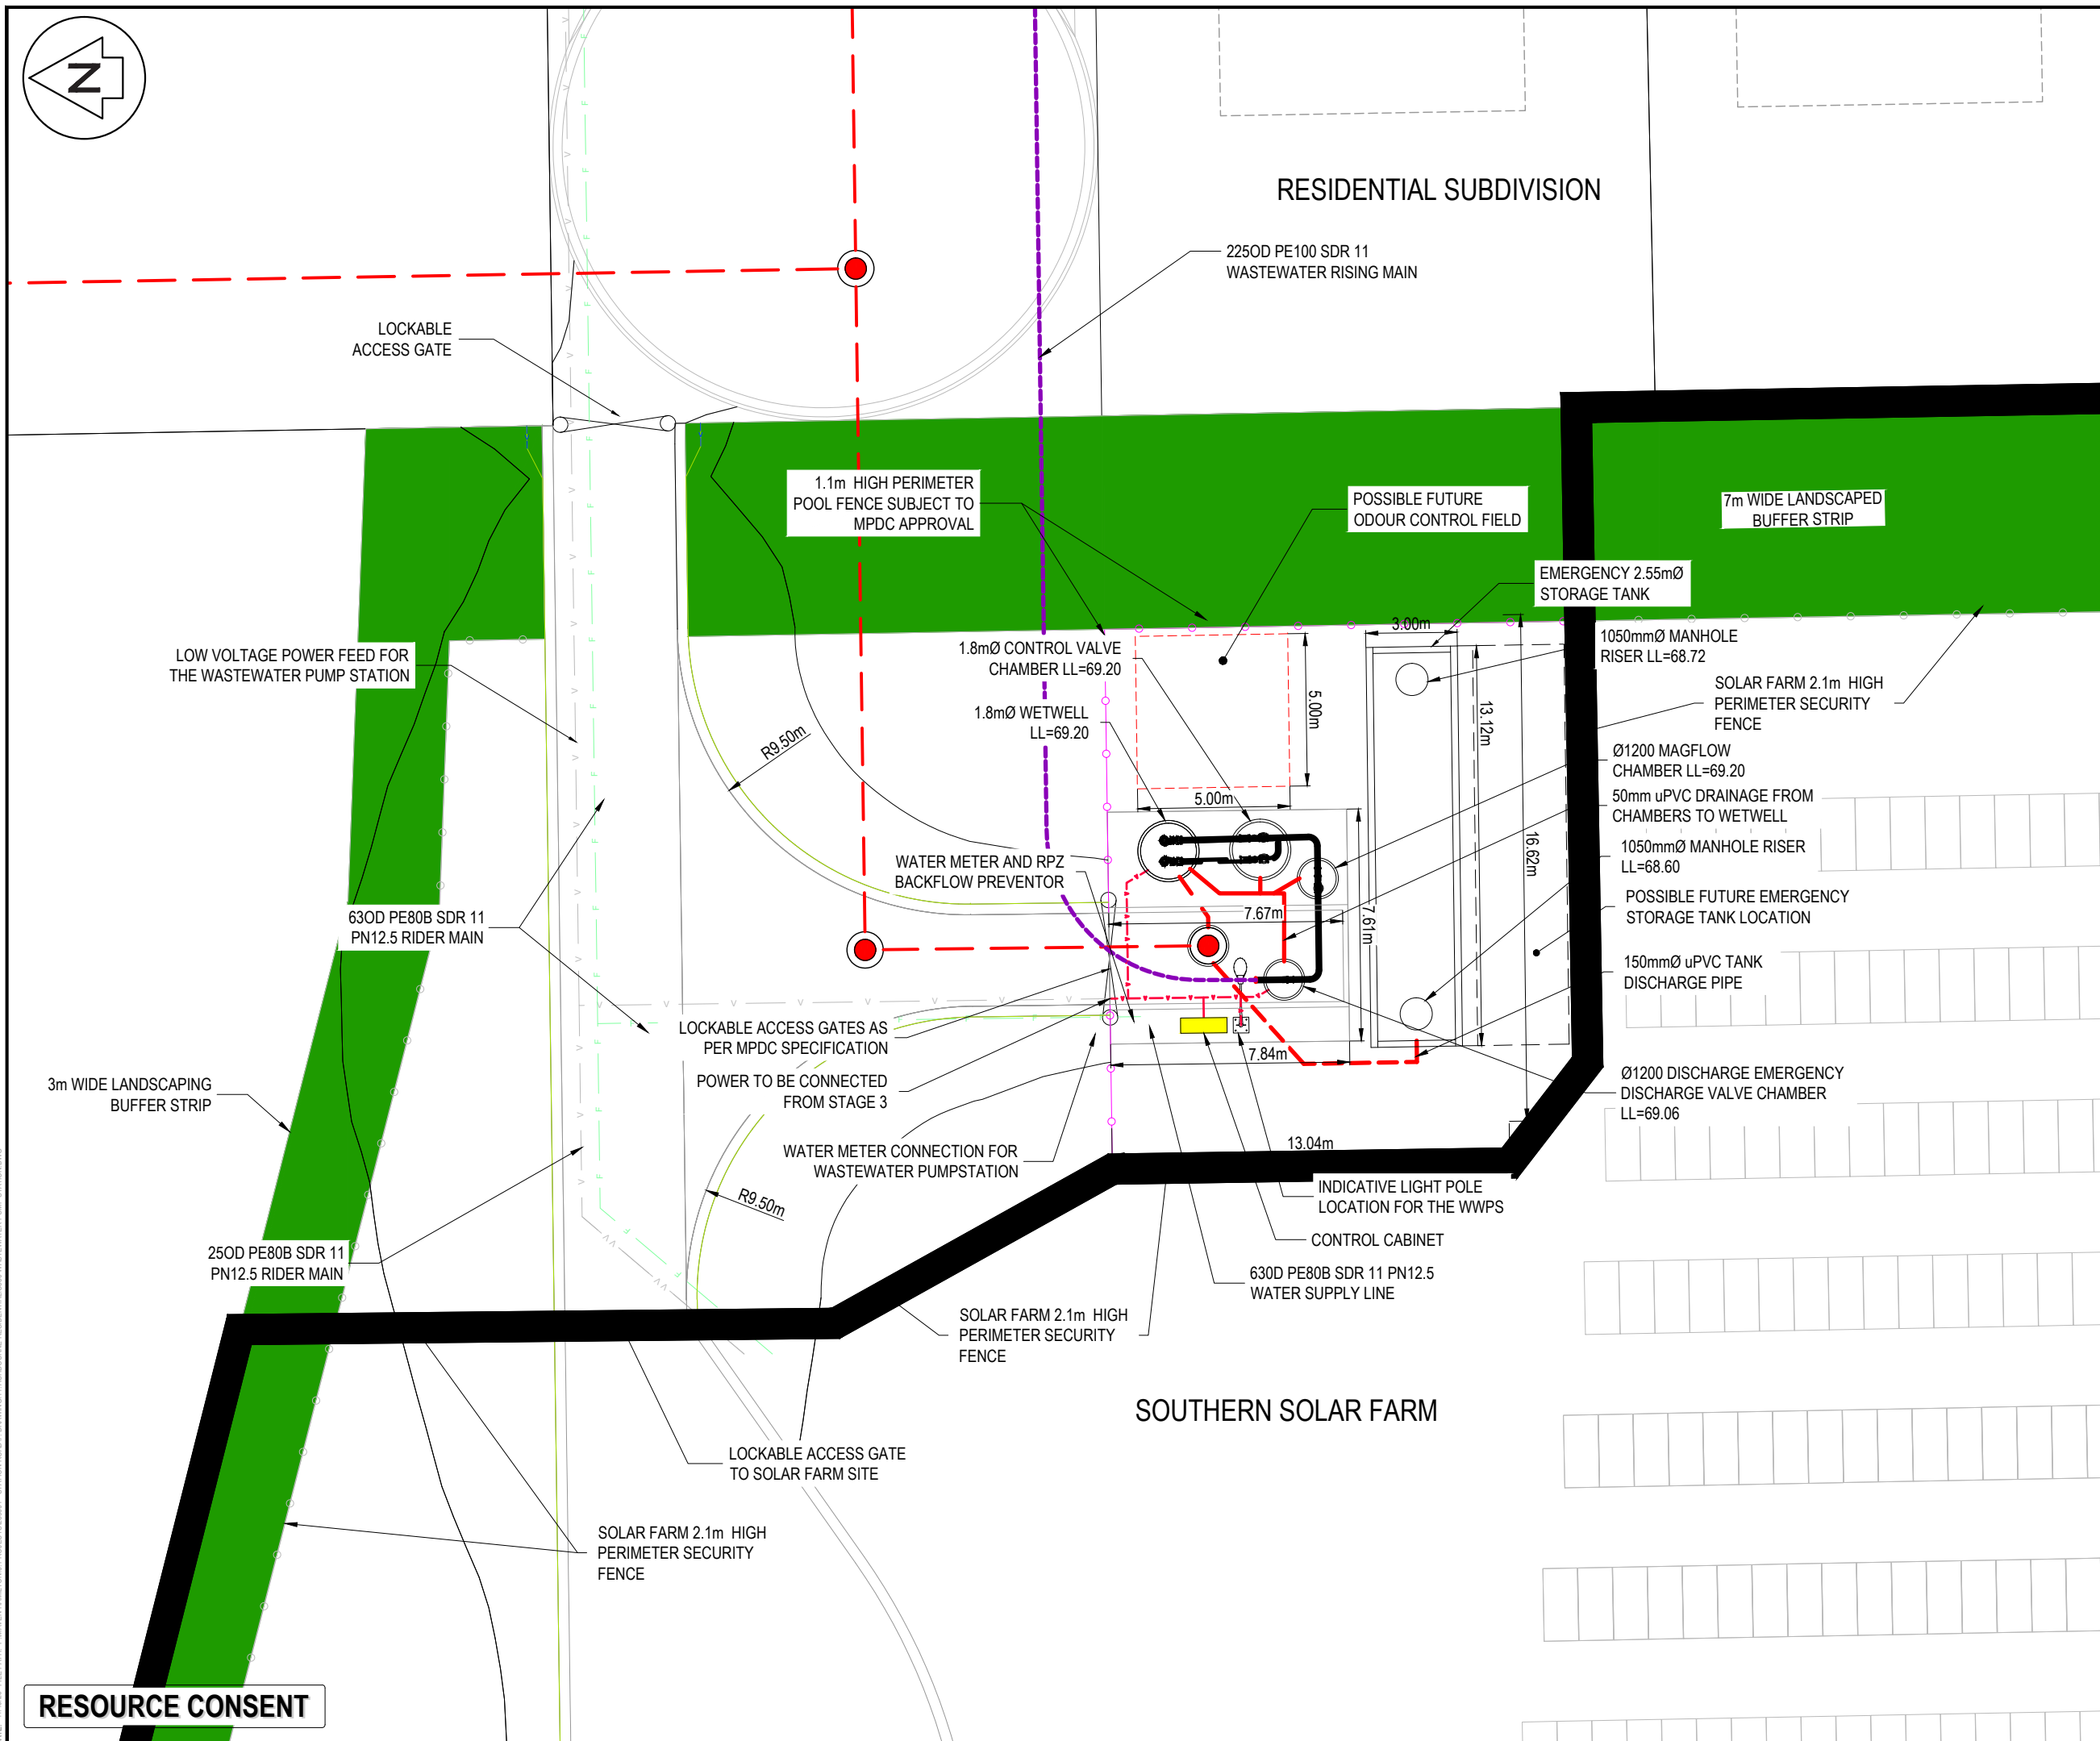

- Notes**

  1. All works to be in accordance with Waikato Regional Infrastructure Technical Specifications.
  2. Co-ordinates in terms of NZ Geodetic Datum Mount Eden 2000.
  3. Levels in terms of the New Zealand Vertical Datum 2016.
  4. It is the Contractors responsibility to locate all services that may be affected by his operations.
  5. Approved halfdrill is to be used in backfilling of all road crossings to council standards.
  6. Heavy duty manhole lids and frames to be used in trafficked areas, all manholes shall have stainless grates installed.
  7. All lines are to be 150mmØ PVC Class SN16 unless shown otherwise.
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C	FAST TRACK APP	TCH	05/2025
B	FAST TRACK APP	TCH	05/2025
A	FAST TRACK APP	TCH	04/2025
Rev	Description	By	Date
	By	Date	
Survey	MAVEN	05/2024	
Design	TCH	04/2025	
Drawn	TCH	04/2025	
Checked	DJM	04/2025	


Project  
**ASHBOURNE  
RESIDENTIAL  
FOR  
MATAMATA  
DEVELOPMENTS LTD**

Project no.	289001		
Scale	1:200 @ A3		
Cad file	C530-WASTEWATER-PUMP STATION.DWG		
Drawing no.	C530-1	Rev	<b>C</b>






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WASTEWATER PUMP STATION TYPICAL CROSS SECTION  
SCALE: NTS

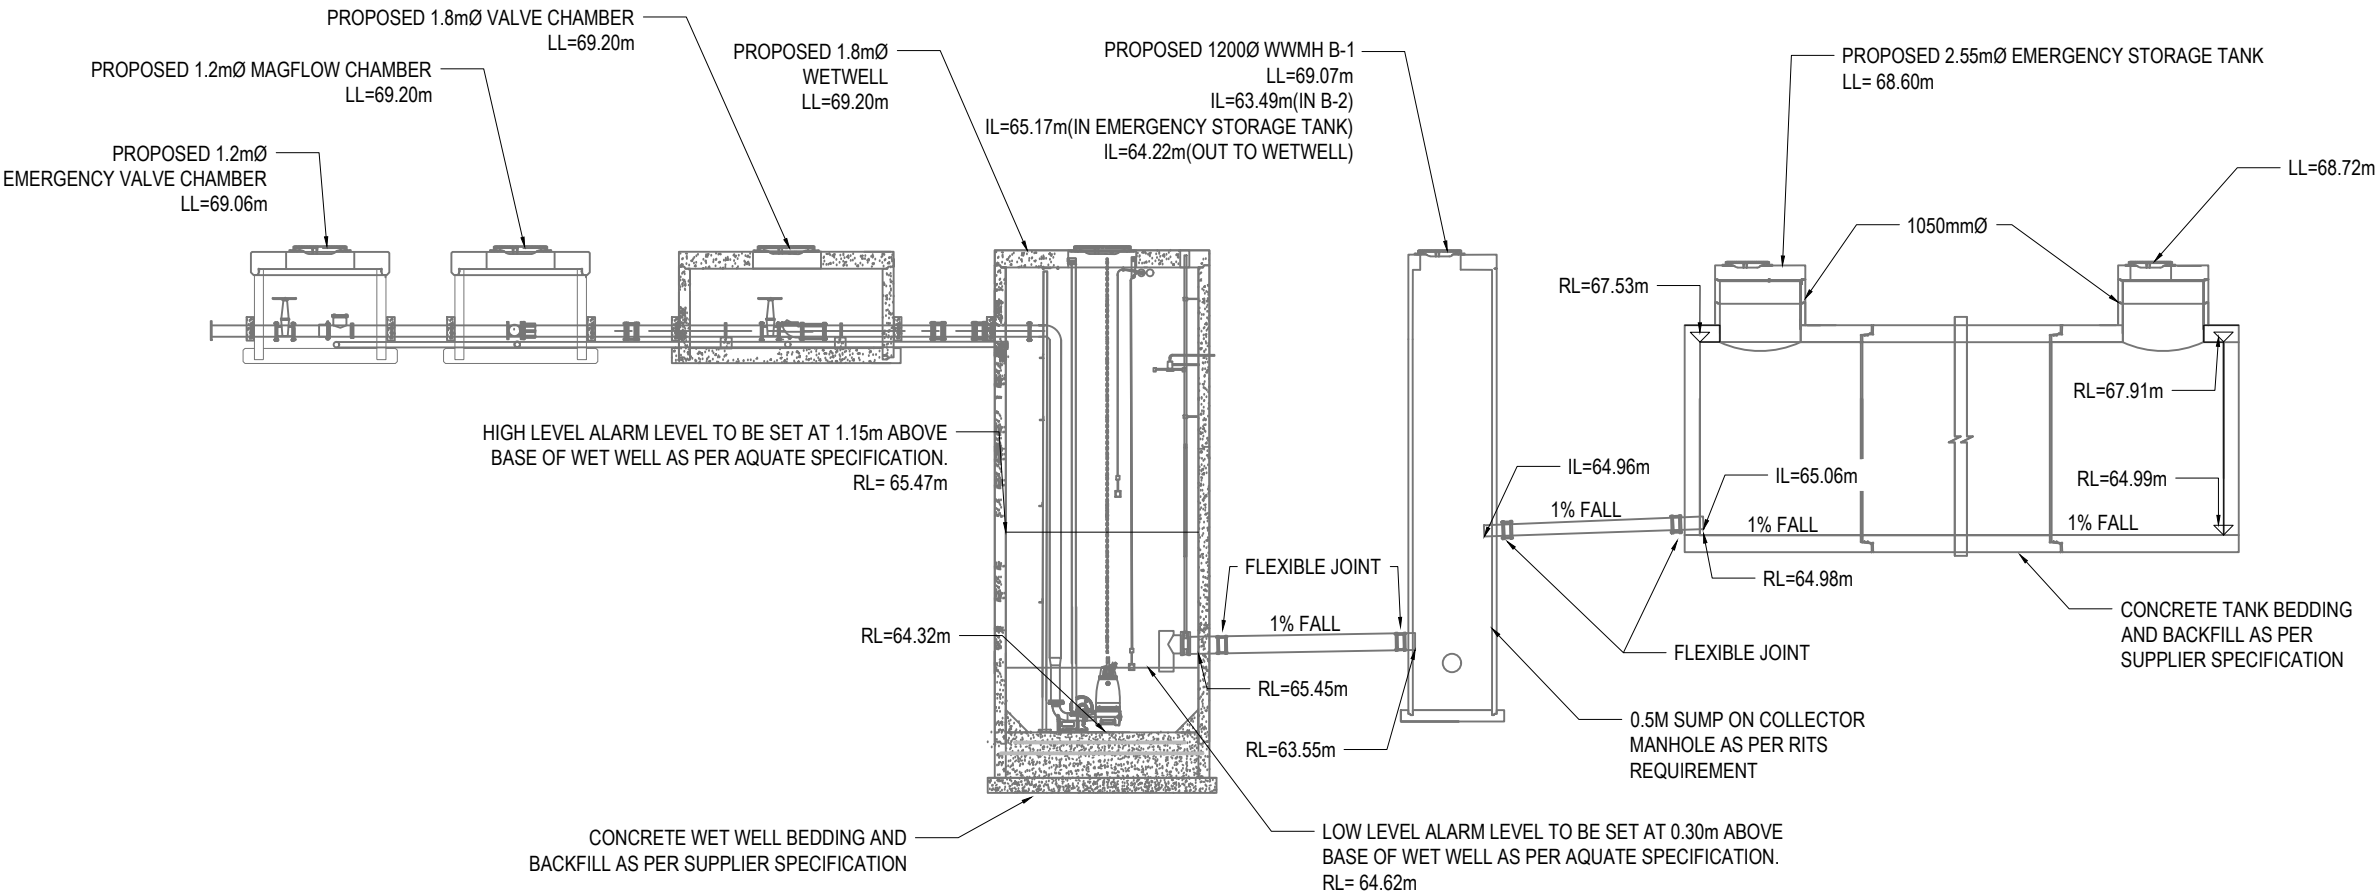

WASTEWATER PUMP STATION DISCHARGE MANHOLE TYPICAL CROSS SECTION  
SCALE: NTS

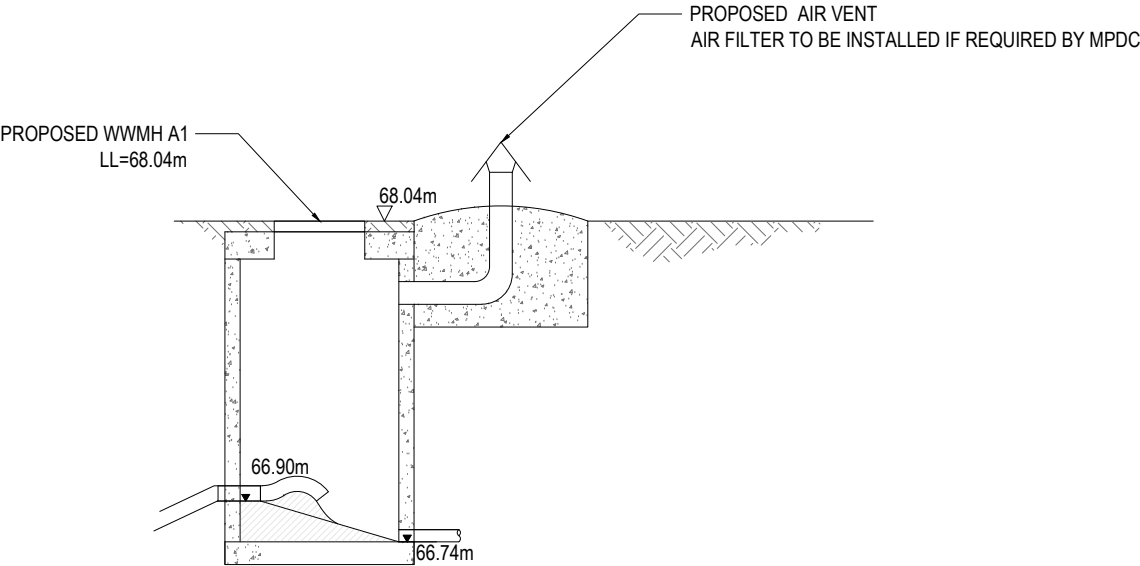- NOTES
1. ALL WORKS TO BE IN ACCORDANCE WITH WAIKATO REGIONAL INFRASTRUCTURE TECHNICAL SPECIFICATIONS.
  2. COORDINATES IN TERMS OF NZ GEODETIC DATUM MT EDEN 2000. LEVELS IN TERMS OF THE NEW ZEALAND VERTICAL DATUM 2016.
  3. IT IS THE CONTRACTORS RESPONSIBILITY TO LOCATE ALL SERVICES THAT MAY BE AFFECTED BY THEIR OPERATIONS.
  4. CONTRACTOR TO CHECK ALL DIMENSIONS PRIOR TO CONSTRUCTION/ FABRICATION.
  5. HEAVY DUTY MANHOLE LIDS AND FRAMES TO BE USED IN TRAFFICKED AREAS.
  6. ALL MANHOLES ARE TO BE 1050MMØ PRE CAST CONCRETE UNLESS SHOWN OTHERWISE.
  7. REFER TO AQUATE SPECIFICATION FOR RELEVANT WASTEWATER PUMP STATION SPECS AND INSTALLATION PROCESS.
  8. ALL PIPELINES SHALL HAVE A FLEXIBLE JOINT ADJACENT TO THE MANHOLE ON ALL INCOMING AND OUTGOING PIPES NOT MORE THAN 600mm AWAY FROM THE MANHOLE WALL.


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B	FAST TRACK APP	TCH	05/2025
A	FAST TRACK APP	TCH	04/2025
Rev	Description	By	Date
		By	Date
Survey	MAVEN		05/2024
Design	TCH		04/2025
Drawn	TCH		04/2025
Checked	DJM		04/2025

**M** **Maven Associates**  
09 571 0050  
info@maven.co.nz  
www.maven.co.nz  
5 Owens Road, Epsom  
Auckland 1023

Project  
**ASHBOURNE  
RESIDENTIAL  
FOR  
MATAMATA  
DEVELOPMENTS LTD**

Title  
**PROPOSED CENTRAL  
WASTEWATER PUMP  
TYPICAL SECTIONS**

Project no.	289001		
Scale	NTS @ A3		
Cad file	C530-WASTEWATER-PUMP STATION.DWG		
Drawing no.	C530-3	Rev	C

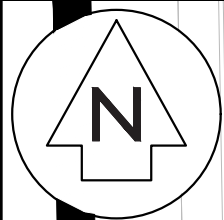

512

250OD PE100 SDR 13.6  
PN12.5 RIDER MAIN

125OD PE100 SDR 13.6  
PN12.5 RIDER MAIN

150mm uPVC SN16 @ 1.01%

WATER METER CONNECTION FOR  
WASTEWATER PUMPSTATION

POWER TO BE CONNECTED  
FROM STAGE 8

LOCKABLE ACCESS GATES AS  
PER MPDC SPECIFICATION

PR WWMH C2  
LL=66.61  
IL=62.80 (C3 in)  
IL=62.80 (C31 in)  
IL=62.73 (C1 out)

PR WWMH C1  
LL=66.48  
IL=62.66 (C2 in)

150mm uPVC SN16 @ 0.53%

PROPOSED COMMERCIAL REINFORCED CONCRETE  
VEHICLE ENTRANCE IN ACCORDANCE WITH RITS  
STANDARD DRAWINGS D3.3.4 & D3.3.5

1.8mØ WETWELL  
LL=66.40

140OD PE100 SDR 13.6  
WASTEWATER RISING MAIN

WATER METER AND RPZ  
BACKFLOW PREVENTOR

1.1m HEIGHT PERIMETER  
POOL FENCE SUBJECT TO  
MPDC APPROVAL

CONTROL CABINET

INDICATIVE LIGHT POLE  
LOCATION FOR THE WWPS

Ø1200 DISCHARGE EMERGENCY  
DISCHARGE VALVE CHAMBER  
LL=66.24

POSSIBLE FUTURE  
ODOUR CONTROL FIELD

Ø1200 MAGFLOW  
CHAMBER

EMERGENCY  
2.55mØ STORAGE  
TANK

POSSIBLE FUTURE  
EMERGENCY STORAGE  
TANK LOCATION

7.16m

4.83m

1.8mØ CONTROL  
VALVE CHAMBER  
LL=66.40

1050mmØ MANHOLE  
RISERS  
LL=66.30

50mm uPVC DRAINAGE FROM  
CHAMBERS TO WETWELL

630D PE80B SDR 11 PN12.5  
WATER SUPPLY LINE

150mm uPVC SN16 @ 0.54%

#### Notes

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#### Legend

---	EX BOUNDARY
---	PROP BOUNDARY
---	EX WASTEWATER
---	PR WASTEWATER
---	PR STORMWATER
○	EX/PROP WWMH
●	EX/PROP SWMH
---	WW LOT CONNECTION

D	FAST TRACK APP	RJM	11/2025
C	FAST TRACK APP	TCH	05/2025
B	FAST TRACK APP	TCH	05/2025
A	FAST TRACK APP	TCH	04/2025
Rev	Description	By	Date
		By	Date
Survey	MAVEN		05/2024
Design	TCH		04/2025
Drawn	TCH		04/2025
Checked	DJM		04/2025



Project  
**ASHBOURNE  
RESIDENTIAL  
FOR  
MATAMATA  
DEVELOPMENTS LTD**


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**PROPOSED NORTHERN  
WASTEWATER PUMP  
STATION LAYOUT PLAN**

Project no.	289001
Scale	1:200 @ A3
Cad file	C530-WASTEWATER-PUMP STATION.DWG
Drawing no.	C535-1
Rev	C

RESOURCE CONSENT



DATE: 11/19/25 FILE PATH: F:\Maven\Hamilton\6. PROJECTS\289001 - STATION ROAD\7. DRAWING\11. ASHBORNE RESIDENTIAL\C535-WASTEWATER-PUMP STATION.DWG

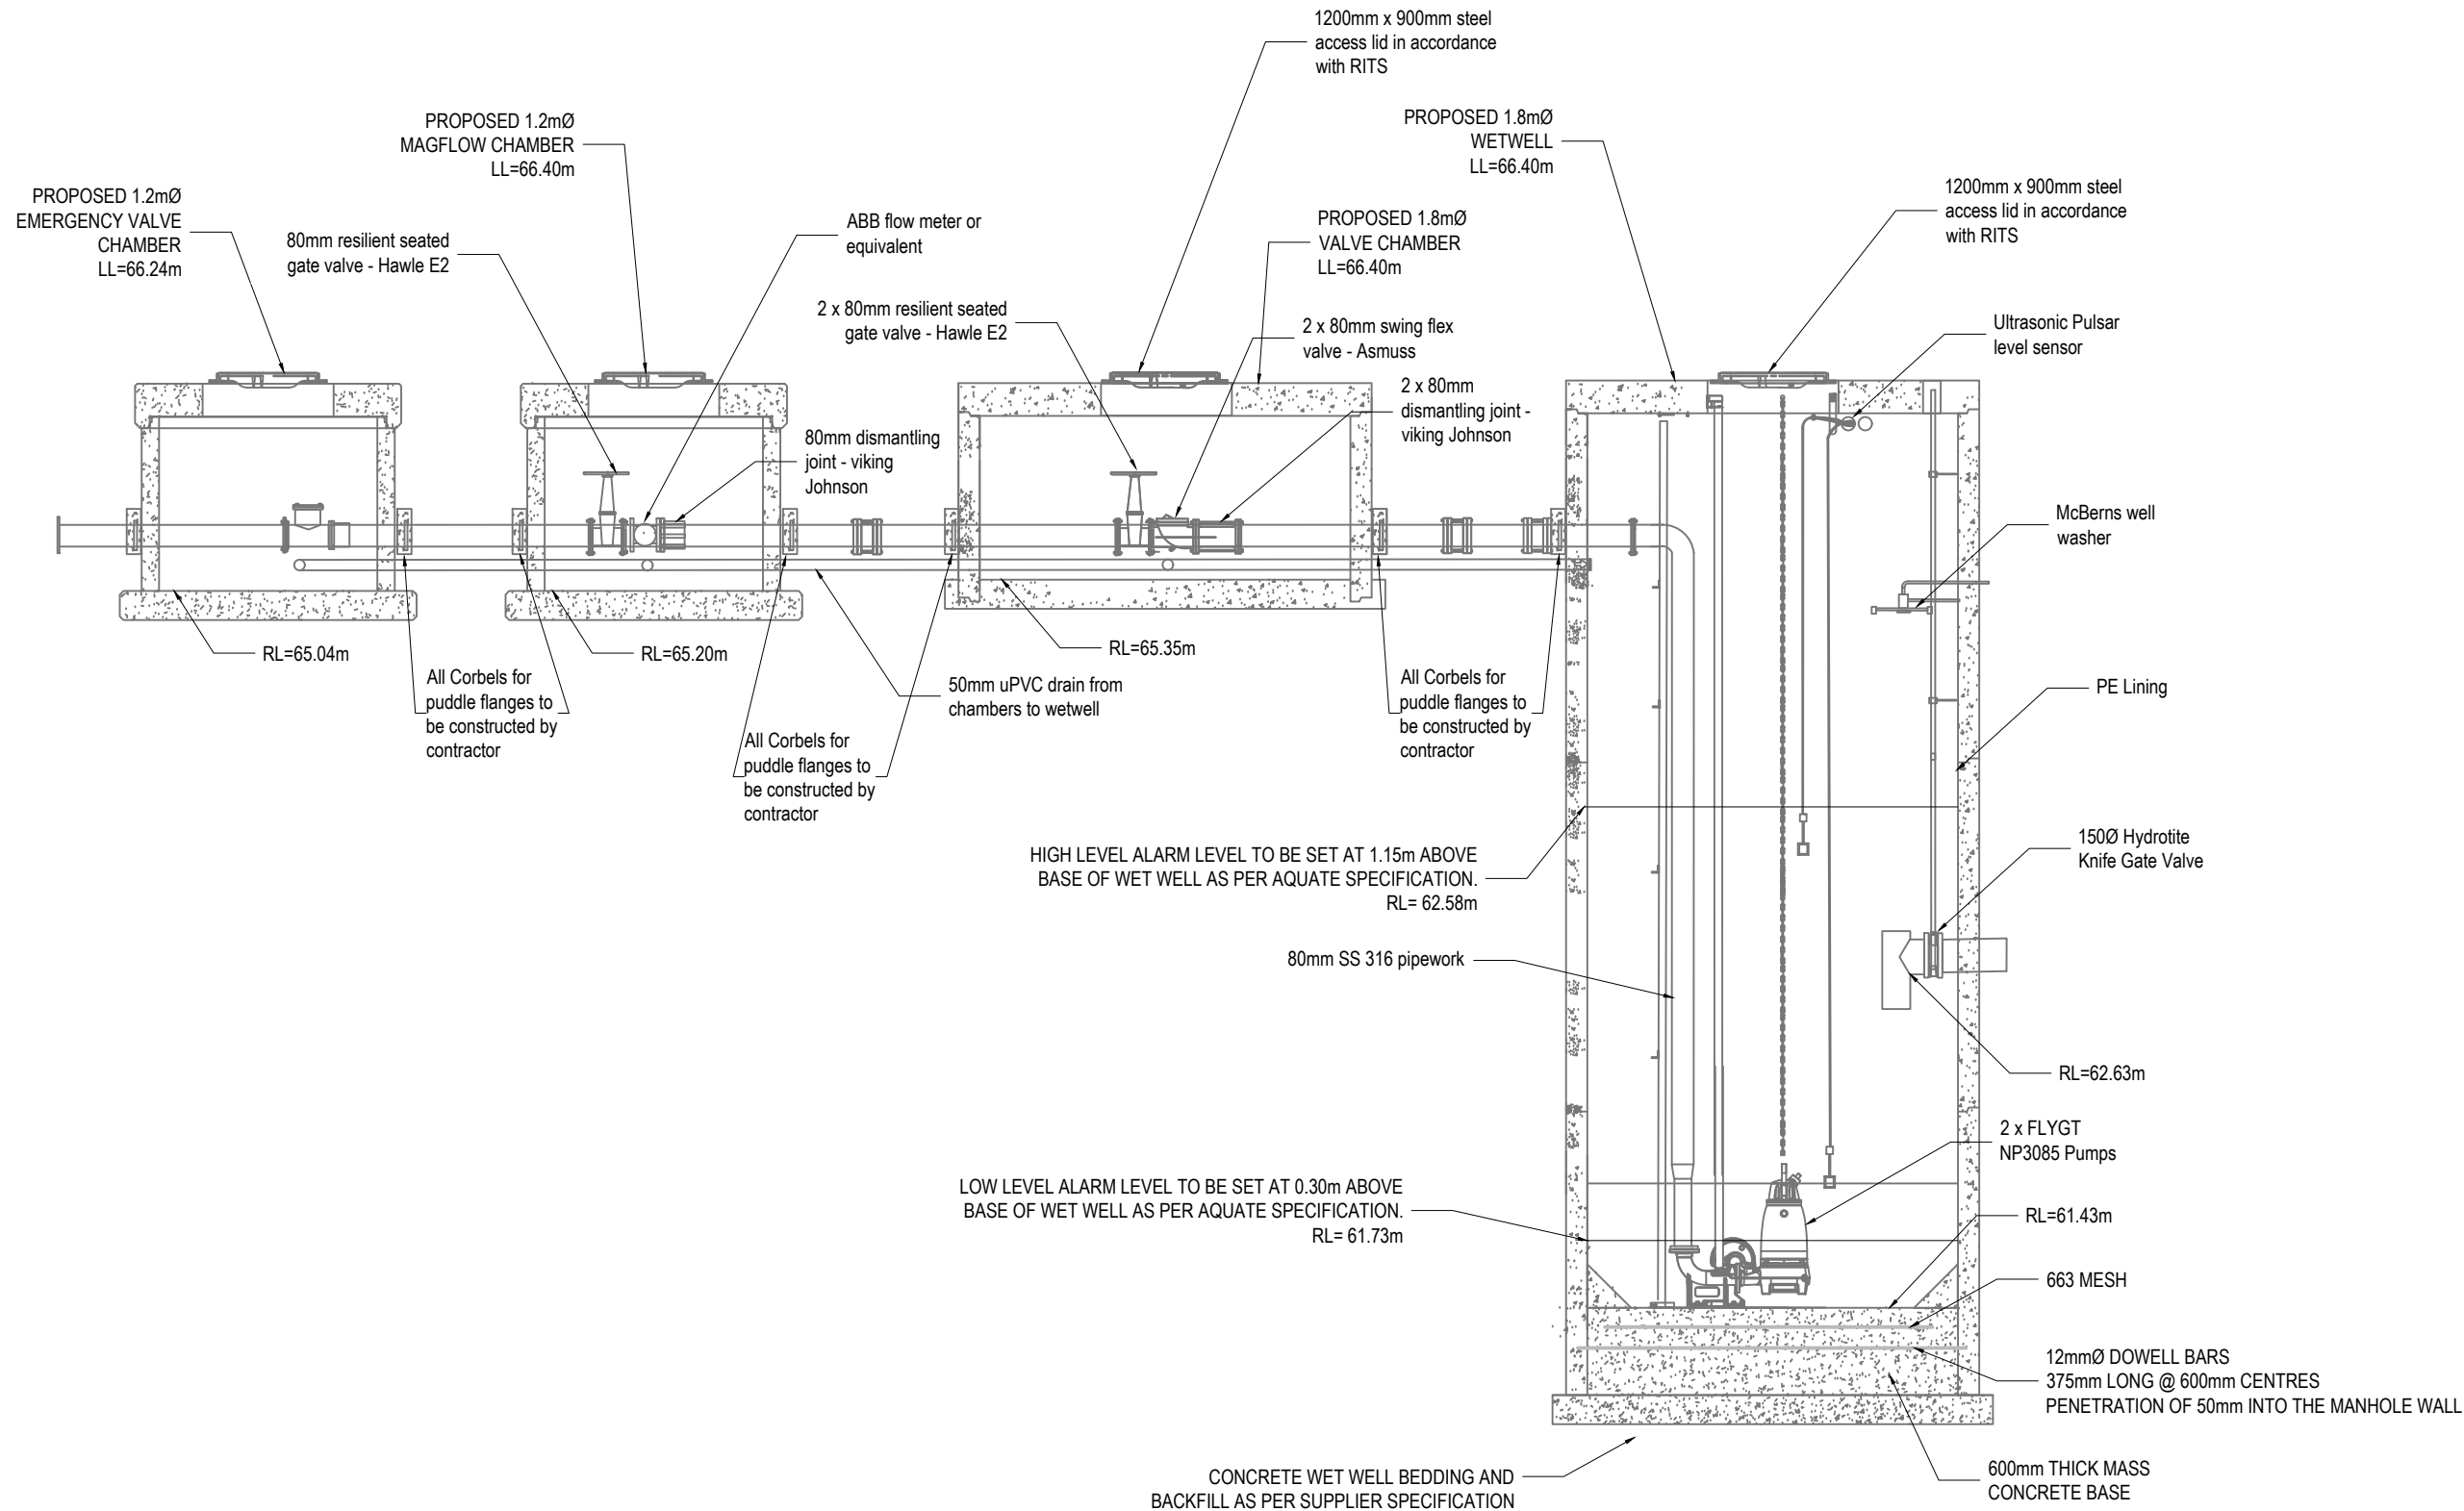

WASTEWATER PUMP STATION TYPICAL CROSS SECTION  
SCALE: NTS

- NOTES
1. ALL WORKS TO BE IN ACCORDANCE WITH WAIKATO REGIONAL INFRASTRUCTURE TECHNICAL SPECIFICATIONS.
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D	FAST TRACK APP	RJM	11/2025
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Rev	Description	By	Date
		By	Date
Survey	MAVEN		05/2024
Design	TCH		04/2025
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Checked	DJM		04/2025




Project  
**ASHBOURNE  
RESIDENTIAL  
FOR  
MATAMATA  
DEVELOPMENTS LTD**

Title  
**PROPOSED NORTHERN  
WASTEWATER PUMP  
TYPICAL CROSS SECTION**


Project no.	289001		
Scale	NTS @ A3		
Cad file	C530-WASTEWATER-PUMP STATION.DWG		
Drawing no.	C535-2	Rev	<b>C</b>

RESOURCE CONSENT

DATE: 11/19/25 FILE PATH: F:\Maven\Hamilton\06 PROJECTS\08001 - STATION ROAD\ DRAWING\01 ASHBORNE RESIDENTIAL\C530-WASTEWATER-PUMP STATION.DWG

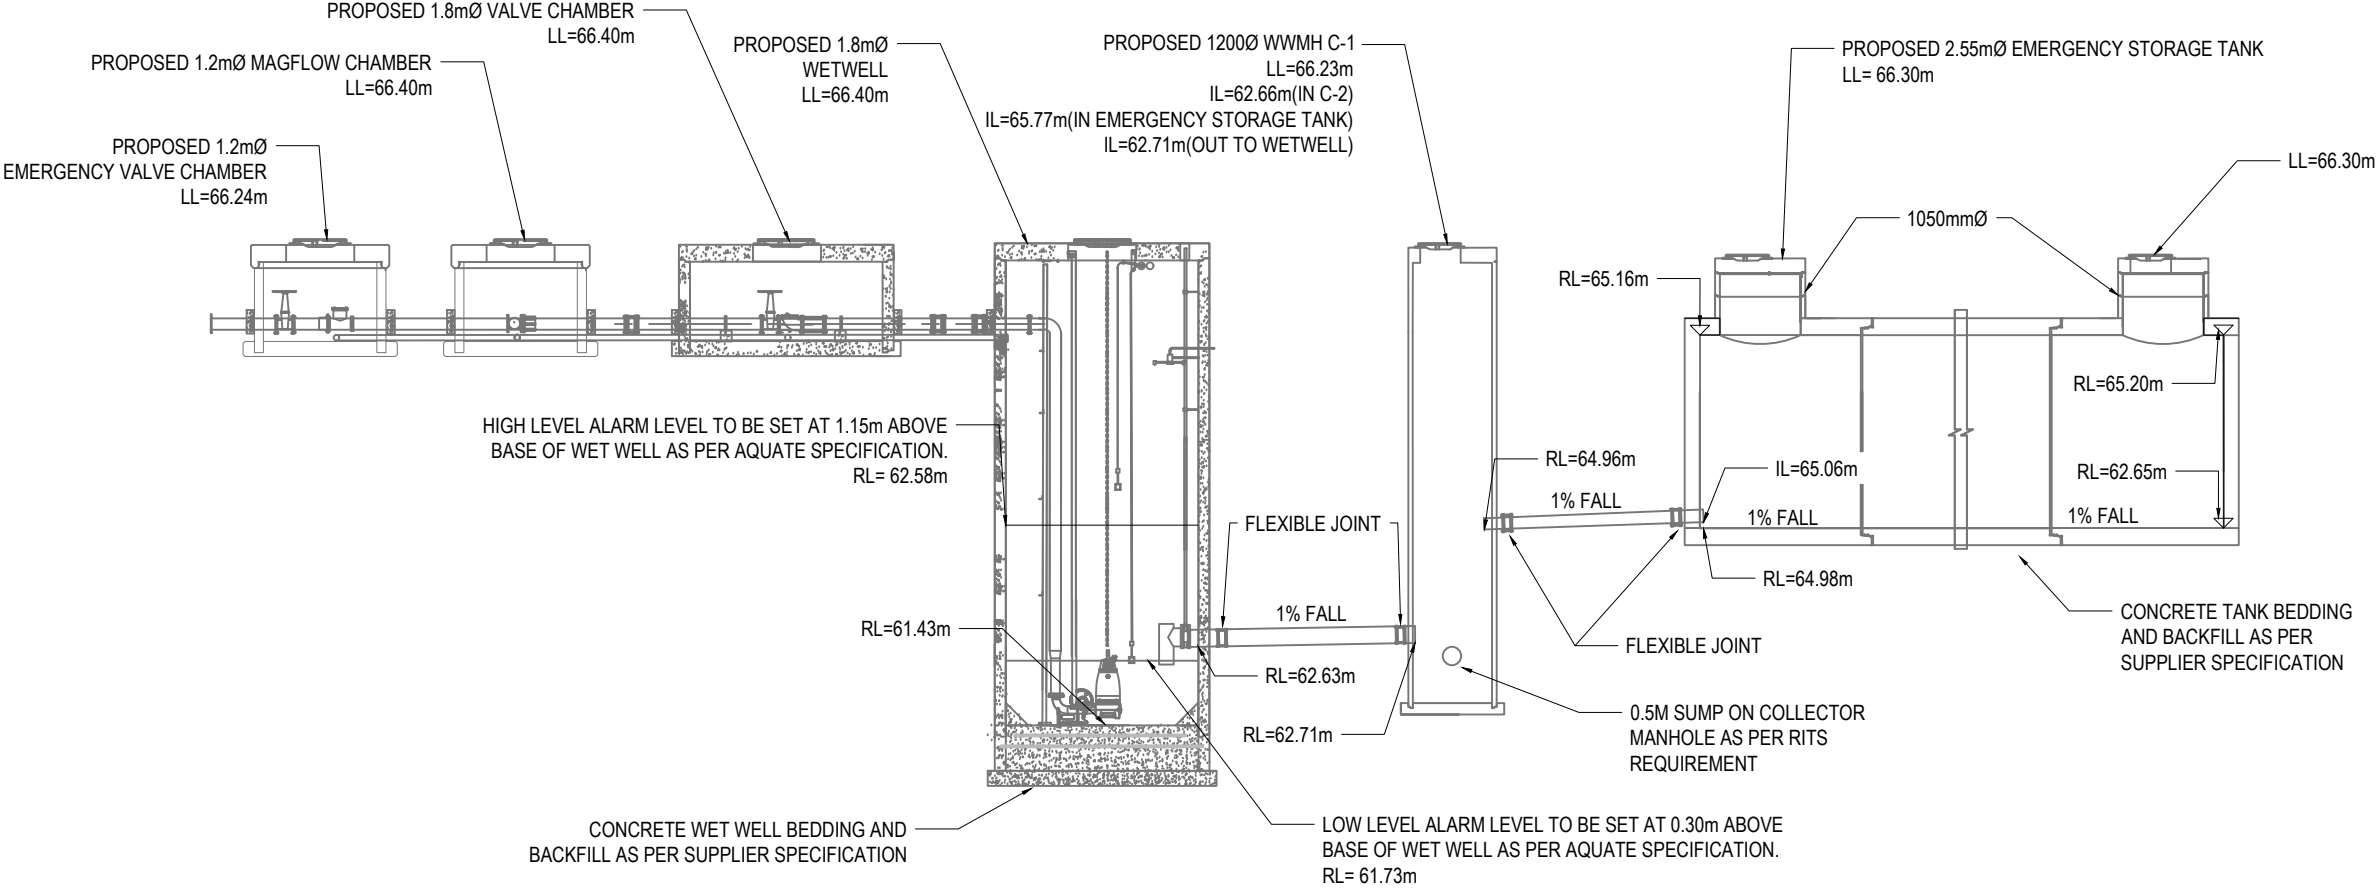

WASTEWATER PUMP STATION TYPICAL CROSS SECTION  
SCALE: NTS

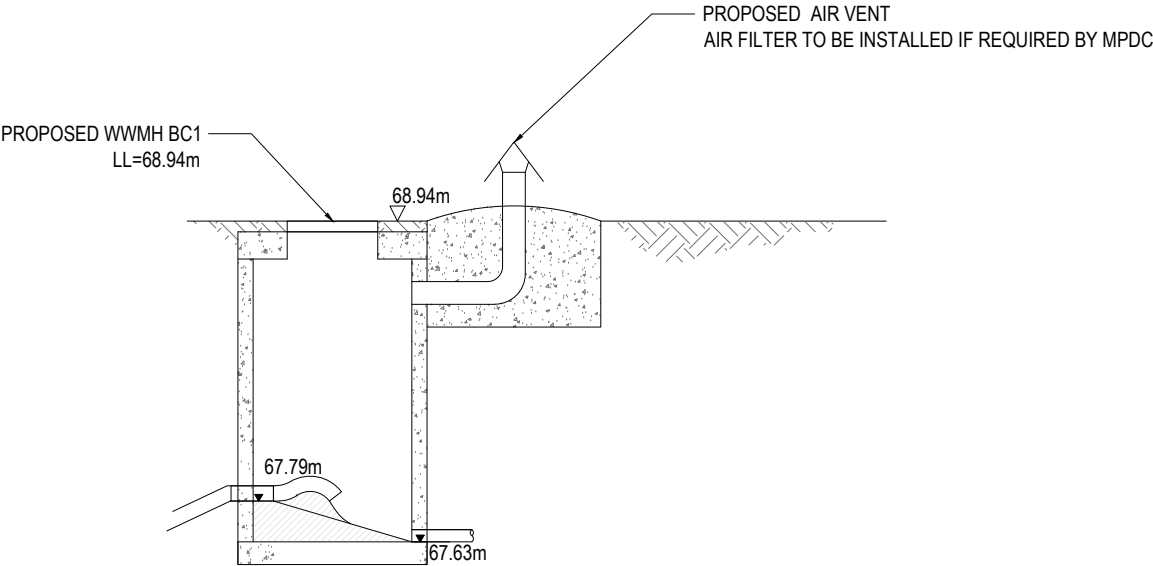

WASTEWATER PUMP STATION DISCHARGE MANHOLE TYPICAL CROSS SECTION  
SCALE: NTS

- NOTES
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  6. ALL MANHOLES ARE TO BE 1050MMØ PRE CAST CONCRETE UNLESS SHOWN OTHERWISE.
  7. REFER TO AQUATE SPECIFICATION FOR RELEVANT WASTEWATER PUMP STATION SPECS AND INSTALLATION PROCESS.
  8. ALL PIPELINES SHALL HAVE A FLEXIBLE JOINT ADJACENT TO THE MANHOLE ON ALL INCOMING AND OUTGOING PIPES NOT MORE THAN 600mm AWAY FROM THE MANHOLE WALL.

D	FAST TRACK APP	RJM	11/2025
C	FAST TRACK APP	TCH	05/2025
B	FAST TRACK APP	TCH	05/2025
A	FAST TRACK APP	TCH	04/2025
Rev	Description	By	Date
		By	Date
Survey	MAVEN		05/2024
Design	TCH		04/2025
Drawn	TCH		04/2025
Checked	DJM		04/2025

**M** **Maven Associates**  
09 571 0050  
info@maven.co.nz  
www.maven.co.nz  
5 Owens Road, Epsom  
Auckland 1023


Project  
**ASHBOURNE  
RESIDENTIAL  
FOR  
MATAMATA  
DEVELOPMENTS LTD**

Title  
**PROPOSED NORTHERN  
WASTEWATER PUMP  
TYPICAL CROSS SECTION**

Project no.	289001		
Scale	NTS @ A3		
Cad file	C530-WASTEWATER-PUMP STATION.DWG		
Drawing no.	C535-3	Rev	C

RESOURCE CONSENT



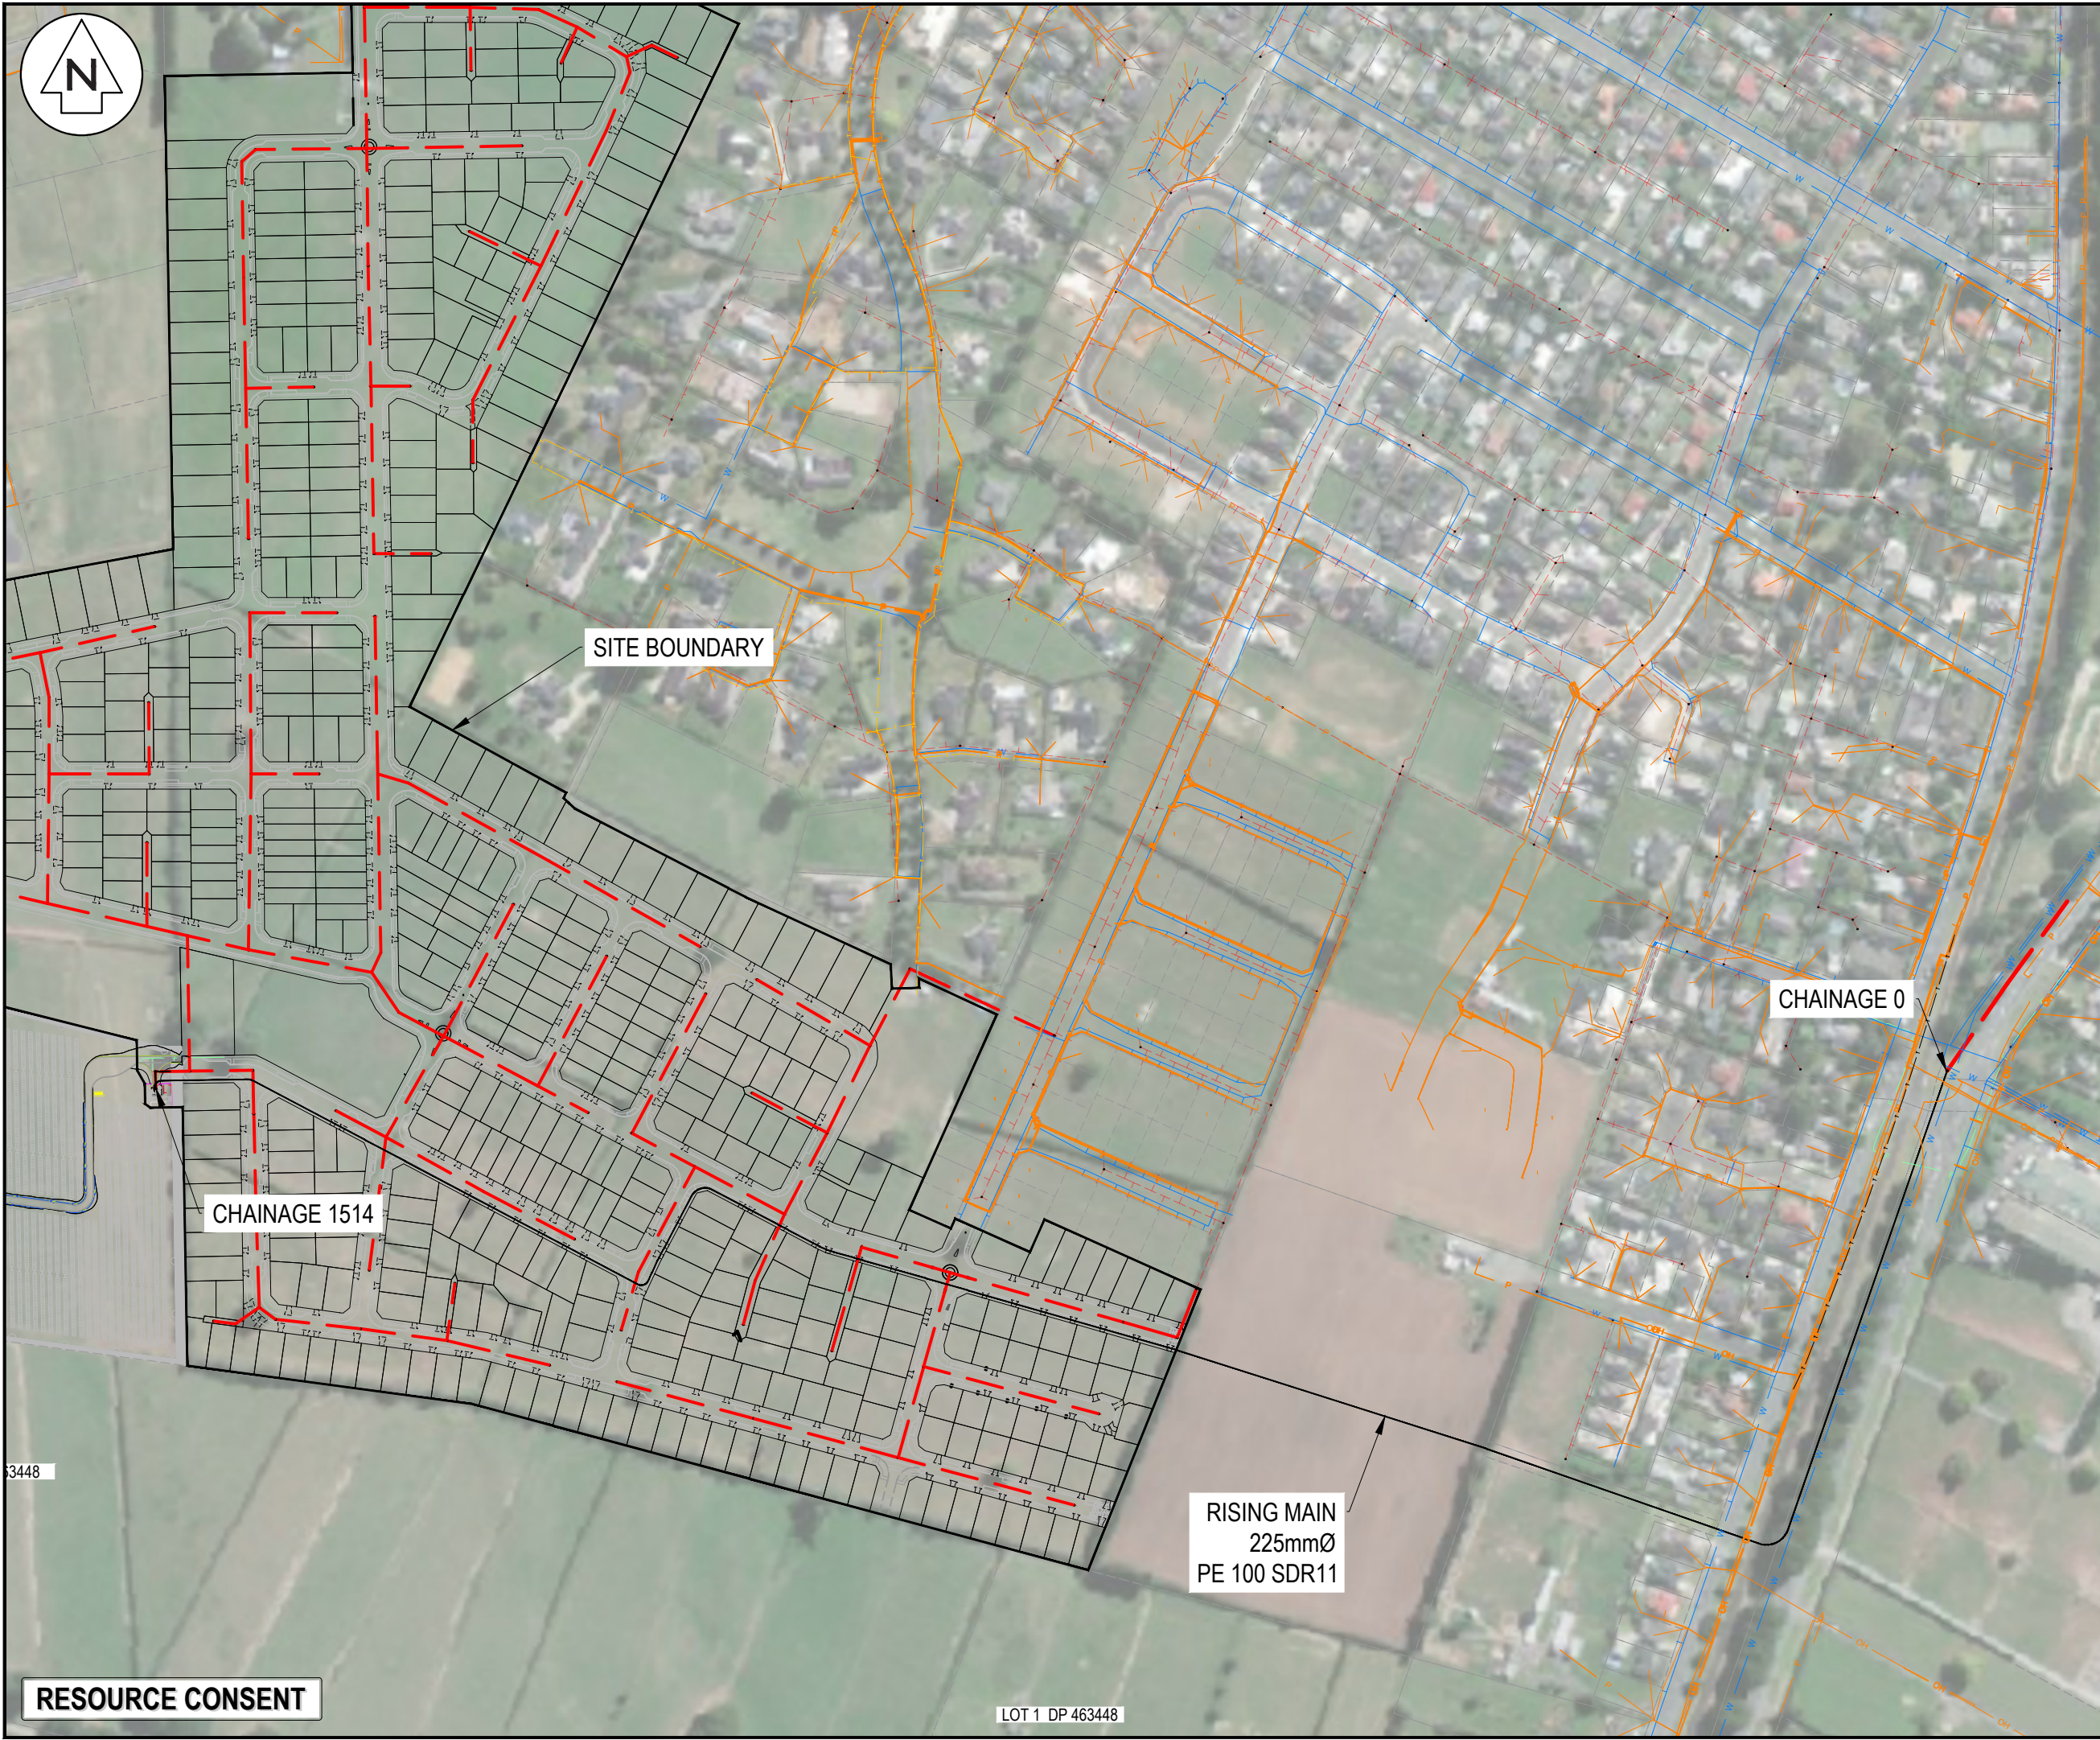

Notes

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2. Co-ordinates in terms of NZ Geodetic Datum Mount Eden 2000.
3. Levels in terms of the New Zealand Vertical Datum 2016.
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6. Heavy duty manhole lids and frames to be used in trafficked areas, all manholes shall have stainless grates installed.
7. All lines are to be 150mmØ PVC Class SN16 unless shown otherwise.
8. All lot connections are to be 100mmØ PVC unless shown otherwise.
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10. Manhole diameters shown on structure label are internal diameter.
11. Measurements shown on the lot connections are the distance from the centre of the downstream manhole to the lot connection position within the lot boundary.
12. Manhole slab and cover to be rotated to avoid the footpath edge for manholes on footpath.
13. Pipe lengths shown on plan are from upstream pipe invert to downstream pipe invert.

Legend

— T — T — T —	EX BDY
— V — V — V —	EX TELECOM
— GAS — GAS — GAS —	EX POWER
— W — W — W —	EX GAS
— W — W — W —	EX WASTEWATER
— W — W — W —	EX STORMWATER
— W — W — W —	EX WATER SUPPLY
— W — W — W —	PROP WW
— W — W — W —	WW RISING MAIN
— W — W — W —	EX/PROP WWMH

E	FAST TRACK APP	RJM	11/2025
D	FAST TRACK APP	MKS	06/2025
C	FAST TRACK APP	MKS	05/2025
B	FAST TRACK APP	MKS	04/2025
Rev	Description	By	Date
		By	Date
Survey	MAVEN		05/2024
Design	MKS		04/2025
Drawn	MKS		04/2025
Checked	DJM		06/2025

**Maven Associates**  
09 571 0050  
info@maven.co.nz  
www.maven.co.nz  
5 Owens Road, Epsom  
Auckland 1023

Project

**ASHBOURNE  
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FOR  
MATAMATA  
DEVELOPMENTS LTD**

Title

**PROPOSED  
WWPS RISING MAIN  
OVERVIEW PLAN**


Project no.	289001		
Scale	1:4000 @ A3		
Cad file	C540-WWPS LS.DWG		
Drawing no.	C540	Rev	E

DATE: 11/18/25 FILE PATH: F:\MAVEN\HAMILTON\6 PROJECTS\289001 - STATION ROAD\DRAWING\11 ASHBORNE RESIDENTIAL\LS.DWG

RESOURCE CONSENT

LOT 1 DP 463448



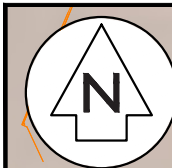

- Notes
1. All works to be in accordance with Waikato Regional Infrastructure Technical Specifications.
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**Legend**

	EX BDY
	EX TELECOM
	EX POWER
	EX GAS
	EX WASTEWATER
	EX STORMWATER
	EX WATER SUPPLY
	PROP WW
	WW RISING MAIN
	EX/PROP WMMH

E	FAST TRACK APP	RJM	11/2025
D	FAST TRACK APP	MKS	06/2025
C	FAST TRACK APP	MKS	05/2025
B	FAST TRACK APP	MKS	04/2025
Rev	Description	Bv	Date

	By	Date
Survey	MAVEN	05/2024
Design	MKS	04/2025
Drawn	MKS	04/2025
Checked	DJM	06/2025




Project  
**ASHBOURNE  
RESIDENTIAL  
FOR  
MATAMATA  
DEVELOPMENTS LTD**

Title


**PROPOSED  
WWPS RISING MAIN  
LONGSECTION**

Project no.	289001		
Scale	1:1500 @ A3		
Cad file	C540-WWPS L.S.DWG		
Drawing no.	C540-1	Rev	<b>E</b>

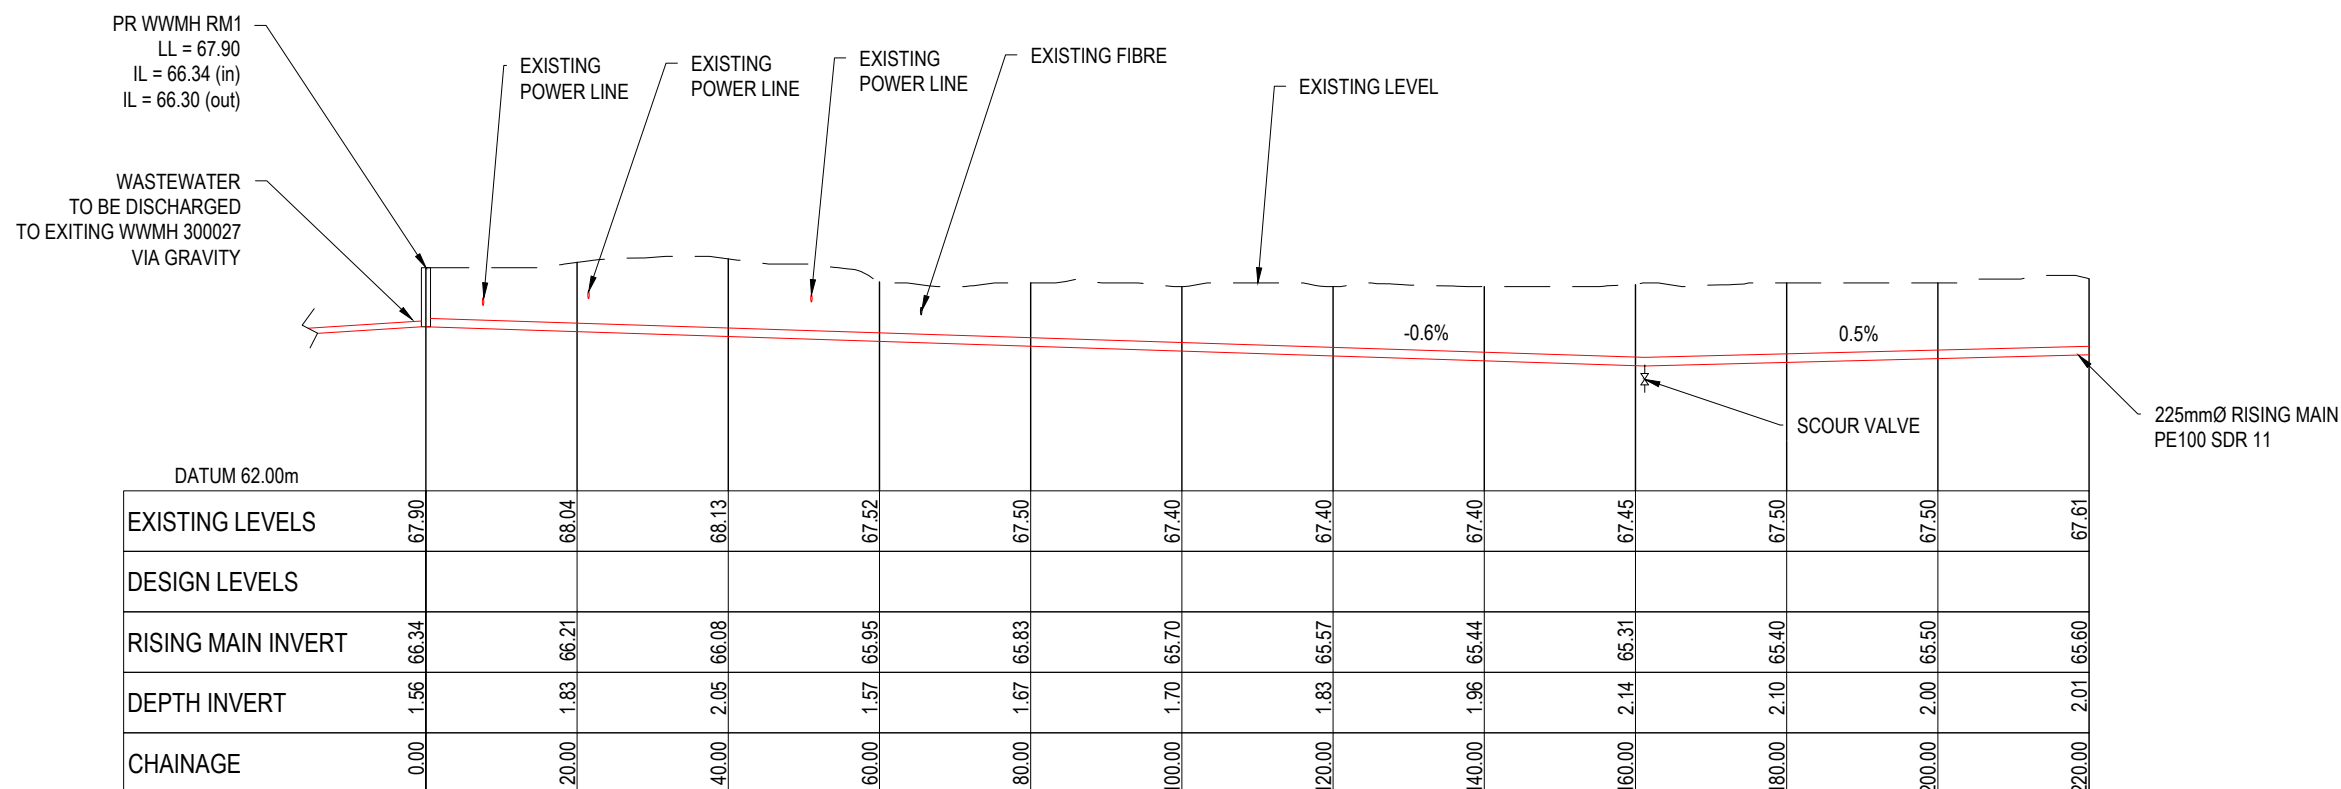

**LONGSECTION - CATCHMENT B (RISING MAIN 1)**  
SCALE 1:1000 HORI & 1:200 VERTICAL @ A3

## RESOURCE CONSENT

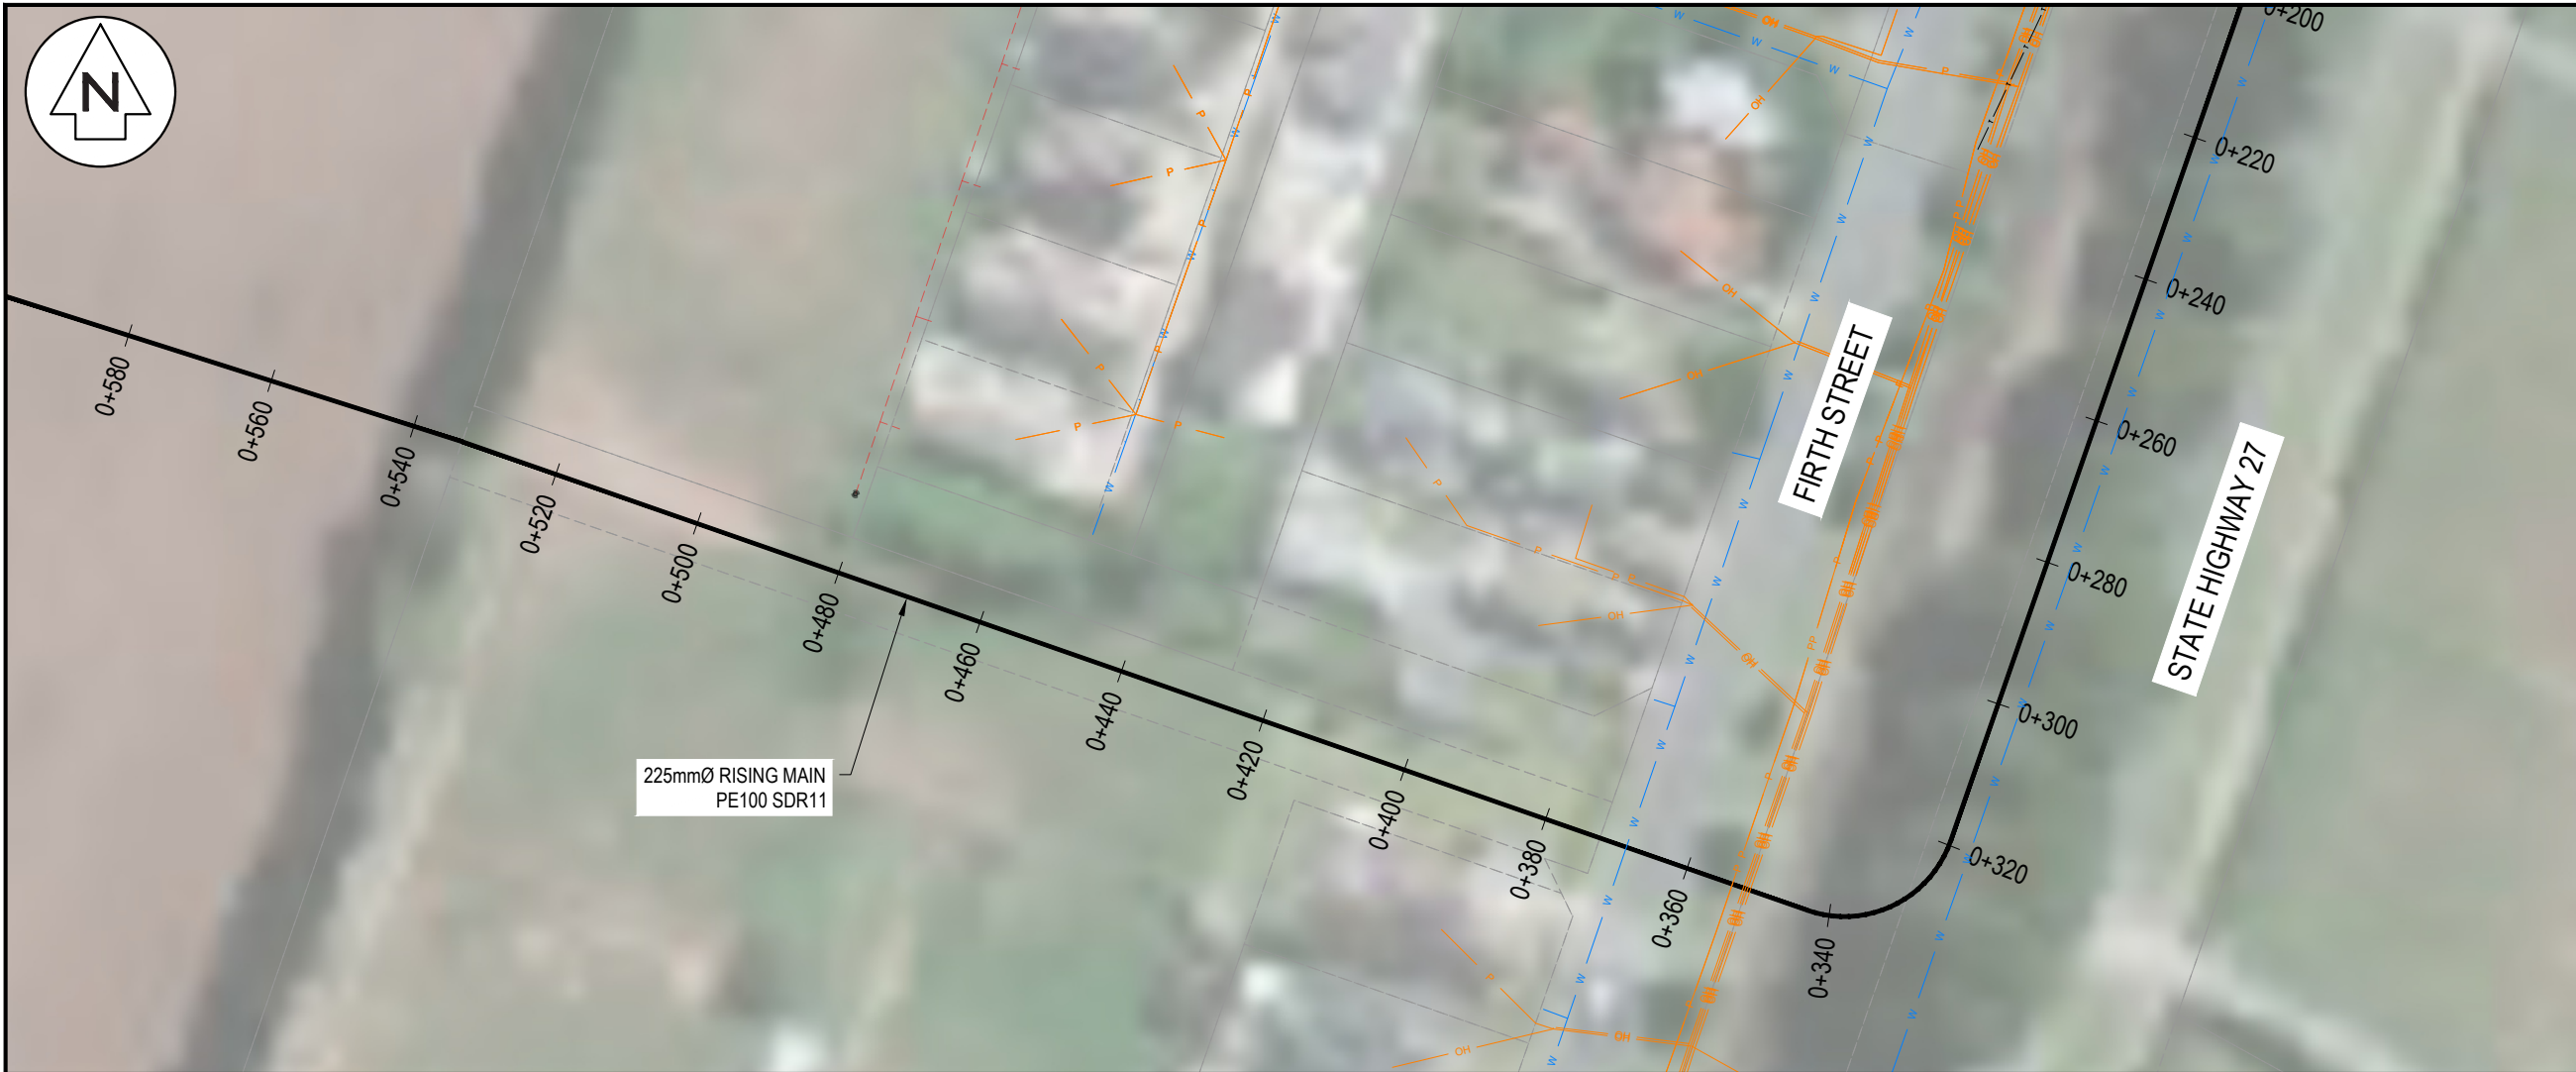

- Notes
- All works to be in accordance with Waikato Regional Infrastructure Technical Specifications.
  - Co-ordinates in terms of NZ Geodetic Datum Mount Eden 2000.
  - Levels in terms of the New Zealand Vertical Datum 2016.
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Legend		EX BDY
— T — T —	— T — T —	EX TELECOM
— V — V —	— V — V —	EX POWER
— GAS — GAS —	— GAS — GAS —	EX GAS
— W — W —	— W — W —	EX WASTEWATER
— W — W —	— W — W —	EX STORMWATER
— W — W —	— W — W —	EX WATER SUPPLY
— W — W —	— W — W —	PROP WW
— W — W —	— W — W —	WW RISING MAIN
— W — W —	— W — W —	EX/PROP WWMH


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D	FAST TRACK APP	MKS	06/2025
C	FAST TRACK APP	MKS	05/2025
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Rev	Description	By	Date
		By	Date
Survey	MAVEN		05/2024
Design	MKS		04/2025
Drawn	MKS		04/2025
Checked	DJM		06/2025



Project  
**ASHBOURNE  
RESIDENTIAL  
FOR  
MATAMATA  
DEVELOPMENTS LTD**

Title  
**PROPOSED  
WWPS RISING MAIN  
LONGSECTION**

Project no.	289001		
Scale	1:1000 @ A3		
Cad file	C540-WWPS L5.DWG		
Drawing no.	C540-2	Rev	E

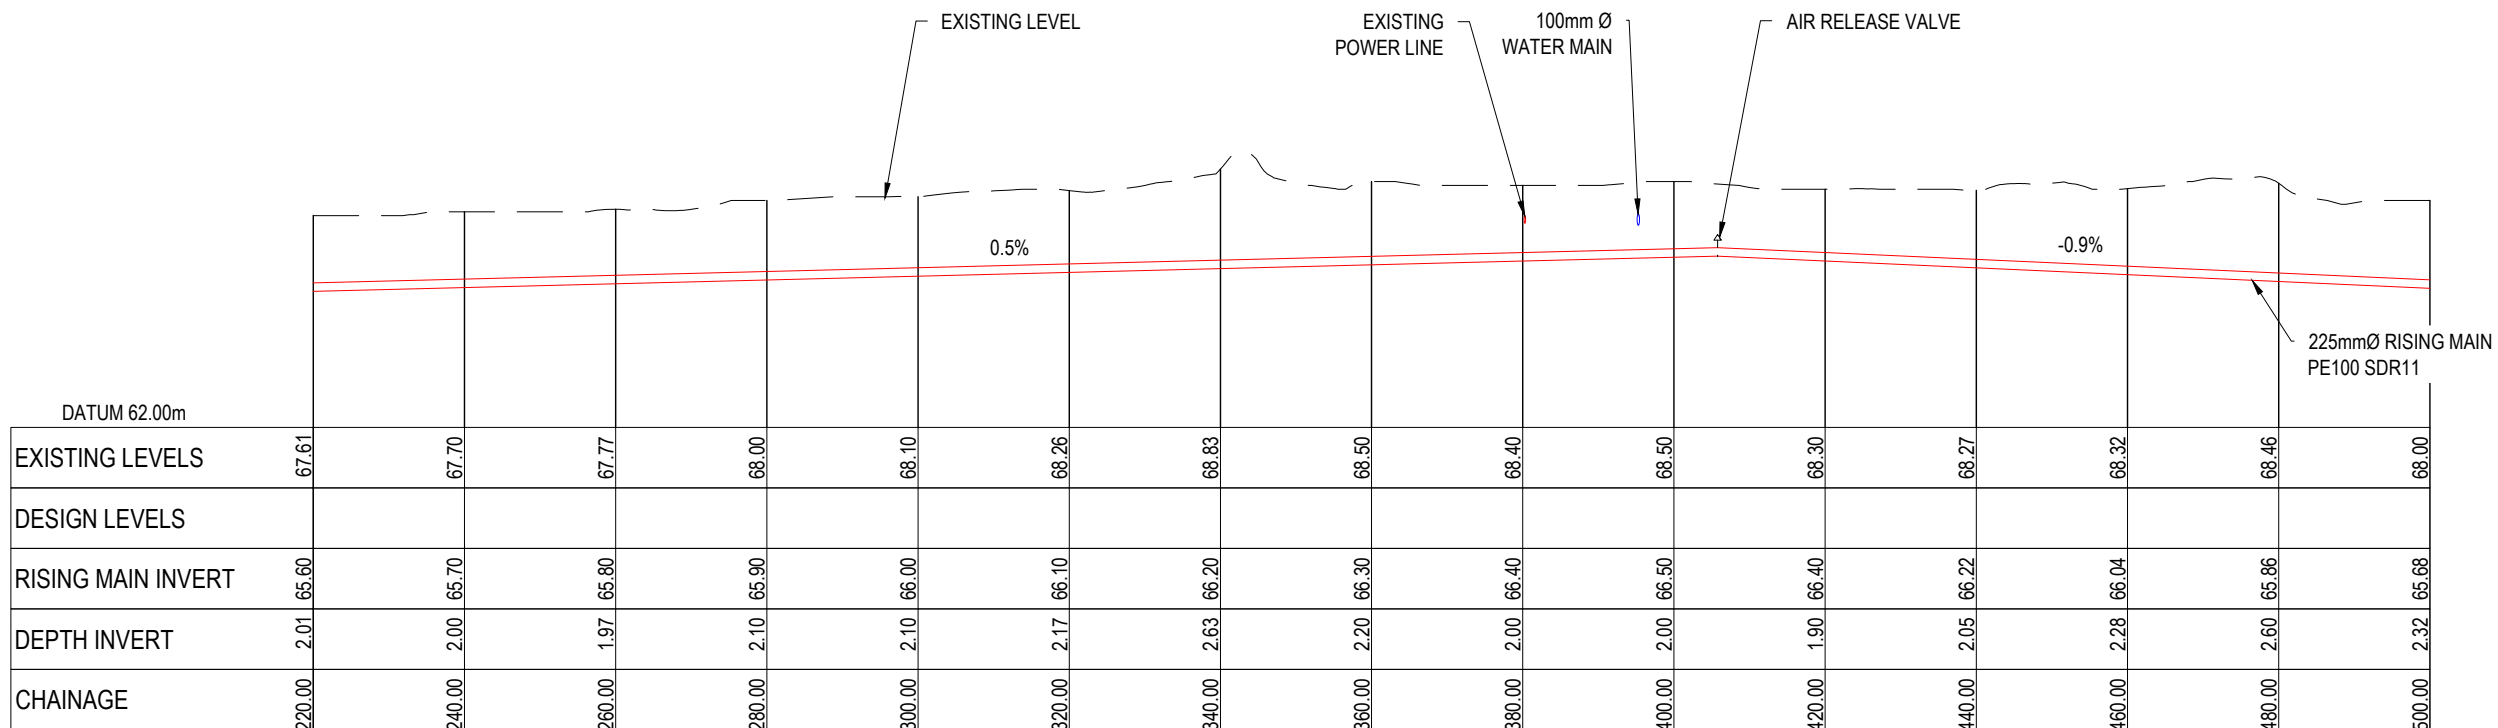

LONGSECTION - CATCHMENT B (RISING MAIN 1 CONT.)  
SCALE 1:1000 HORI & 1:200 VERTICAL @ A3

RESOURCE CONSENT





- Notes
1. All works to be in accordance with Waikato Regional Infrastructure Technical Specifications.
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Legend

— T —	EX BDY
— V —	EX TELECOM
— GAS —	EX POWER
— W —	EX GAS
— W —	EX WASTEWATER
— W —	EX STORMWATER
— W —	EX WATER SUPPLY
— W —	PROP WW
— W —	WW RISING MAIN
— W —	EX/PROP WWMH


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D	FAST TRACK APP	MKS	06/2025
C	FAST TRACK APP	MKS	05/2025
B	FAST TRACK APP	MKS	04/2025
Rev	Description	By	Date
		By	Date
Survey	MAVEN		05/2024
Design	MKS		04/2025
Drawn	MKS		04/2025
Checked	DJM		06/2025

**M** **Maven Associates**  
09 571 0050  
info@maven.co.nz  
www.maven.co.nz  
5 Owens Road, Epsom  
Auckland 1023

Project  
**ASHBOURNE  
RESIDENTIAL  
FOR  
MATAMATA  
DEVELOPMENTS LTD**

Title  
**PROPOSED  
WWPS RISING MAIN  
LONGSECTION**


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Drawing no.	C540-3	Rev	E

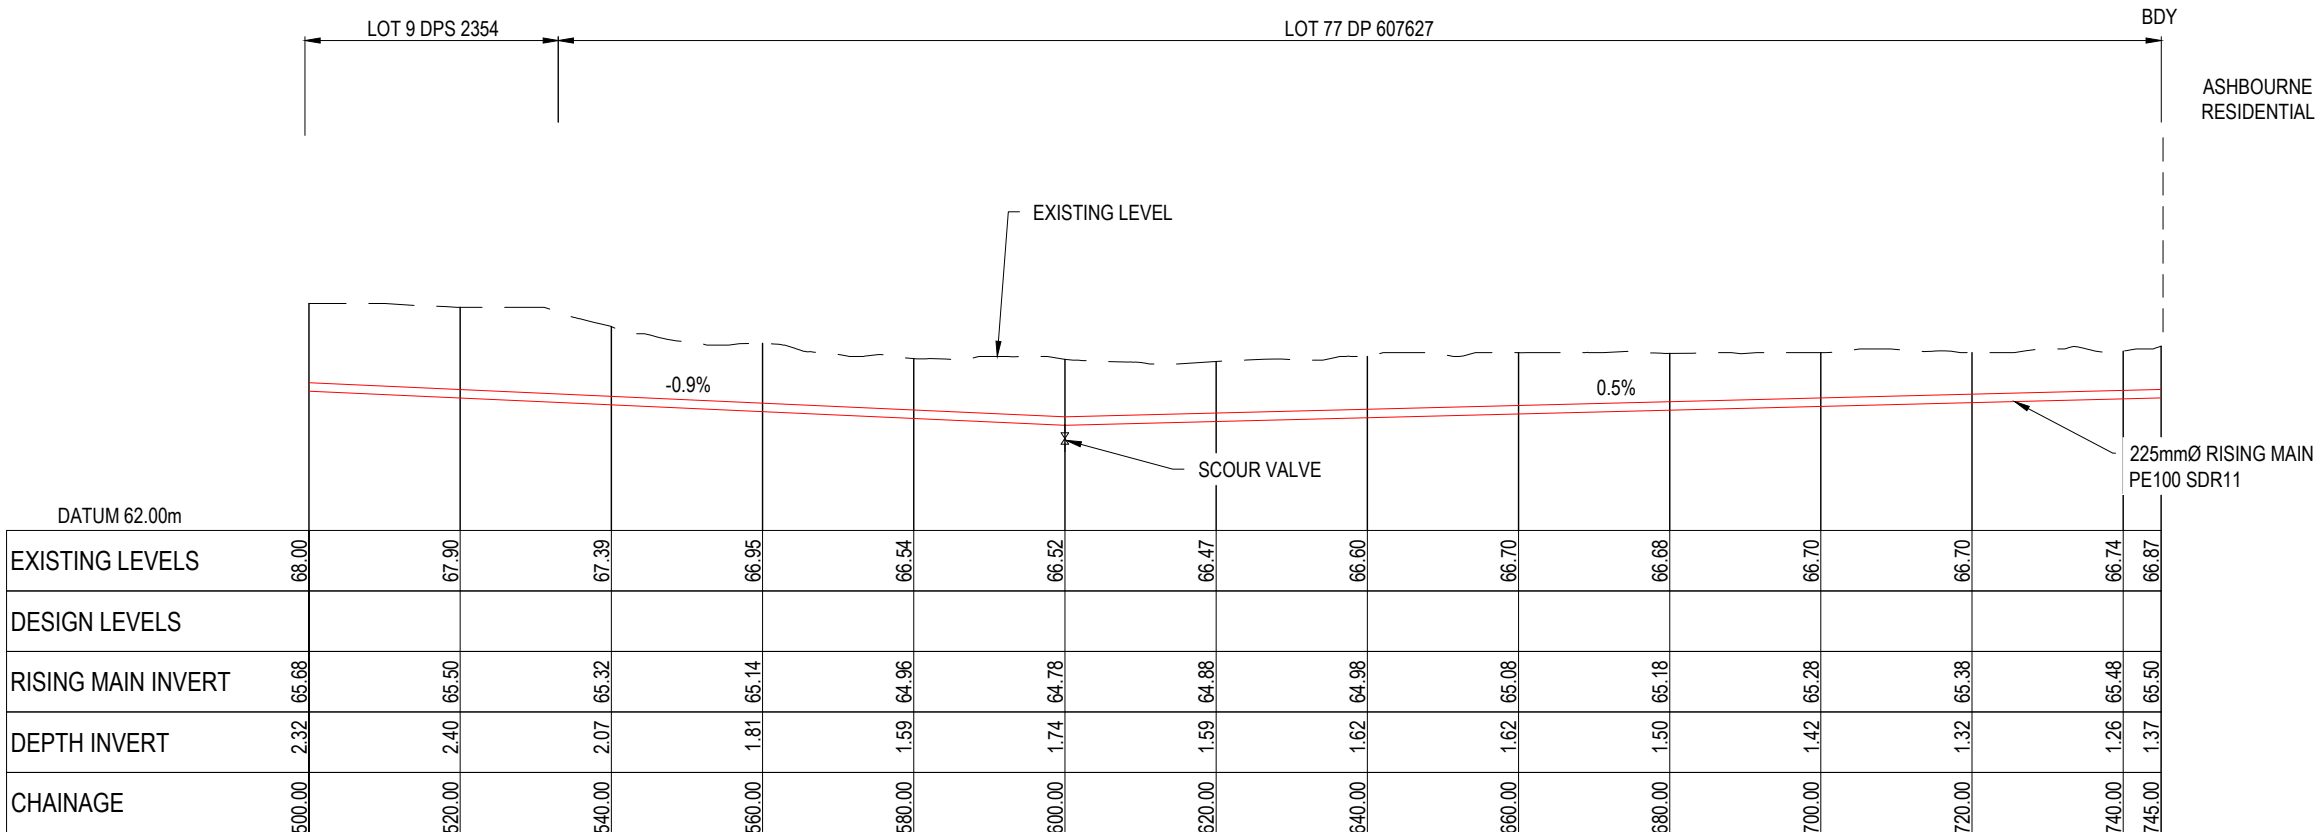

LONGSECTION - CATCHMENT B (RISING MAIN 1 CONT.)  
SCALE 1:1000 HORI & 1:200 VERTICAL @ A3

RESOURCE CONSENT



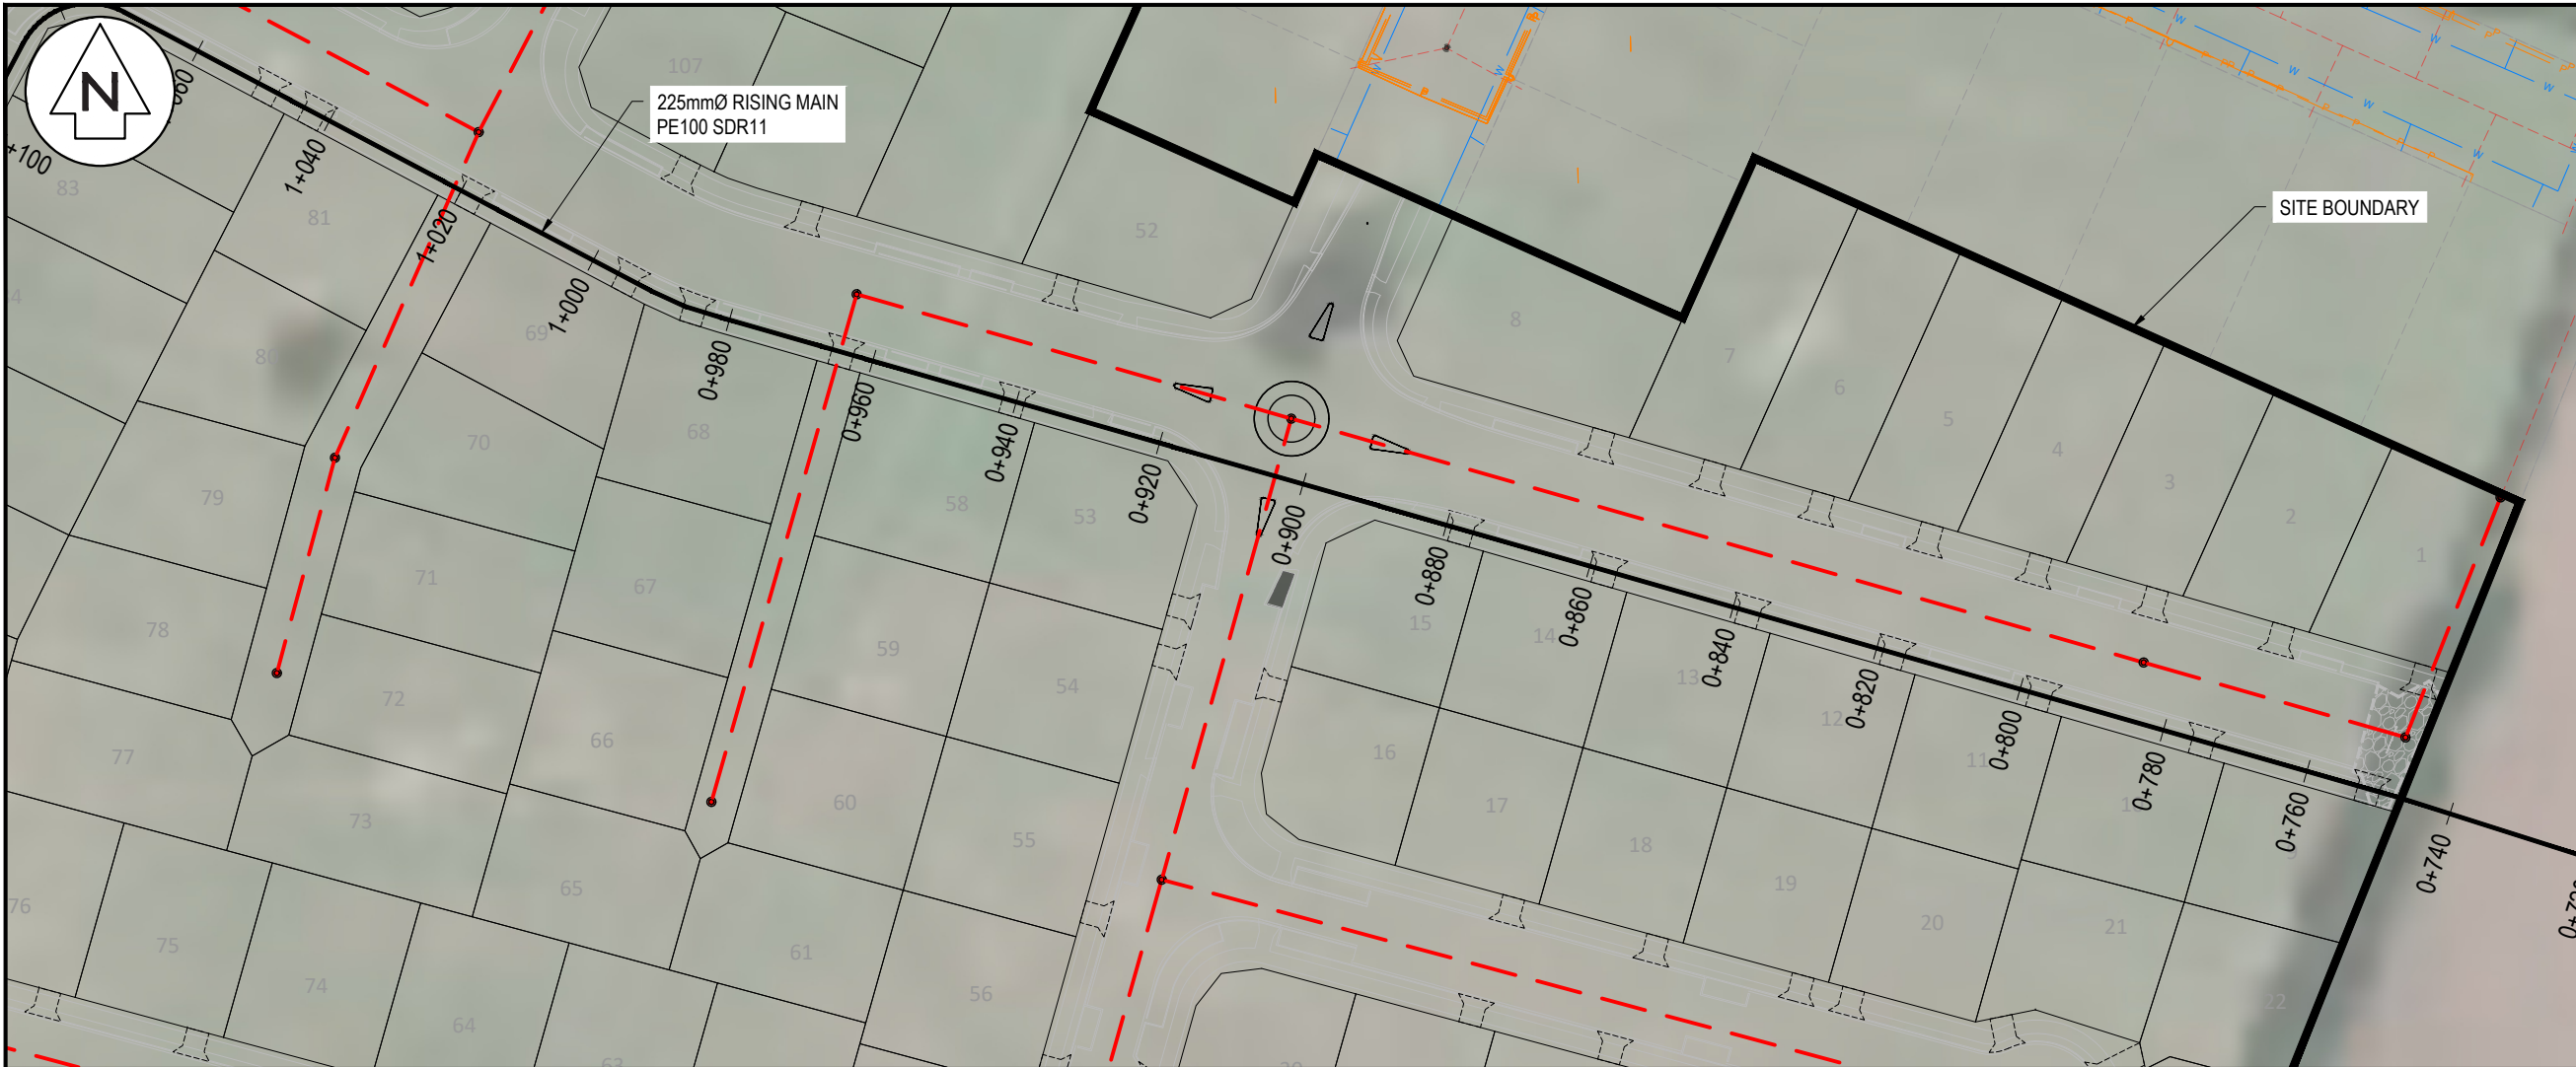

- Notes
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Legend	
	EX BDY
	EX TELECOM
	EX POWER
	EX GAS
	EX WASTEWATER
	EX STORMWATER
	EX WATER SUPPLY
	PROP WW
	WW RISING MAIN
	EX/PROP WWMH


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D	FAST TRACK APP	MKS	06/2025
C	FAST TRACK APP	MKS	05/2025
B	FAST TRACK APP	MKS	04/2025
Rev	Description	By	Date
		MAVEN	05/2024
Survey			
Design	MKS		04/2025
Drawn	MKS		04/2025
Checked	DJM		06/2025

**Maven Associates**  
09 571 0050  
info@maven.co.nz  
www.maven.co.nz  
5 Owens Road, Epsom  
Auckland 1023

Project  
**ASHBOURNE  
RESIDENTIAL  
FOR  
MATAMATA  
DEVELOPMENTS LTD**

Title  
**PROPOSED  
WWPS RISING MAIN  
LONGSECTION**

Project no.	289001		
Scale	1:1000 @ A3		
Cad file	C540-WWPS LS.DWG		
Drawing no.	C540-4	Rev	E

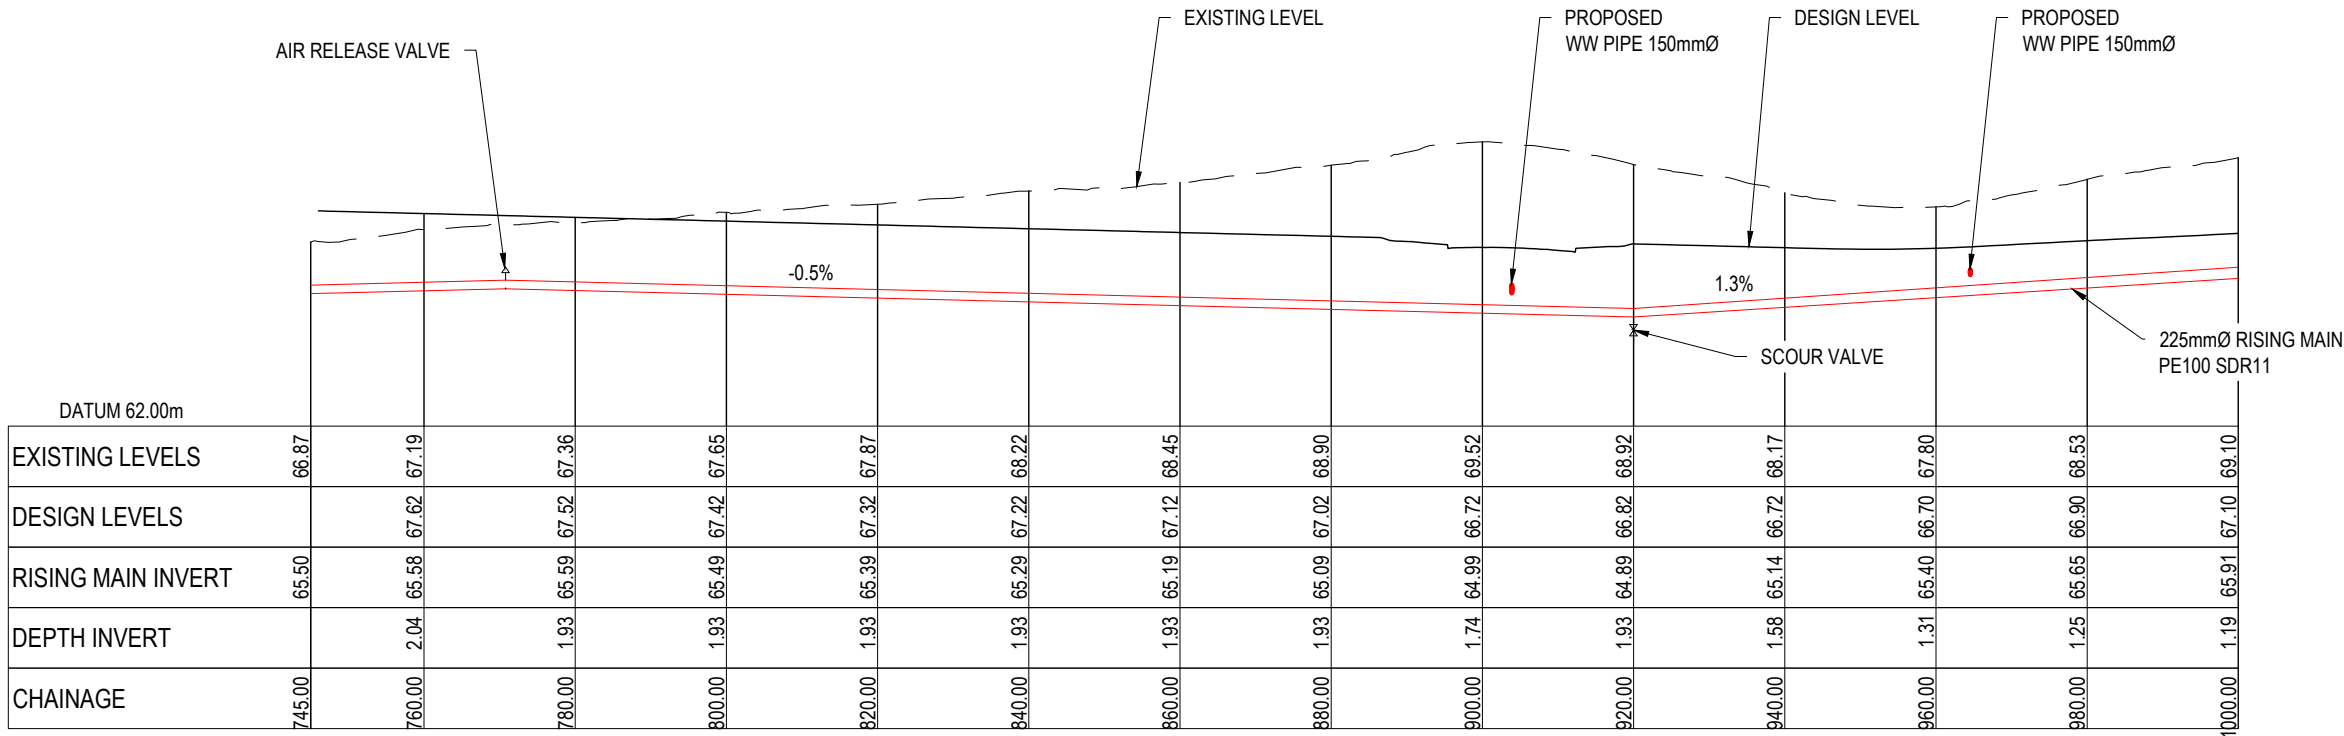

LONGSECTION - CATCHMENT B (RISING MAIN 1 CONT.)  
SCALE 1:1000 HORI & 1:200 VERTICAL @ A3

RESOURCE CONSENT




Notes

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Legend

— T — T —	EX BDY
— V — V —	EX TELECOM
— GAS — GAS —	EX POWER
— W — W —	EX GAS
— W — W —	EX WASTEWATER
— W — W —	EX STORMWATER
— W — W —	EX WATER SUPPLY
— W — W —	PROP WW
— W — W —	WW RISING MAIN
— W — W —	EX/PROP WWMH

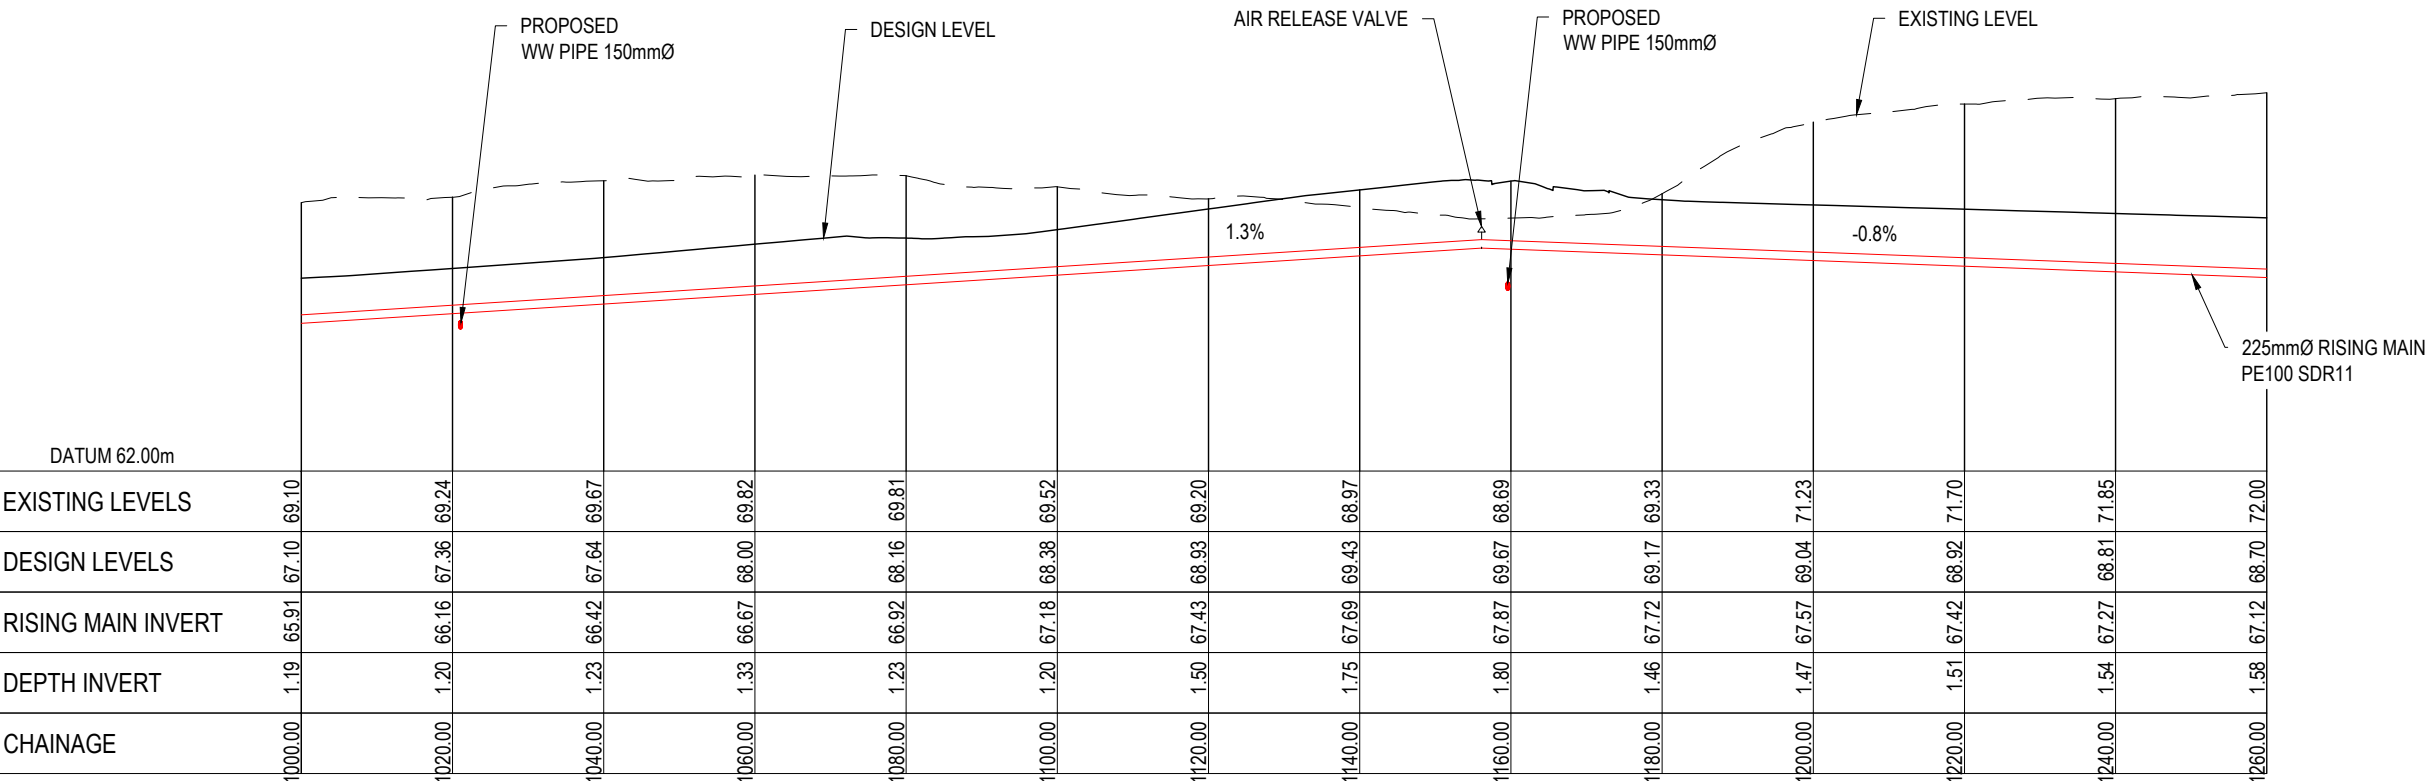

DATUM 62.00m	
EXISTING LEVELS	69.10 69.24 69.67 69.82 69.81 69.52 69.20 68.97 68.69 69.33 71.23 71.70 71.85 72.00
DESIGN LEVELS	67.10 67.36 67.64 68.00 68.16 68.38 68.93 69.43 69.67 69.17 69.04 68.92 68.81 68.70
RISING MAIN INVERT	65.91 66.16 66.42 66.67 66.92 67.18 67.43 67.69 67.87 67.72 67.57 67.42 67.27 67.12
DEPTH INVERT	1.19 1.20 1.23 1.33 1.23 1.20 1.50 1.75 1.80 1.46 1.47 1.51 1.54 1.58
CHAINAGE	1000.00 1020.00 1040.00 1060.00 1080.00 1100.00 1120.00 1140.00 1160.00 1180.00 1200.00 1220.00 1240.00 1260.00

LONGSECTION - CATCHMENT B (RISING MAIN 1 CONT.)  
SCALE 1:1000 HORI & 1:200 VERTICAL @ A3

RESOURCE CONSENT

E	FAST TRACK APP	RJM	11/2025
D	FAST TRACK APP	MKS	06/2025
C	FAST TRACK APP	MKS	05/2025
B	FAST TRACK APP	MKS	04/2025
Rev	Description	By	Date
		By	Date
Survey	MAVEN		05/2024
Design	MKS		04/2025
Drawn	MKS		04/2025
Checked	DJM		06/2025

**Maven Associates**  
09 571 0050  
info@maven.co.nz  
www.maven.co.nz  
5 Owens Road, Epsom  
Auckland 1023

Project

**ASHBOURNE  
RESIDENTIAL  
FOR  
MATAMATA  
DEVELOPMENTS LTD**

Title

**PROPOSED  
WWPS RISING MAIN  
LONGSECTION**

Project no.	289001		
Scale	1:1000 @ A3		
Cad file	C540-WWPS LS.DWG		
Drawing no.	C540-5	Rev	E





- Notes
1. All works to be in accordance with Waikato Regional Infrastructure Technical Specifications.
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Legend

— T — T —	EX BDY
— V — V —	EX TELECOM
— GAS — GAS —	EX POWER
— W — W —	EX GAS
— W — W —	EX WASTEWATER
— W — W —	EX STORMWATER
— W — W —	EX WATER SUPPLY
— W — W —	PROP WW
— W — W —	WW RISING MAIN
— W — W —	EX/PROP WWMH


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D	FAST TRACK APP	MKS	06/2025
C	FAST TRACK APP	MKS	05/2025
B	FAST TRACK APP	MKS	04/2025
Rev	Description	By	Date
		By	Date
Survey	MAVEN		05/2024
Design	MKS		04/2025
Drawn	MKS		04/2025
Checked	DJM		06/2025

**M** **Maven Associates**  
09 571 0050  
info@maven.co.nz  
www.maven.co.nz  
5 Owens Road, Epsom  
Auckland 1023

Project  
**ASHBOURNE  
RESIDENTIAL  
FOR  
MATAMATA  
DEVELOPMENTS LTD**

Title  
**PROPOSED  
WWPS RISING MAIN  
LONGSECTION**

Project no.	289001		
Scale	1:1000 @ A3		
Cad file	C540-WWPS L.S.DWG		
Drawing no.	C540-6	Rev	E

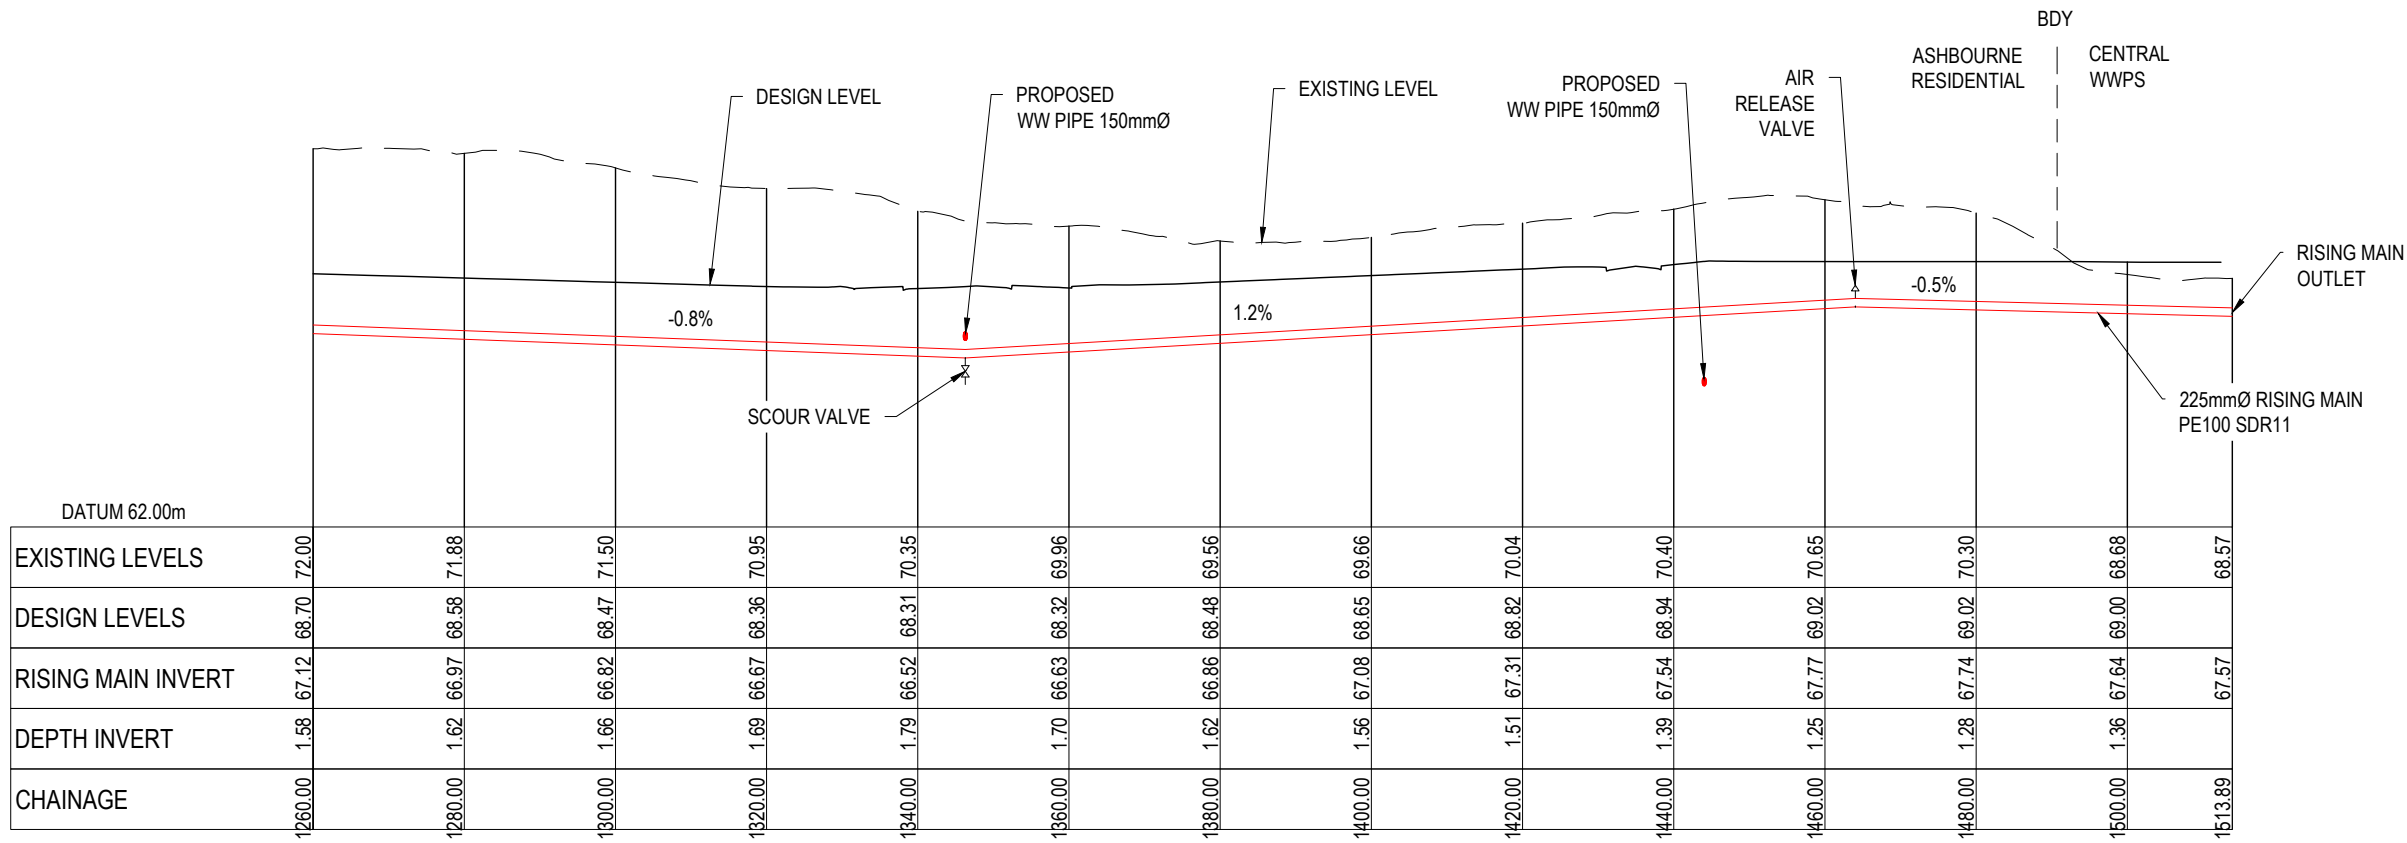

**LONGSECTION - CATCHMENT B (RISING MAIN 1 CONT.)**  
SCALE 1:1000 HORI & 1:200 VERTICAL @ A3

**RESOURCE CONSENT**





PROPOSED  
NORTHERN SOLAR FARM

STATION ROAD

C600-1

C600-2  
STATION ROAD

C600-3

C600-4

BALANCE LOT

PROPOSED  
RETIREMENT VILLAGE

C600-5

C600-6

C600-7

C600-8

C600-9

PROPOSED  
SOUTHERN SOLAR FARM

C600-10

C600-11

LOT 3 DP 463448

LOT 77  
DP 07627

LOT 1 DP 463448

#### NOTES

1. ALL WORKS TO BE IN ACCORDANCE WITH REGIONAL INFRASTRUCTURE TECHNICAL SPECIFICATIONS (RITS).
2. CO-ORDINATES IN TERMS OF NZ GEODETIC DATUM MOUNT EDEN 2000.
3. LEVELS IN TERMS OF THE NEW ZEALAND VERTICAL DATUM 2016.
4. BENCHMARK: IT 1 DPS 29877 RL:65.51. SOURCED FROM THE LINZ GEODETIC DATABASE.
5. ALL WATER LINES TO BE BLANK CAPPED BEYOND STAGING BOUNDARY. CONTRACTOR TO MAKE SURE BLANK CAP IS OUTSIDE OF FOOTPATH EXTENTS AND ACCESSIBLE FOR FUTURE EXTENSIONS.
6. ALL TOBIES WITHIN RIGHT OF WAYS (ROW) TO BE PLACED IN HEAVY DUTY TRAFFICABLE MANIFOLD BOX.
7. EXISTING SERVICES SHOWN ARE FROM B4UDIG AND ARE INDICATIVE ONLY. CONTRACTOR TO CONFIRM THEIR LOCATION PRIOR TO CONSTRUCTION.
8. THRUST BLOCKS HAVE NOT BEEN INDICATED ON DETAILS, ALL THRUST BLOCKS TO BE INSTALLED AS PER REGIONAL INFRASTRUCTURE TECHNICAL SPECIFICATIONS (RITS). PLEASE REFER DETAILS ON SHEET C680-20.

#### Legend

PR BOUNDARY	EX BDY
EX WATERMAIN	EX/PR HYDRANT
EX/PR METER	EX/PR SLUICE VALVE
EX/PR PEET VALVE	PR WATERMAIN
PR LOT CONNECTION	PR FLUSHING VALVE
PR STORMWATER	PR WASTEWATER
EX/PR BLANKCAP	

E	FAST TRACK APP	GNT	11/2025
D	FAST TRACK APP	MKS	06/2025
C	FAST TRACK APP	MKS	05/2025
B	FAST TRACK APP	TCH	04/2025
Rev	Description	By	Date
Survey	MAVEN		03/2024
Design	TCH		04/2025
Drawn	TCH		04/2025
Checked	DJM		06/2025




Project  
**ASHBOURNE  
RESIDENTIAL  
FOR  
MATAMATA  
DEVELOPMENTS LTD**

Title  
**PROPOSED  
WATER SUPPLY  
KEY PLAN**

Project no.	289001		
Scale	1:6000 @ A3		
Cad file	C600-WATERSUPPLY.DWG		
Drawing no.	C600	Rev	E

RESOURCE CONSENT

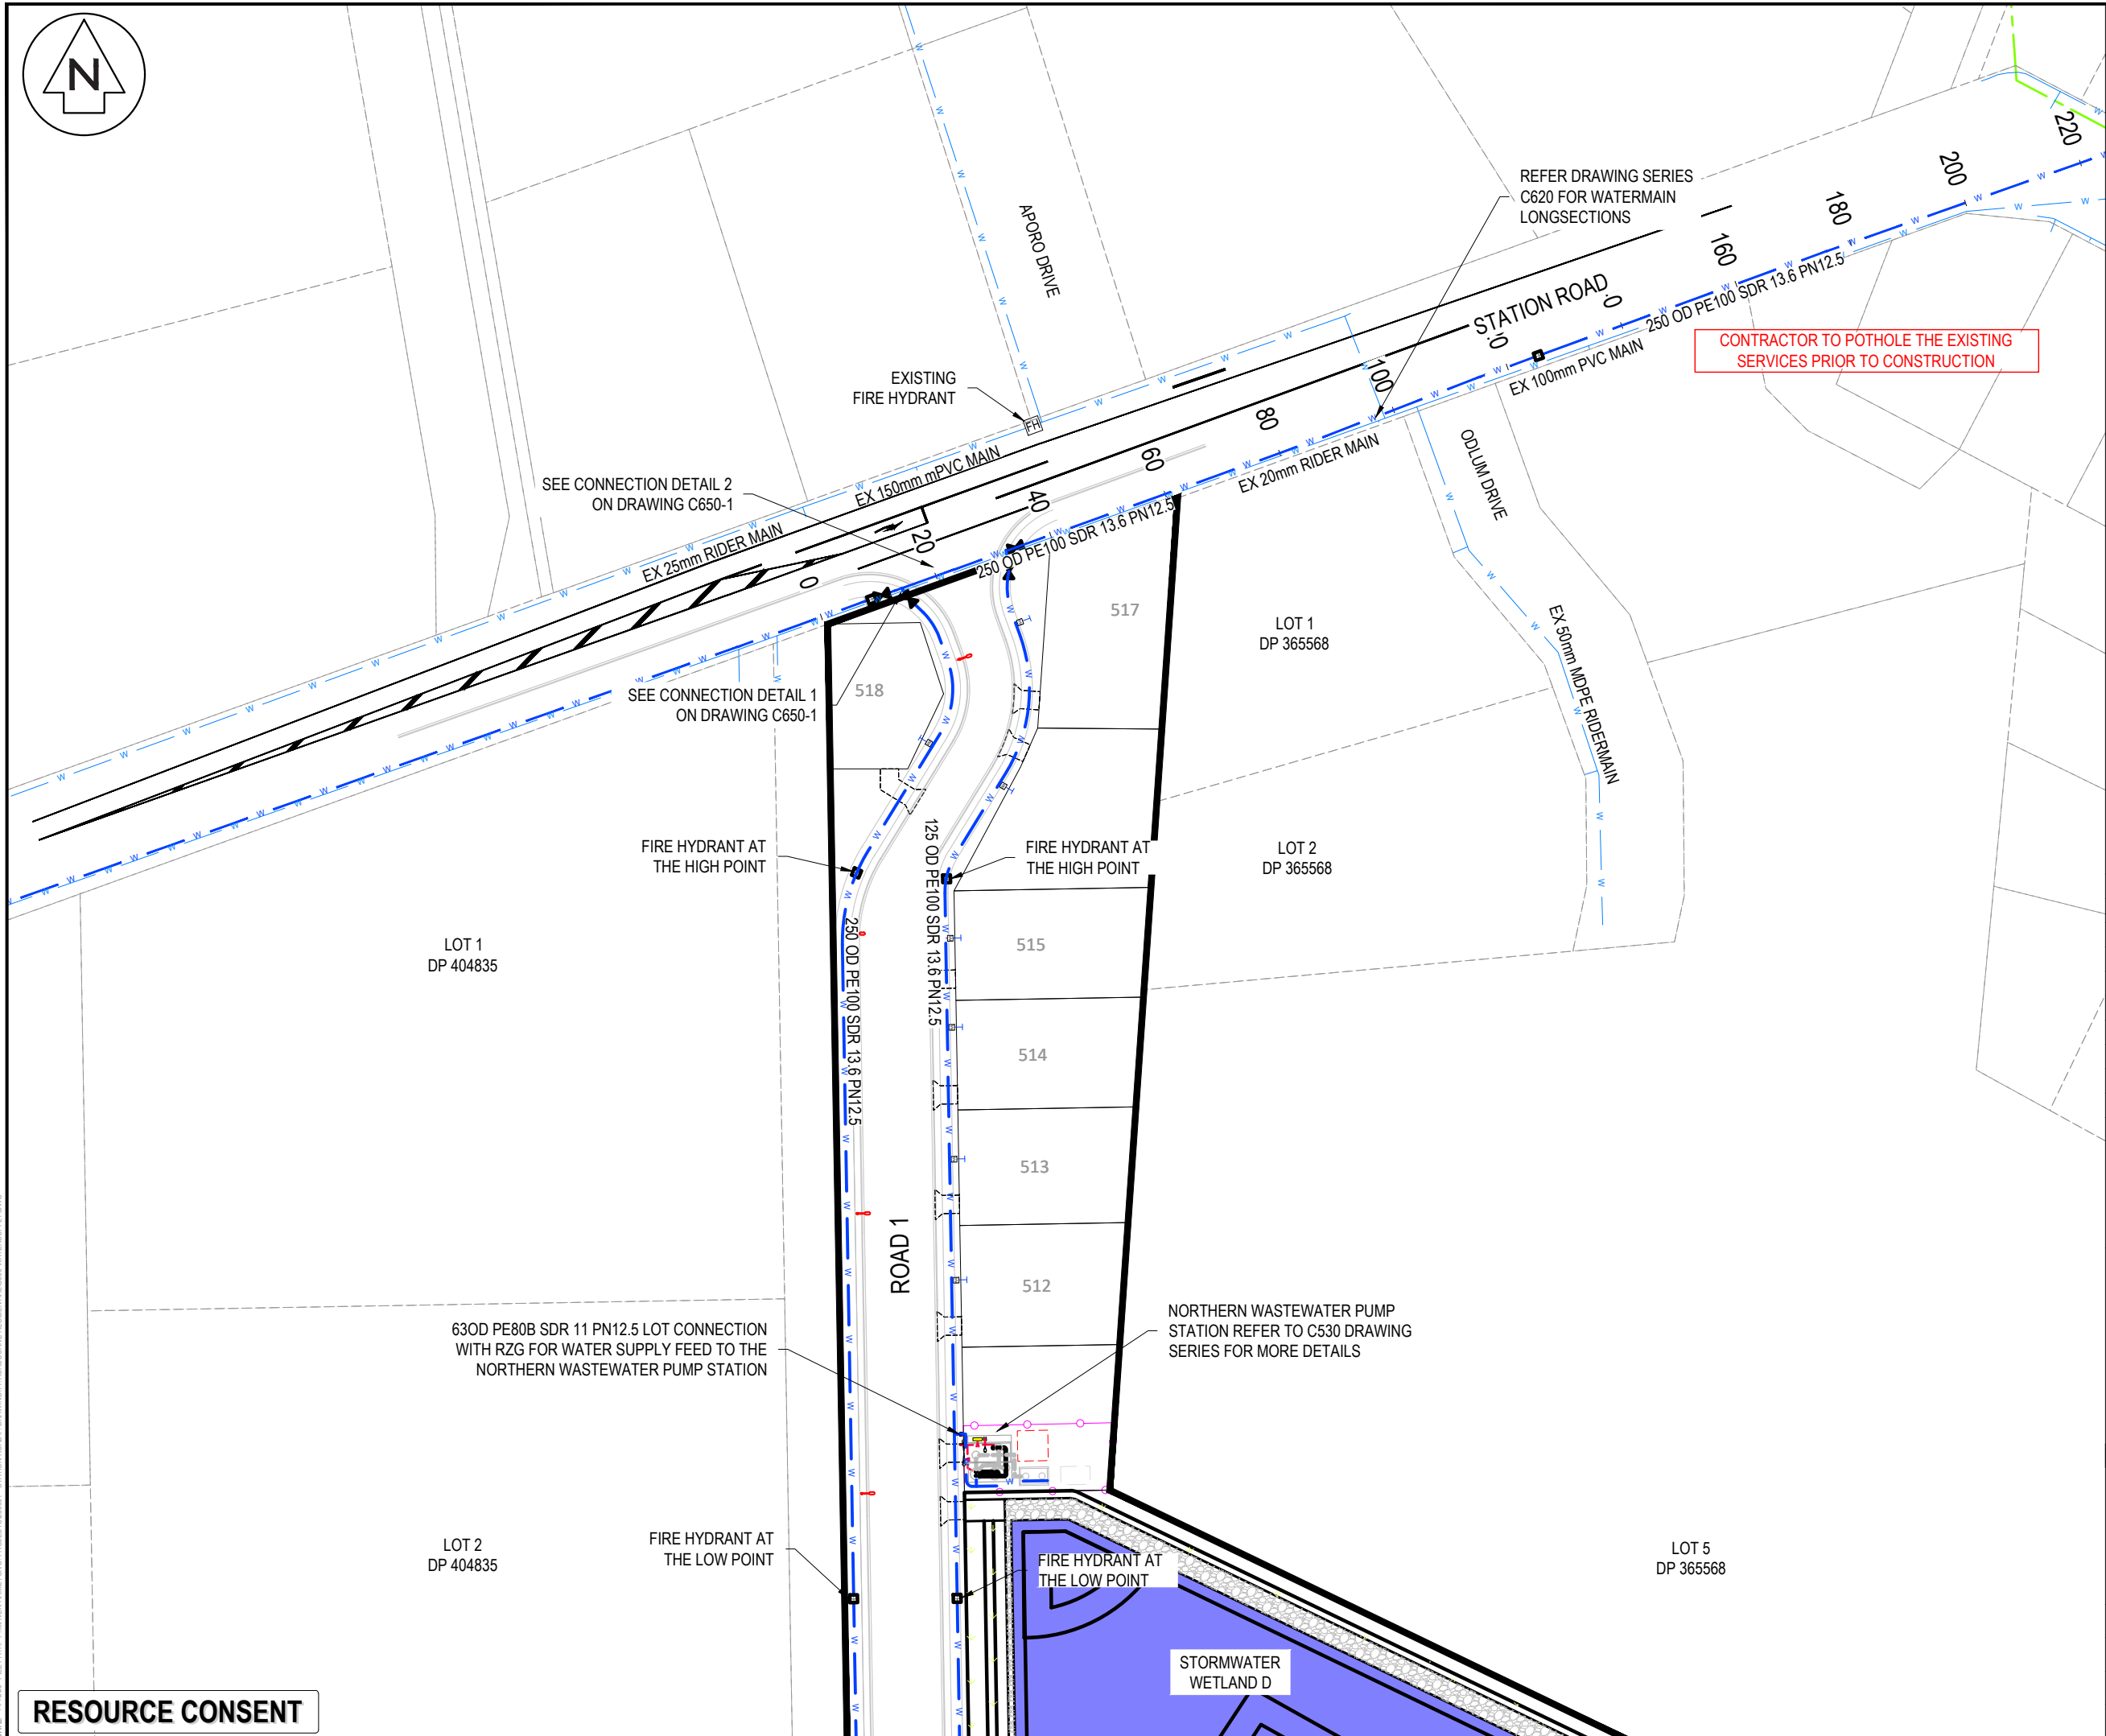

- NOTES
1. ALL WORKS TO BE IN ACCORDANCE WITH REGIONAL INFRASTRUCTURE TECHNICAL SPECIFICATIONS (RITS).
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  3. LEVELS IN TERMS OF THE NEW ZEALAND VERTICAL DATUM 2016.
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Legend

	PR BOUNDARY
	EX BDY
	EX WATERMAIN
	EX/PR HYDRANT
	EX/PR METER
	EX/PR SLUICE VALVE
	EX/PR PEET VALVE
	PR WATERMAIN
	PR LOT CONNECTION
	PR FLUSHING VALVE
	PR STORMWATER
	PR WASTEWATER
	EX/PR BLANKCAP

E	FAST TRACK APP	MKS	11/2025
D	FAST TRACK APP	MKS	06/2025
C	FAST TRACK APP	MKS	05/2025
B	FAST TRACK APP	TCH	04/2025
Rev	Description	By	Date
		By	Date
Survey	MAVEN		03/2024
Design	TCH		04/2025
Drawn	TCH		04/2025
Checked	DJM		06/2025

**Maven Waikato**  
07 242 0601  
info@maven.co.nz  
www.maven.co.nz  
Level 1 286 Victoria Street, Hamilton  
New Zealand


Project  
**ASHBOURNE  
RESIDENTIAL  
FOR  
MATAMATA  
DEVELOPMENTS LTD**

Title  
**PROPOSED  
WATER SUPPLY PLAN  
SHEET 1 OF 11**

Project no.	289001		
Scale	1:1000 @ A3		
Cad file	C600-WATERSUPPLY.DWG		
Drawing no.	C600-1	Rev	E

RESOURCE CONSENT



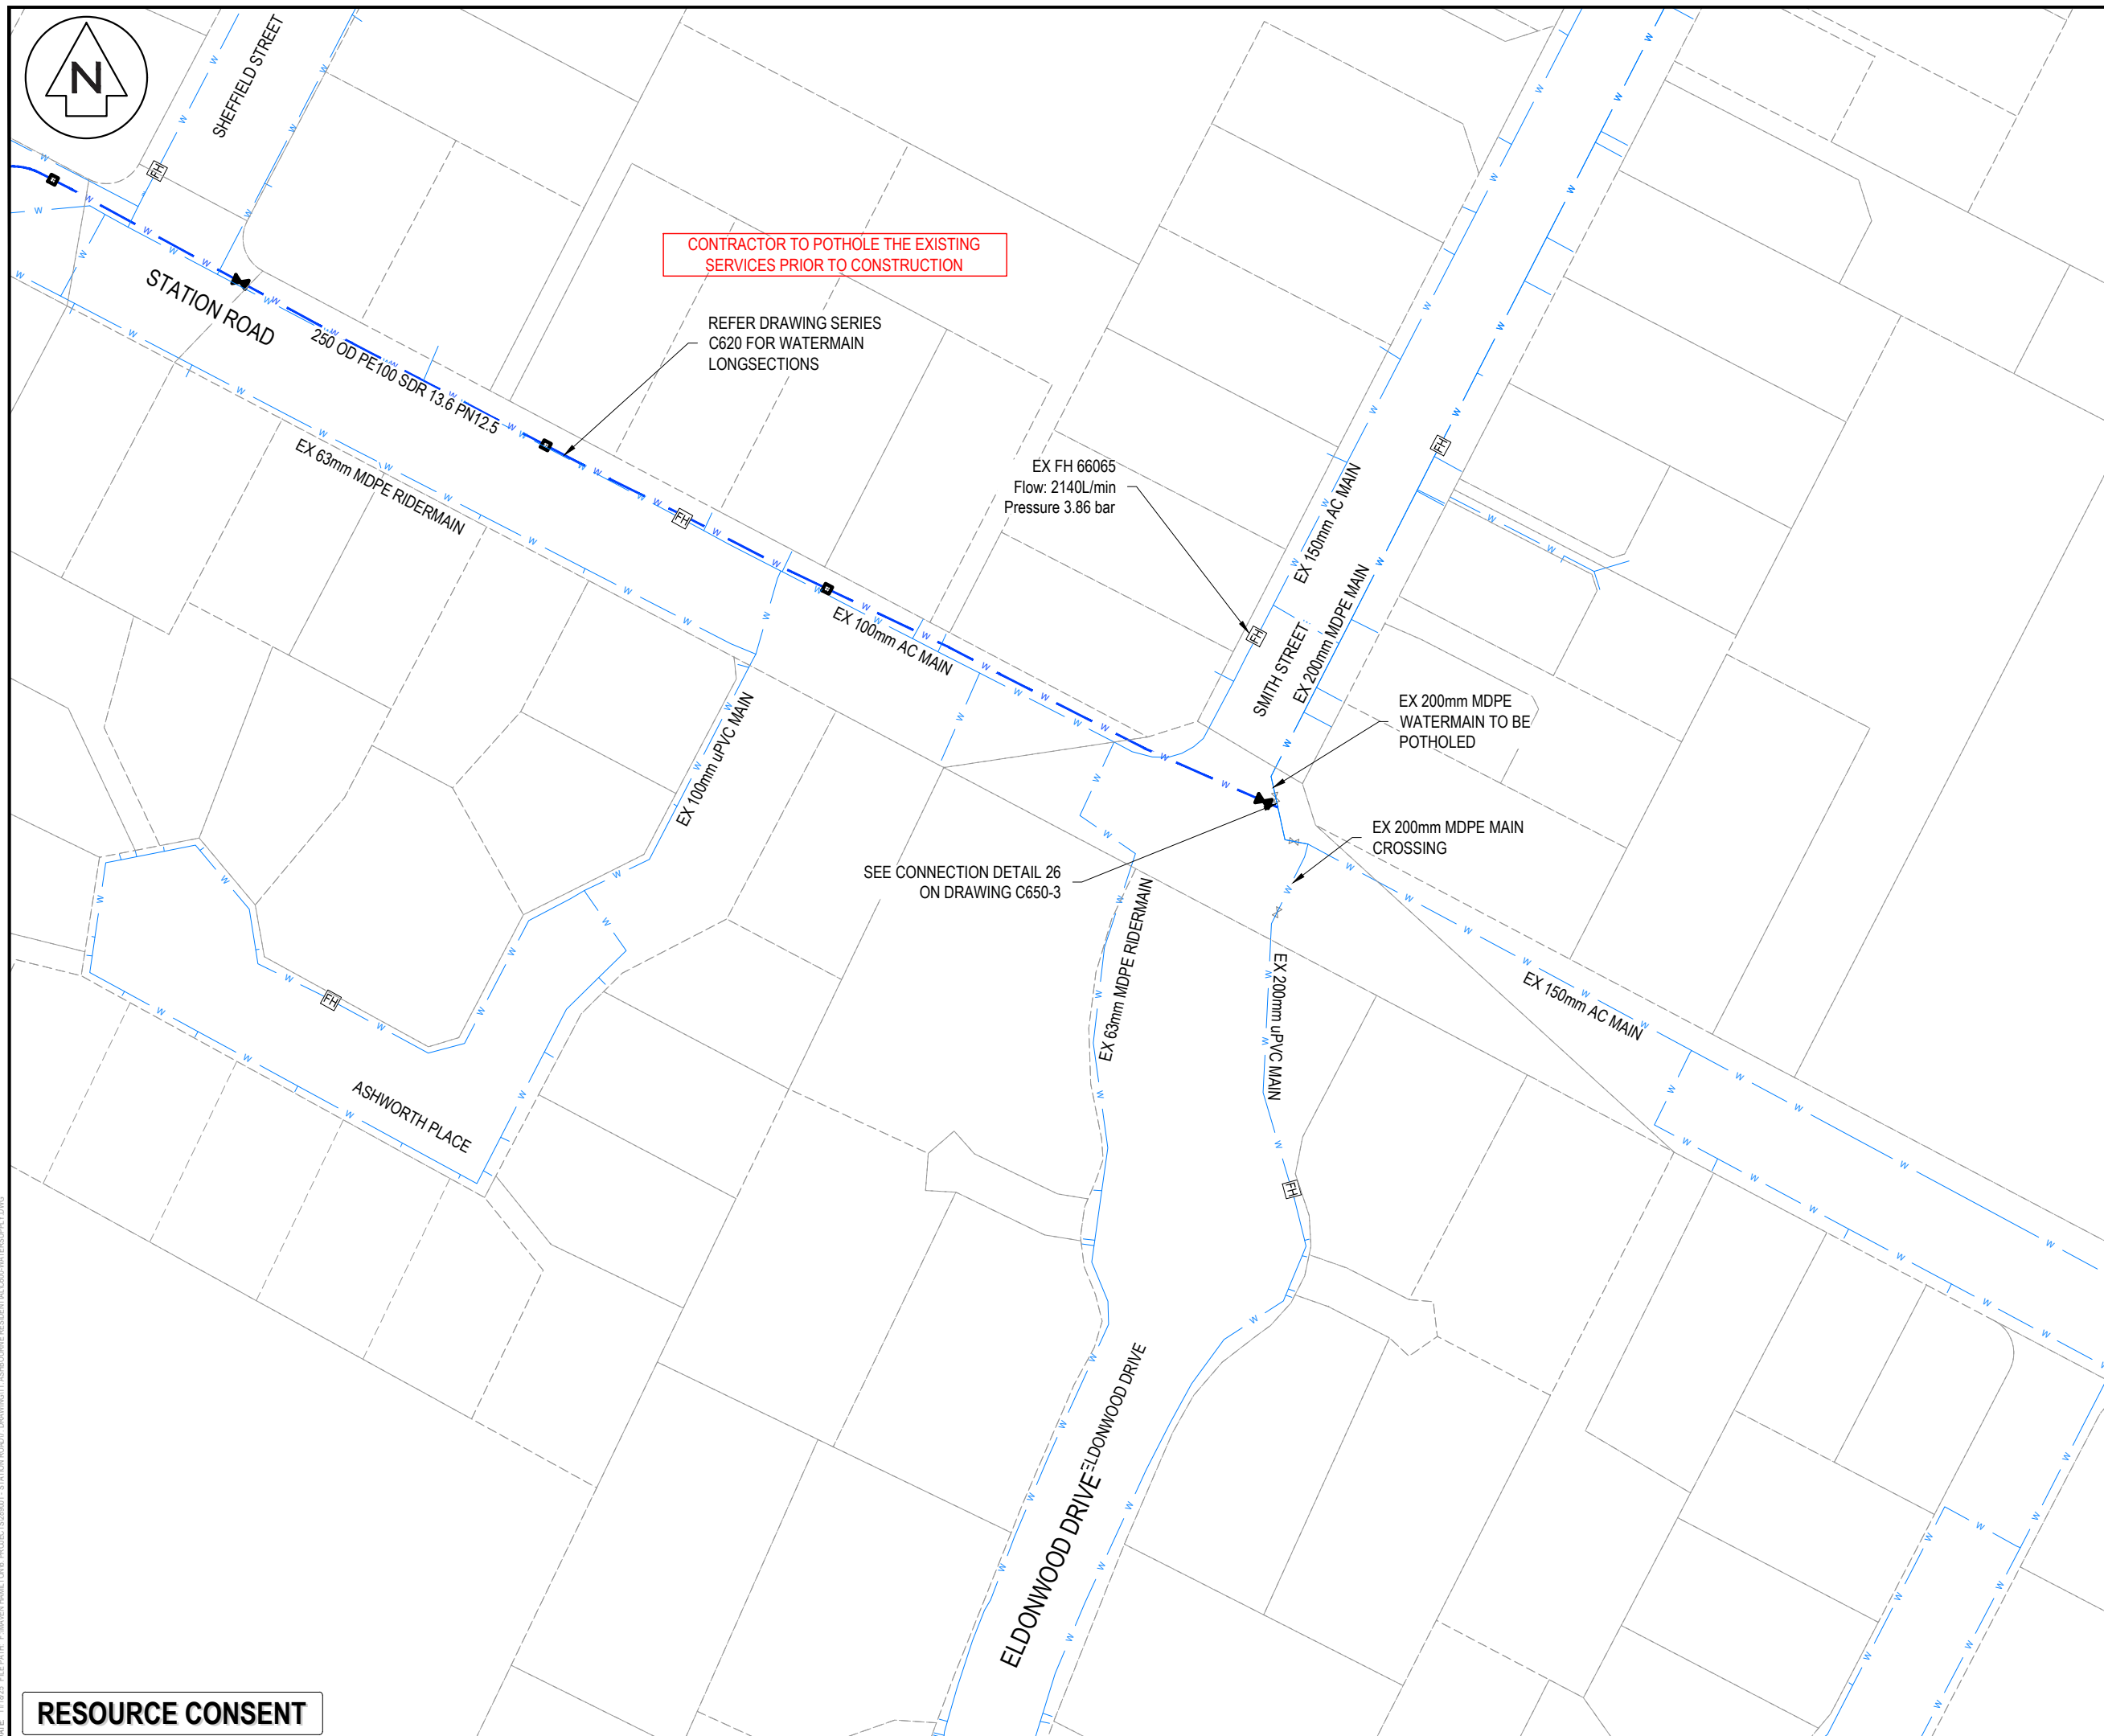

- NOTES
1. ALL WORKS TO BE IN ACCORDANCE WITH REGIONAL INFRASTRUCTURE TECHNICAL SPECIFICATIONS (RITS).
  2. CO-ORDINATES IN TERMS OF NZ GEODETIC DATUM MOUNT EDEN 2000.
  3. LEVELS IN TERMS OF THE NEW ZEALAND VERTICAL DATUM 2016.
  4. BENCHMARK: IT 1 DPS 29877 RL:65.51. SOURCED FROM THE LINZ GEODETIC DATABASE.
  5. ALL WATER LINES TO BE BLANK CAPPED BEYOND STAGING BOUNDARY.  
CONTRACTOR TO MAKE SURE BLANK CAP IS OUTSIDE OF FOOTPATH EXTENTS AND ACCESSIBLE FOR FUTURE EXTENSIONS.
  6. ALL TOBIES WITHIN RIGHT OF WAYS (ROW) TO BE PLACED IN HEAVY DUTY TRAFFICABLE MANIFOLD BOX.
  7. EXISTING SERVICES SHOWN ARE FROM 84UDIG AND ARE INDICATIVE ONLY.  
CONTRACTOR TO CONFIRM THEIR LOCATION PRIOR TO CONSTRUCTION.
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OLIVE PLACE

LOT 3  
DP 404835

LOT 9  
DP 562902

LOT 13  
DP 562902

LOT 14  
DP 562902

STORMWATER  
WETLAND C

ROAD 4

FIRE HYDRANT AT  
THE LOW POINT

ROAD 4

- NOTES
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Legend

	PR BOUNDARY
	EX BDY
	EX WATERMAIN
	EX/PR HYDRANT
	EX/PR METER
	EX/PR SLUICE VALVE
	EX/PR PEET VALVE
	PR WATERMAIN
	PR LOT CONNECTION
	PR FLUSHING VALVE
	PR STORMWATER
	PR WASTEWATER
	EX/PR BLANKCAP

E	FAST TRACK APP	MKS	11/2025
D	FAST TRACK APP	MKS	06/2025
C	FAST TRACK APP	MKS	05/2025
B	FAST TRACK APP	TCH	04/2025
Rev	Description	By	Date
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Survey		TCH	04/2025
Design		TCH	04/2025
Drawn		DJM	06/2025
Checked			




Project  
**ASHBOURNE  
RESIDENTIAL  
FOR  
MATAMATA  
DEVELOPMENTS LTD**

Title  
**PROPOSED  
WATER SUPPLY PLAN  
SHEET 3 OF 11**

Project no.	289001		
Scale	1:1000 @ A3		
Cad file	C600-WATERSUPPLY.DWG		
Drawing no.	C600-3	Rev	E

RESOURCE CONSENT

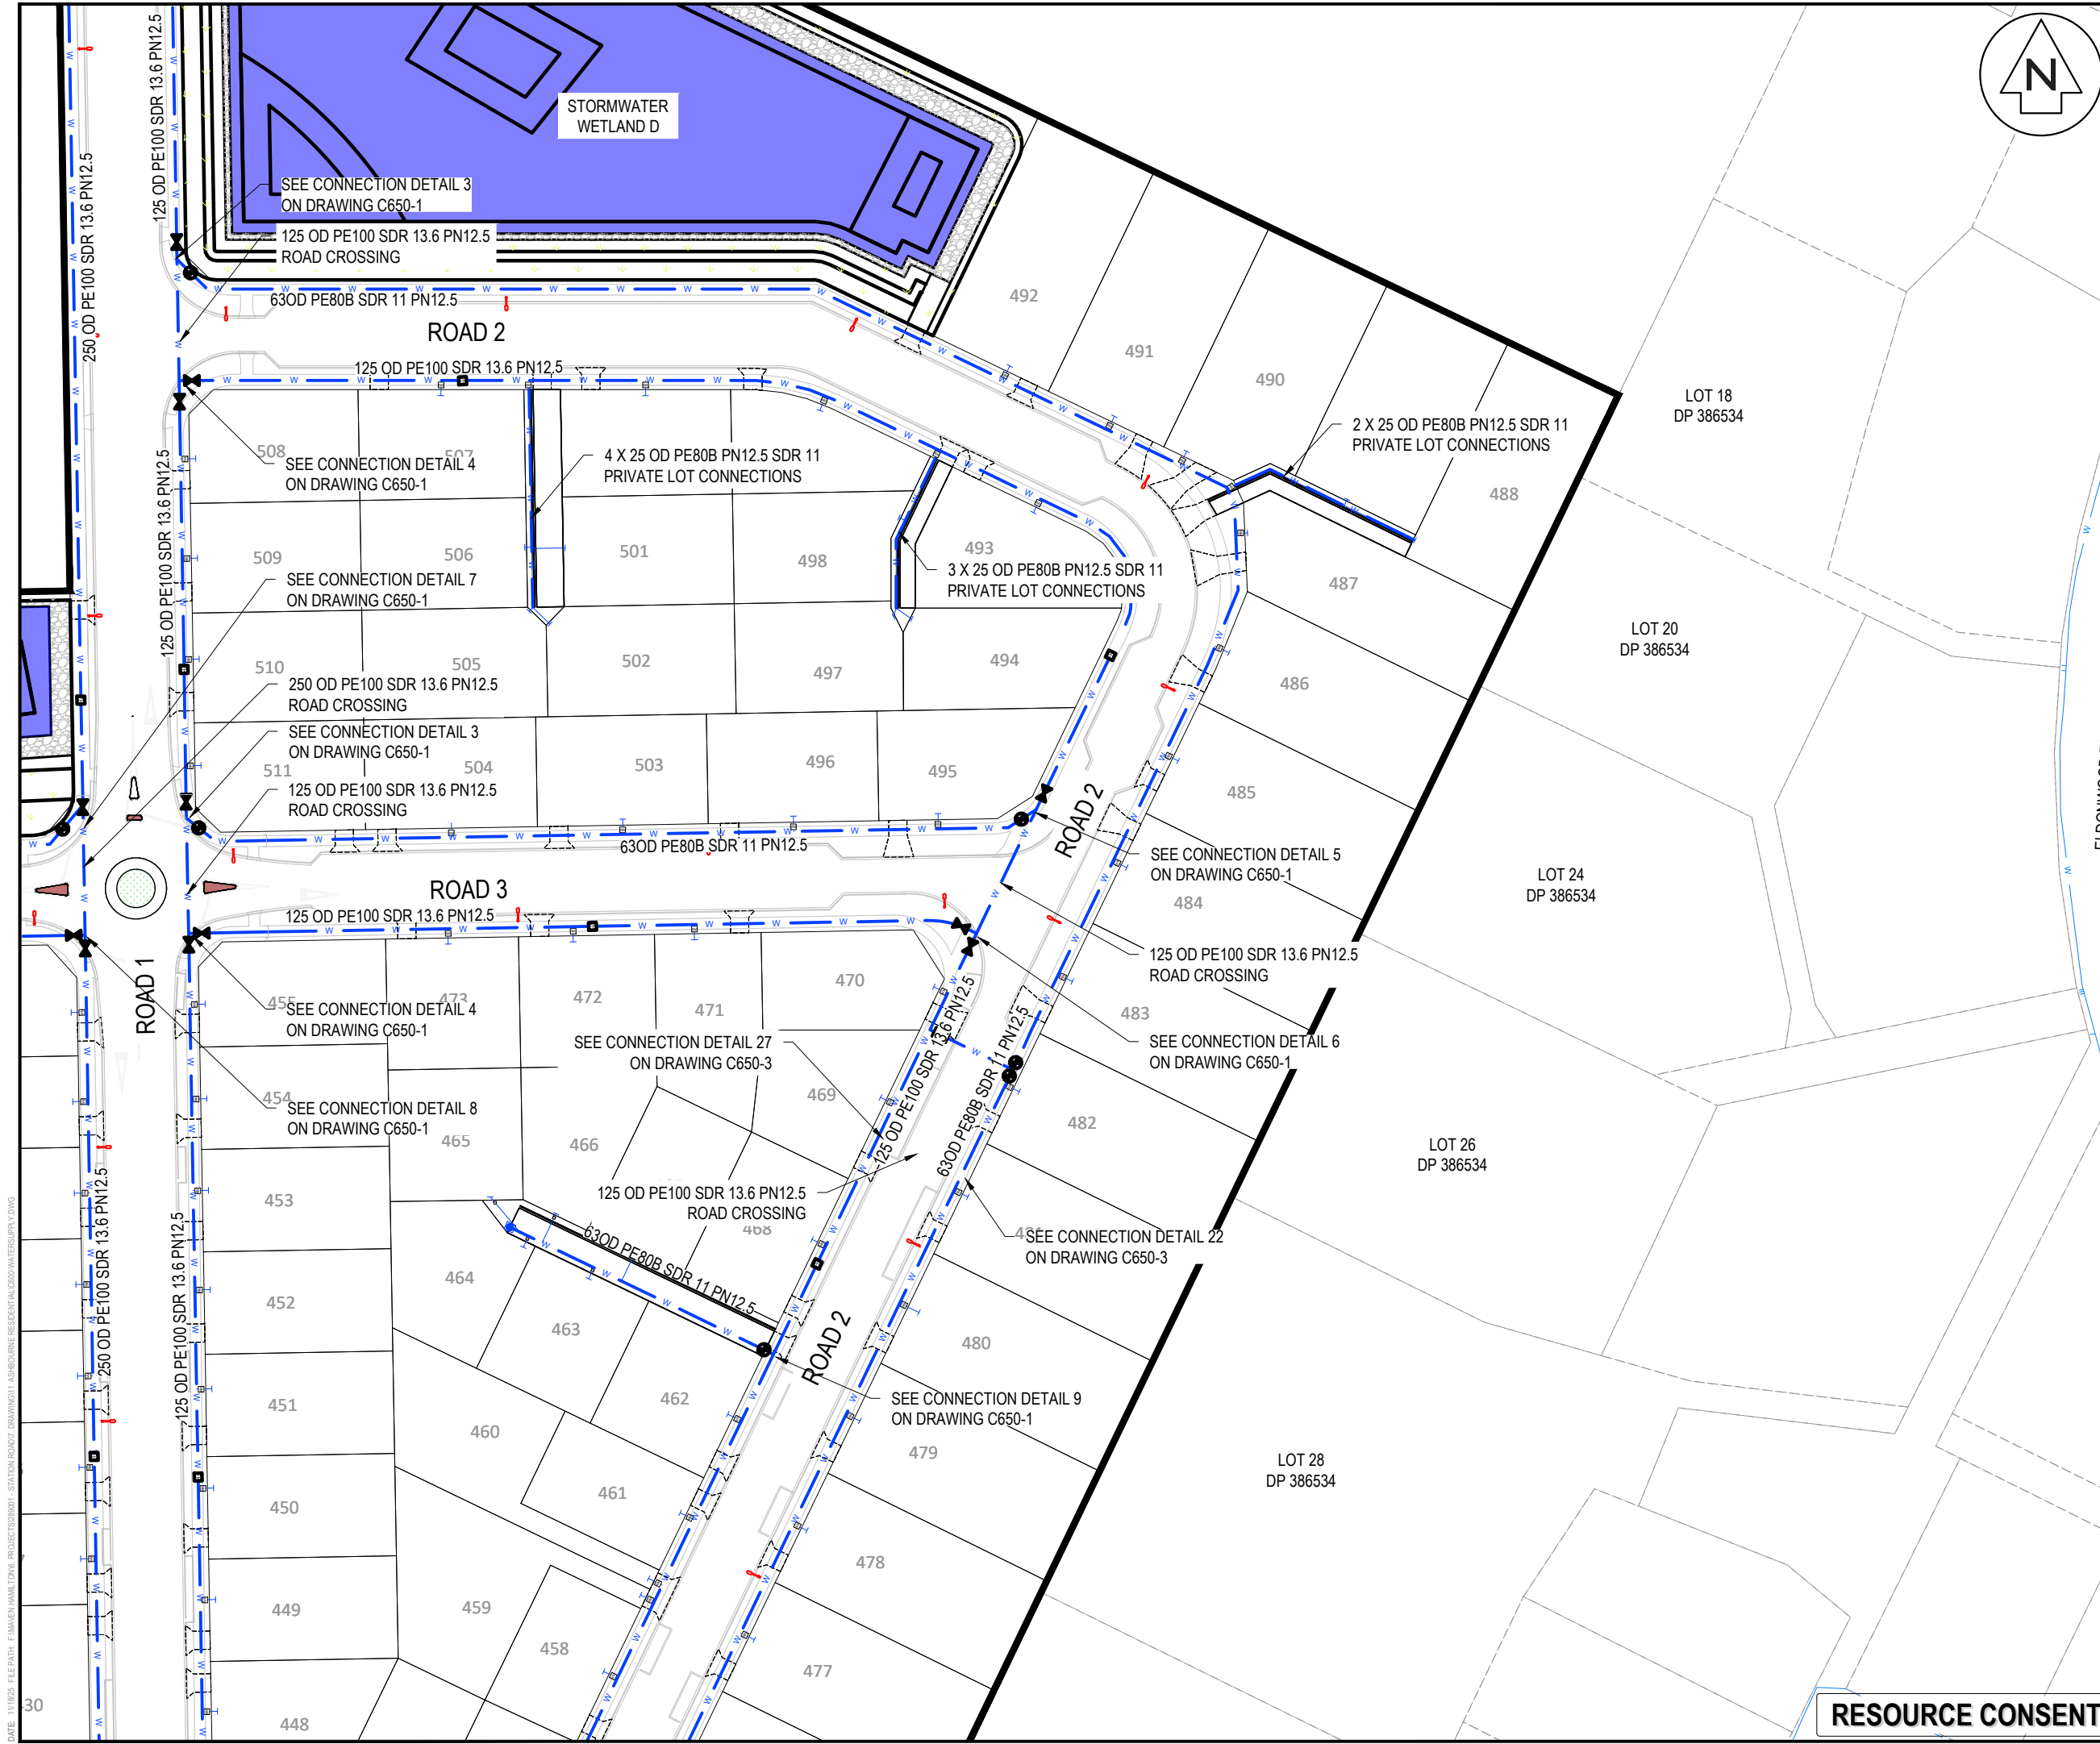

- NOTES
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EX WATERMAIN	EX/PR HYDRANT
EX/PR METER	EX/PR SLUICE VALVE
EX/PR PEET VALVE	EX/PR PEET VALVE
PR WATERMAIN	PR LOT CONNECTION
PR FLUSHING VALVE	PR STORMWATER
PR WASTEWATER	EX/PR BLANKCAP

E	FAST TRACK APP	MKS	11/2025
D	FAST TRACK APP	MKS	06/2025
C	FAST TRACK APP	MKS	05/2025
B	FAST TRACK APP	TCH	04/2025
Rev	Description	By	Date
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Survey	MAVEN		03/2024
Design	TCH		04/2025
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Checked	DJM		06/2025


**M** Maven Waikato  
07 242 0601  
info@maven.co.nz  
www.maven.co.nz  
Level 1 286 Victoria Street, Hamilton  
New Zealand

Project  
**ASHBOURNE  
RESIDENTIAL  
FOR  
MATAMATA  
DEVELOPMENTS LTD**

Title  
**PROPOSED  
WATER SUPPLY PLAN  
SHEET 4 OF 11**

Project no.	289001
Scale	1:1000 @ A3
Cad file	C600-WATERSUPPLY.DWG
Drawing no.	C600-4
Rev	E

**RESOURCE CONSENT**

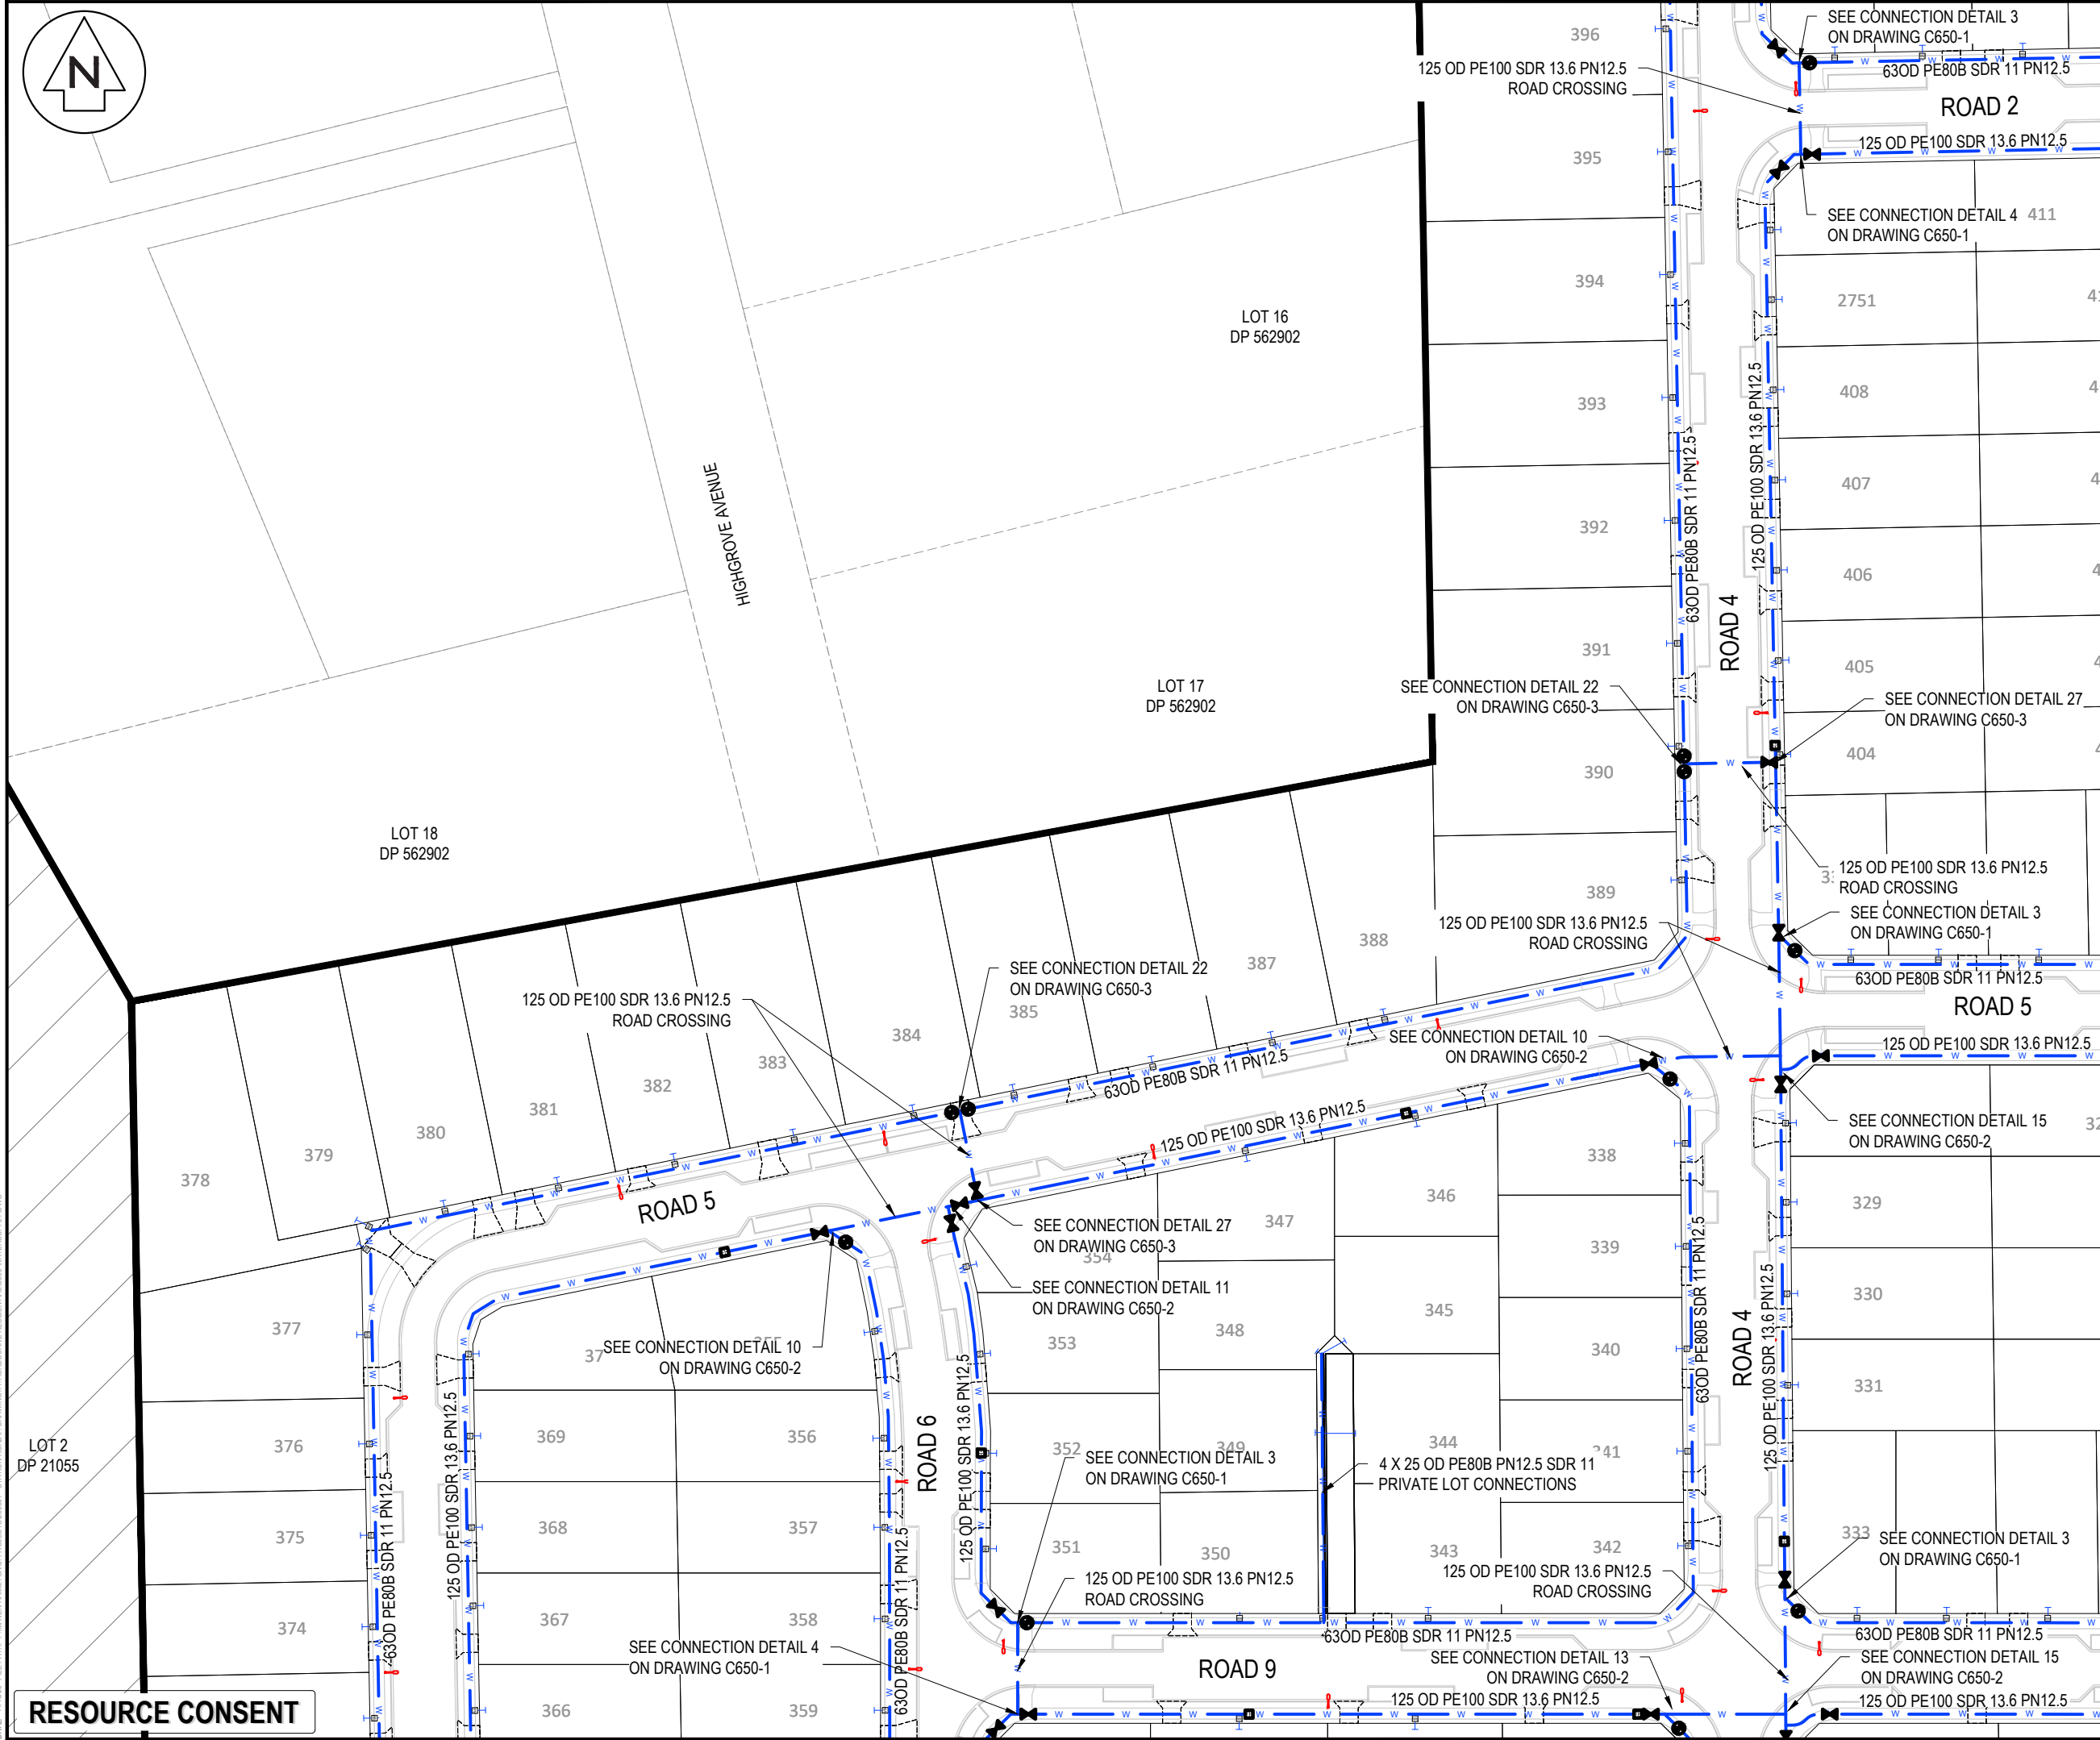

NOTES

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	PR WASTEWATER
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E	FAST TRACK APP	GNT	11/2025
D	FAST TRACK APP	MKS	06/2025
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Rev	Description	By	Date
		By	Date
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Design	TCH		04/2025
Drawn	TCH		04/2025
Checked	DJM		06/2025

**Maven Waikato**  
07 242 0601  
info@maven.co.nz  
www.maven.co.nz  
Level 1 286 Victoria Street, Hamilton  
New Zealand

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Title


**PROPOSED  
WATER SUPPLY PLAN  
SHEET 5 OF 11**

Project no.	289001		
Scale	1:1000 @ A3		
Cad file	C600-WATERSUPPLY.DWG		
Drawing no.	C600-5	Rev	E

RESOURCE CONSENT

DATE: 11/19/25 FILEPATH: F:\MVEN\HAMILTON\6. PROJECTS\289001 - STATION ROAD\DRAWING\1. ASHBORNE RESIDENTIAL\0200-WATERSUPPLY.DWG



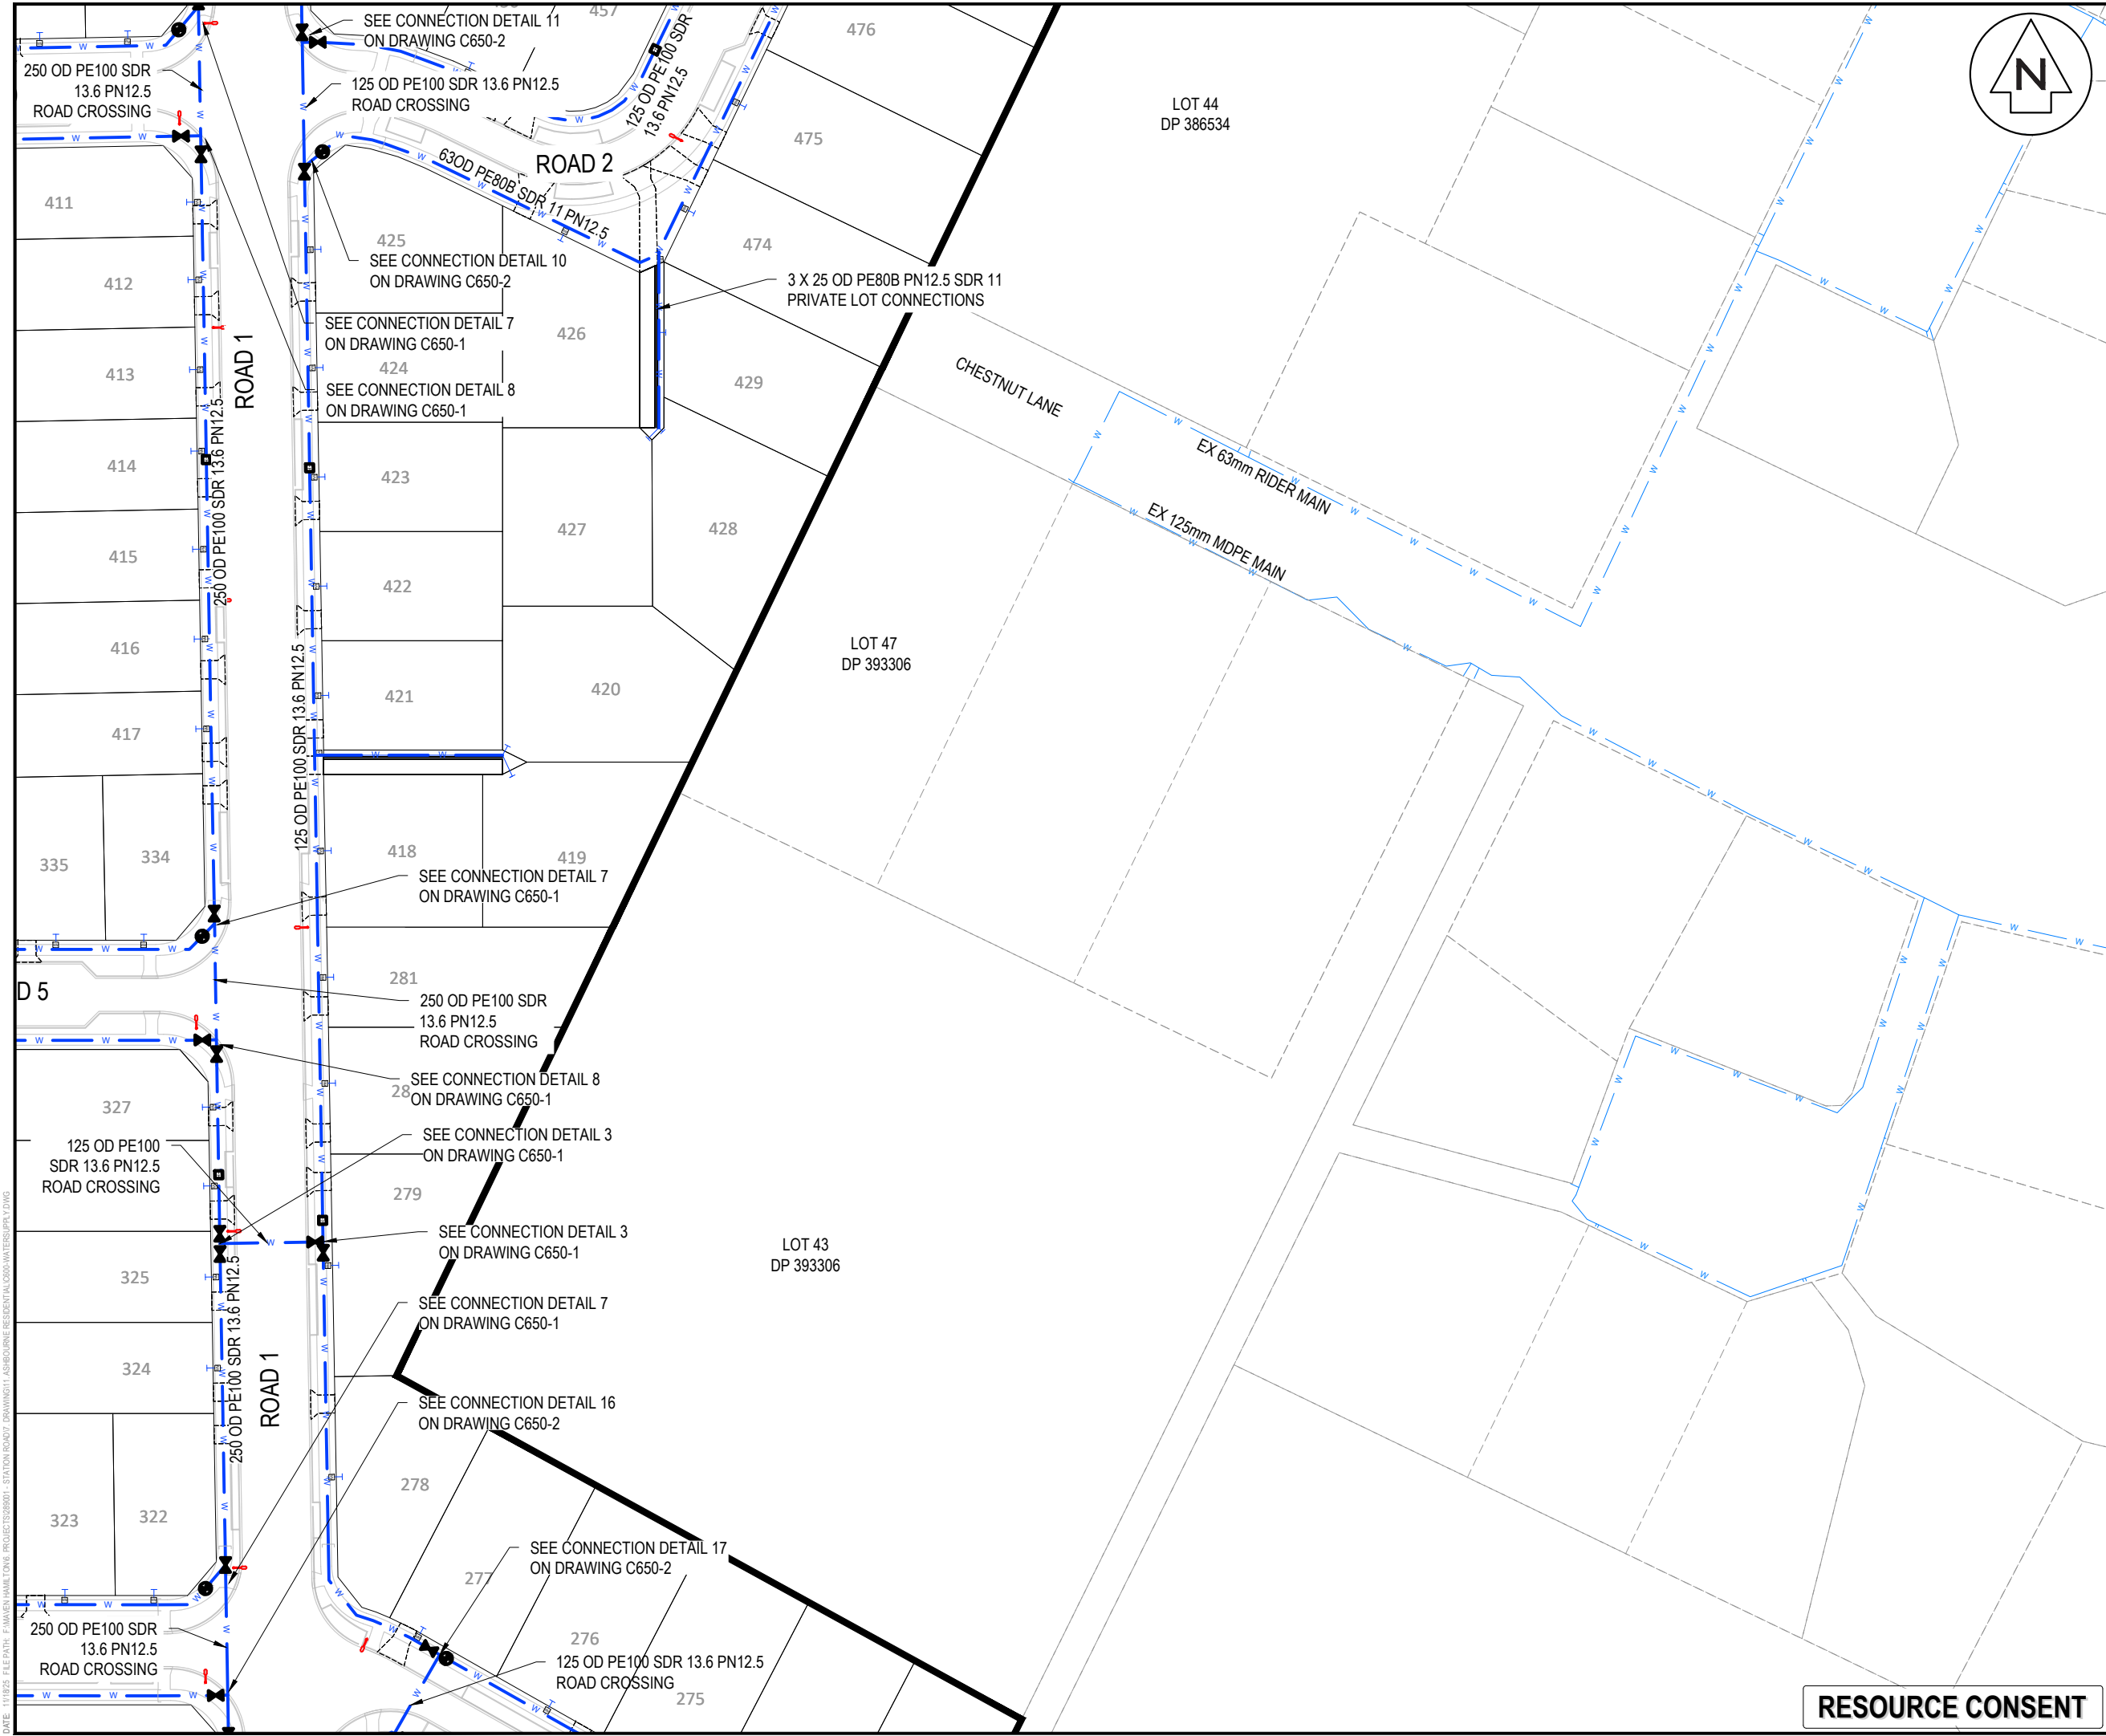

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	EX/PR SLUICE VALVE
	EX/PR PEET VALVE
	PR WATERMAIN
	PR LOT CONNECTION
	PR FLUSHING VALVE
	PR STORMWATER
	PR WASTEWATER
	EX/PR BLANKCAP

D	FAST TRACK APP	MKS	06/2025
C	FAST TRACK APP	MKS	05/2025
B	FAST TRACK APP	TCH	04/2025
A	FAST TRACK APP	TCH	04/2025
Rev	Description	By	Date
		By	Date
Survey	MAVEN		03/2024
Design	TCH		04/2025
Drawn	TCH		04/2025
Checked	DJM		06/2025


**Maven Waikato**  
07 242 0601  
info@maven.co.nz  
www.maven.co.nz  
Level 1 286 Victoria Street, Hamilton  
New Zealand

Project  
**ASHBOURNE  
RESIDENTIAL  
FOR  
MATAMATA  
DEVELOPMENTS LTD**

Title  
**PROPOSED  
WATER SUPPLY PLAN  
SHEET 6 OF 11**

Project no.	289001		
Scale	1:1000 @ A3		
Cad file	C600-WATERSUPPLY.DWG		
Drawing no.	C600-6	Rev	<b>D</b>

**RESOURCE CONSENT**

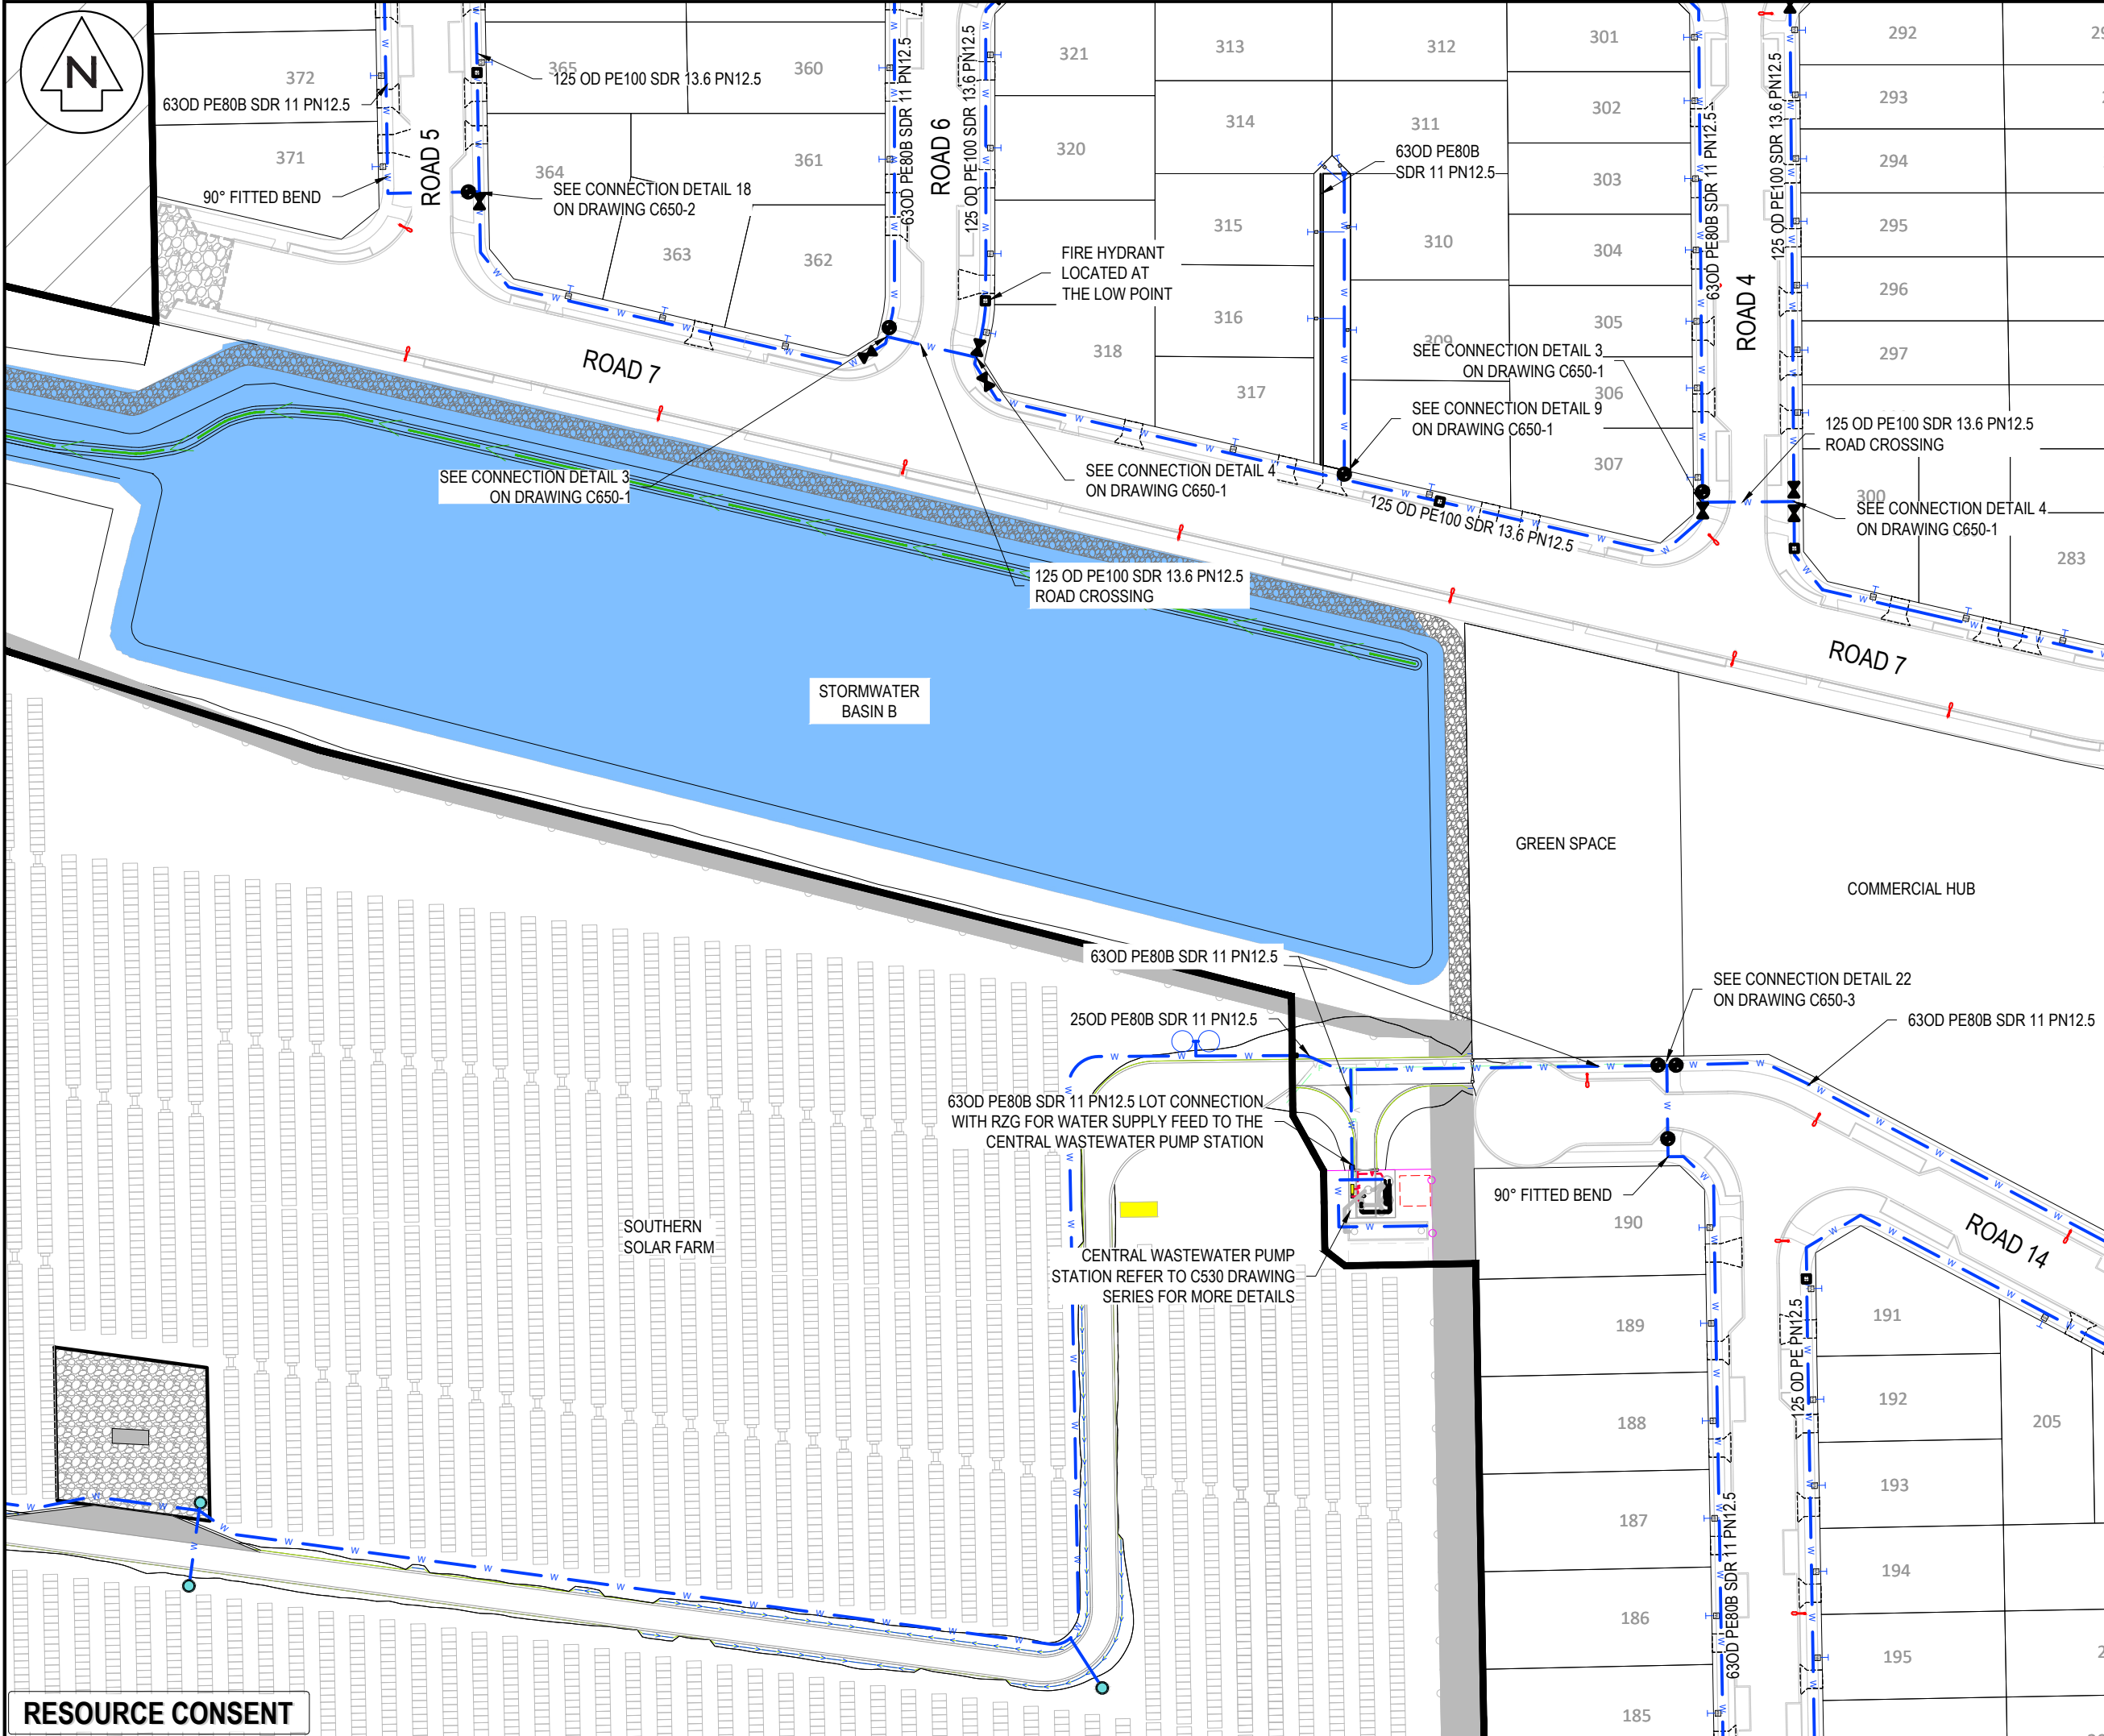

NOTES

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	EX BDY
	EX WATERMAIN
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	EX/PR SLUICE VALVE
	EX/PR PEET VALVE
	PR WATERMAIN
	PR LOT CONNECTION
	PR FLUSHING VALVE
	PR STORMWATER
	PR WASTEWATER
	EX/PR BLANKCAP

D	FAST TRACK APP	MKS	06/2025
C	FAST TRACK APP	MKS	05/2025
B	FAST TRACK APP	TCH	04/2025
A	FAST TRACK APP	TCH	04/2025
Rev	Description	By	Date
Survey	MAVEN		03/2024
Design	TCH		04/2025
Drawn	TCH		04/2025
Checked	DJM		06/2025

**Maven Waikato**  
07 242 0601  
info@maven.co.nz  
www.maven.co.nz  
Level 1 286 Victoria Street, Hamilton  
New Zealand

Project

**ASHBOURNE  
RESIDENTIAL  
FOR  
MATAMATA  
DEVELOPMENTS LTD**

Title


**PROPOSED  
WATER SUPPLY PLAN  
SHEET 7 OF 11**

Project no.	289001		
Scale	1:1000 @ A3		
Cad file	C600-WATERSUPPLY.DWG		
Drawing no.	C600-7	Rev	D

RESOURCE CONSENT

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- NOTES
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	EX/PR SLUICE VALVE
	EX/PR PEET VALVE
	PR WATERMAIN
	PR LOT CONNECTION
	PR FLUSHING VALVE
	PR STORMWATER
	PR WASTEWATER
	EX/PR BLANKCAP

D	FAST TRACK APP	MKS	06/2025
C	FAST TRACK APP	MKS	05/2025
B	FAST TRACK APP	TCH	04/2025
A	FAST TRACK APP	TCH	04/2025
Rev	Description	By	Date
		MAVEN	03/2024
Survey	TCH		04/2025
Design	TCH		04/2025
Drawn	DJM		06/2025
Checked			

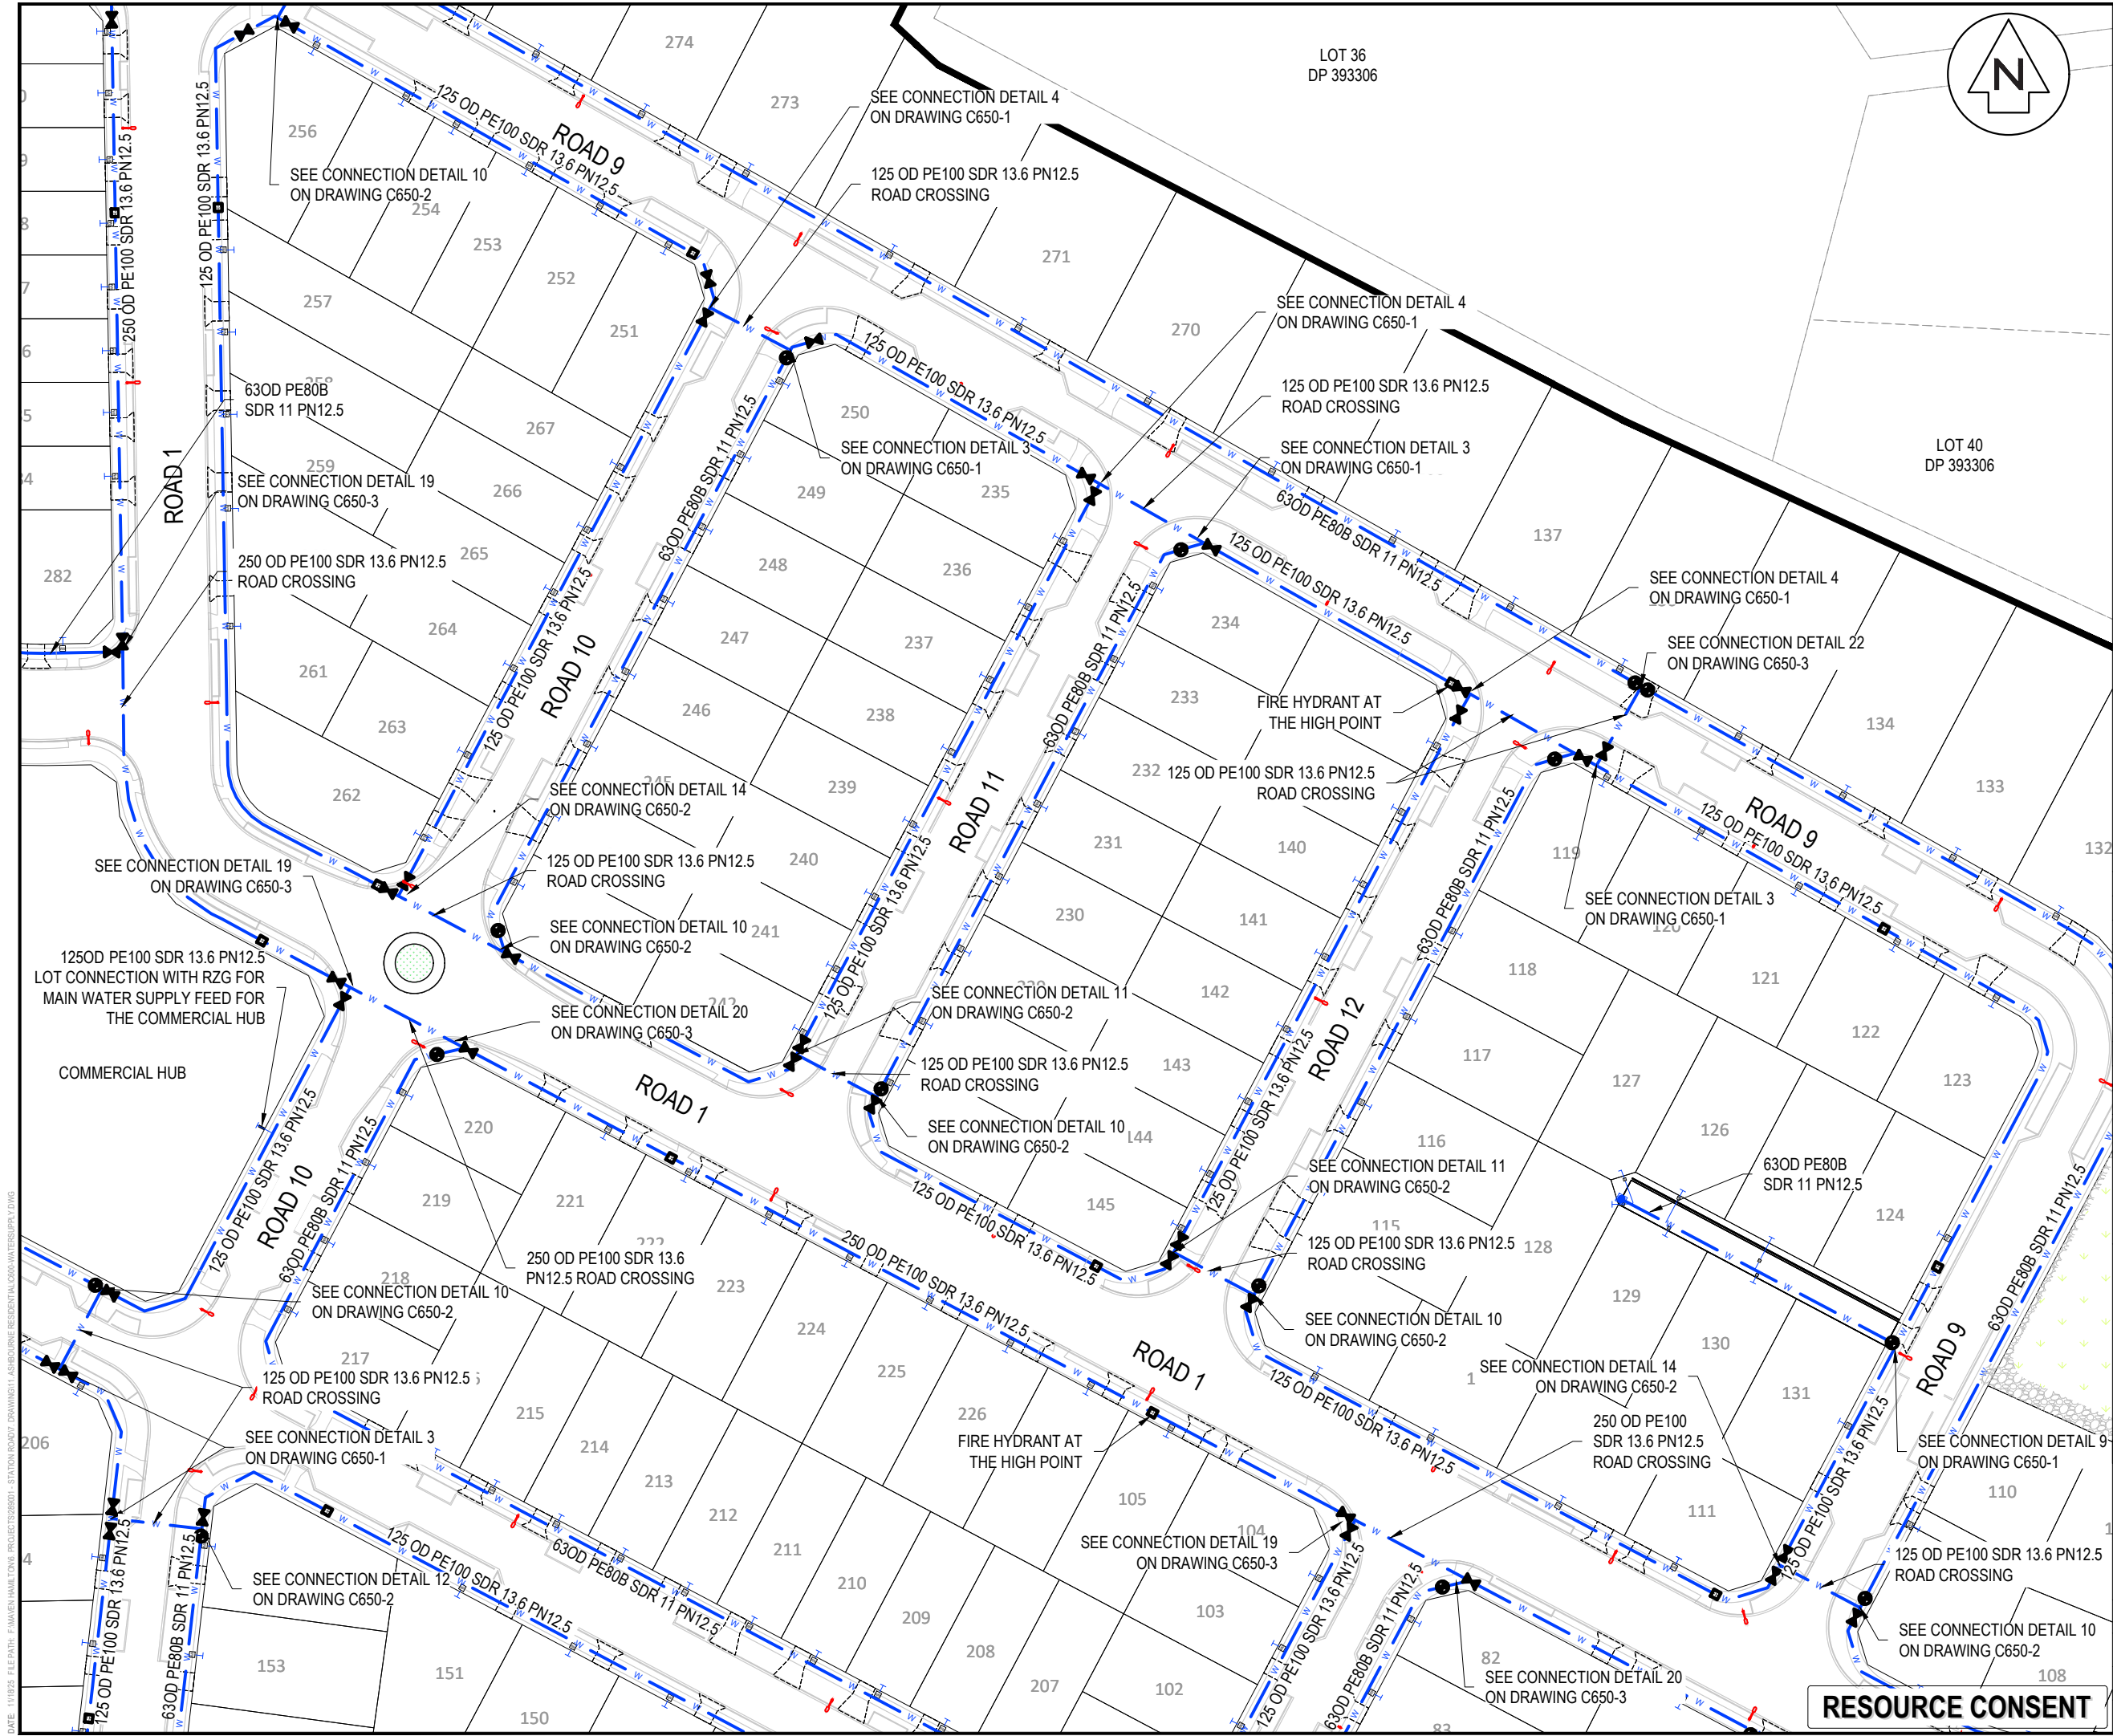**Maven Waikato**  
07 242 0601  
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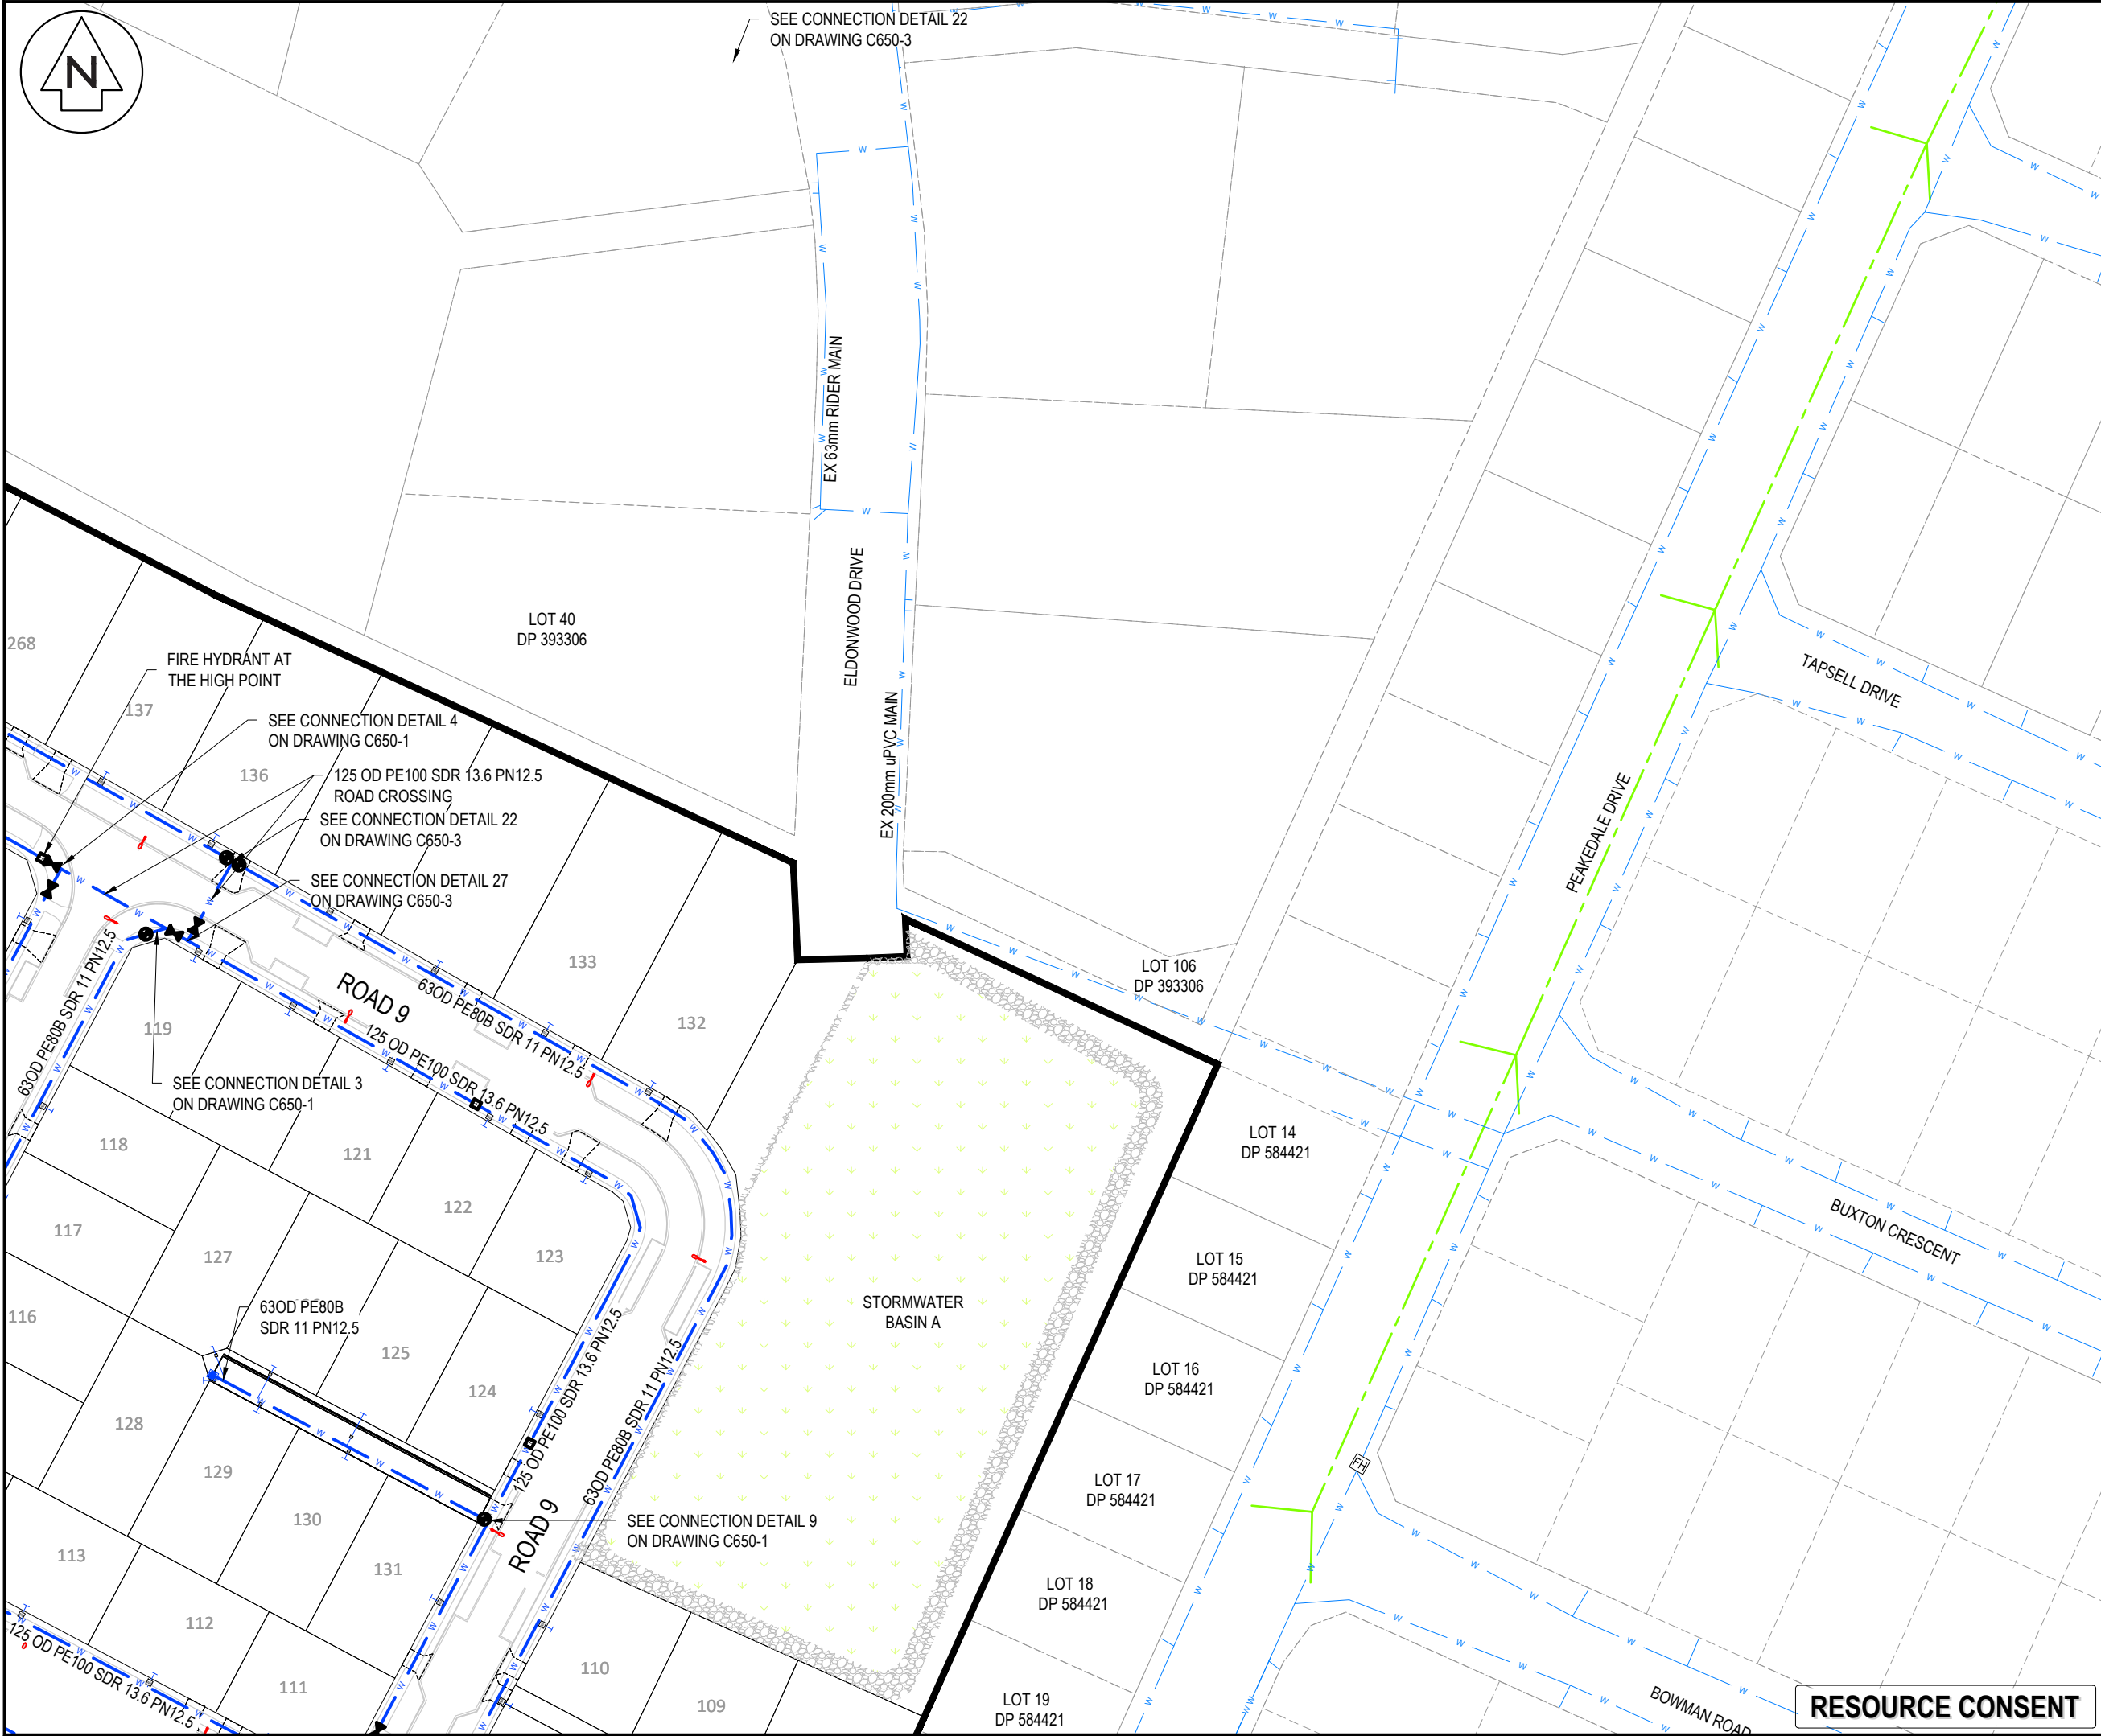
Project  
**ASHBOURNE  
RESIDENTIAL  
FOR  
MATAMATA  
DEVELOPMENTS LTD**

Title  
**PROPOSED  
WATER SUPPLY PLAN  
SHEET 8 OF 11**

Project no.	289001
Scale	1:1000 @ A3
Cad file	C600-WATERSUPPLY.DWG
Drawing no.	C600-8
Rev	D

**RESOURCE CONSENT**





NOTES

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E	FAST TRACK APP	GNT	11/2025
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B	FAST TRACK APP	TCH	04/2025
Rev	Description	By	Date
		By	Date
Survey	MAVEN		03/2024
Design	TCH		04/2025
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Project

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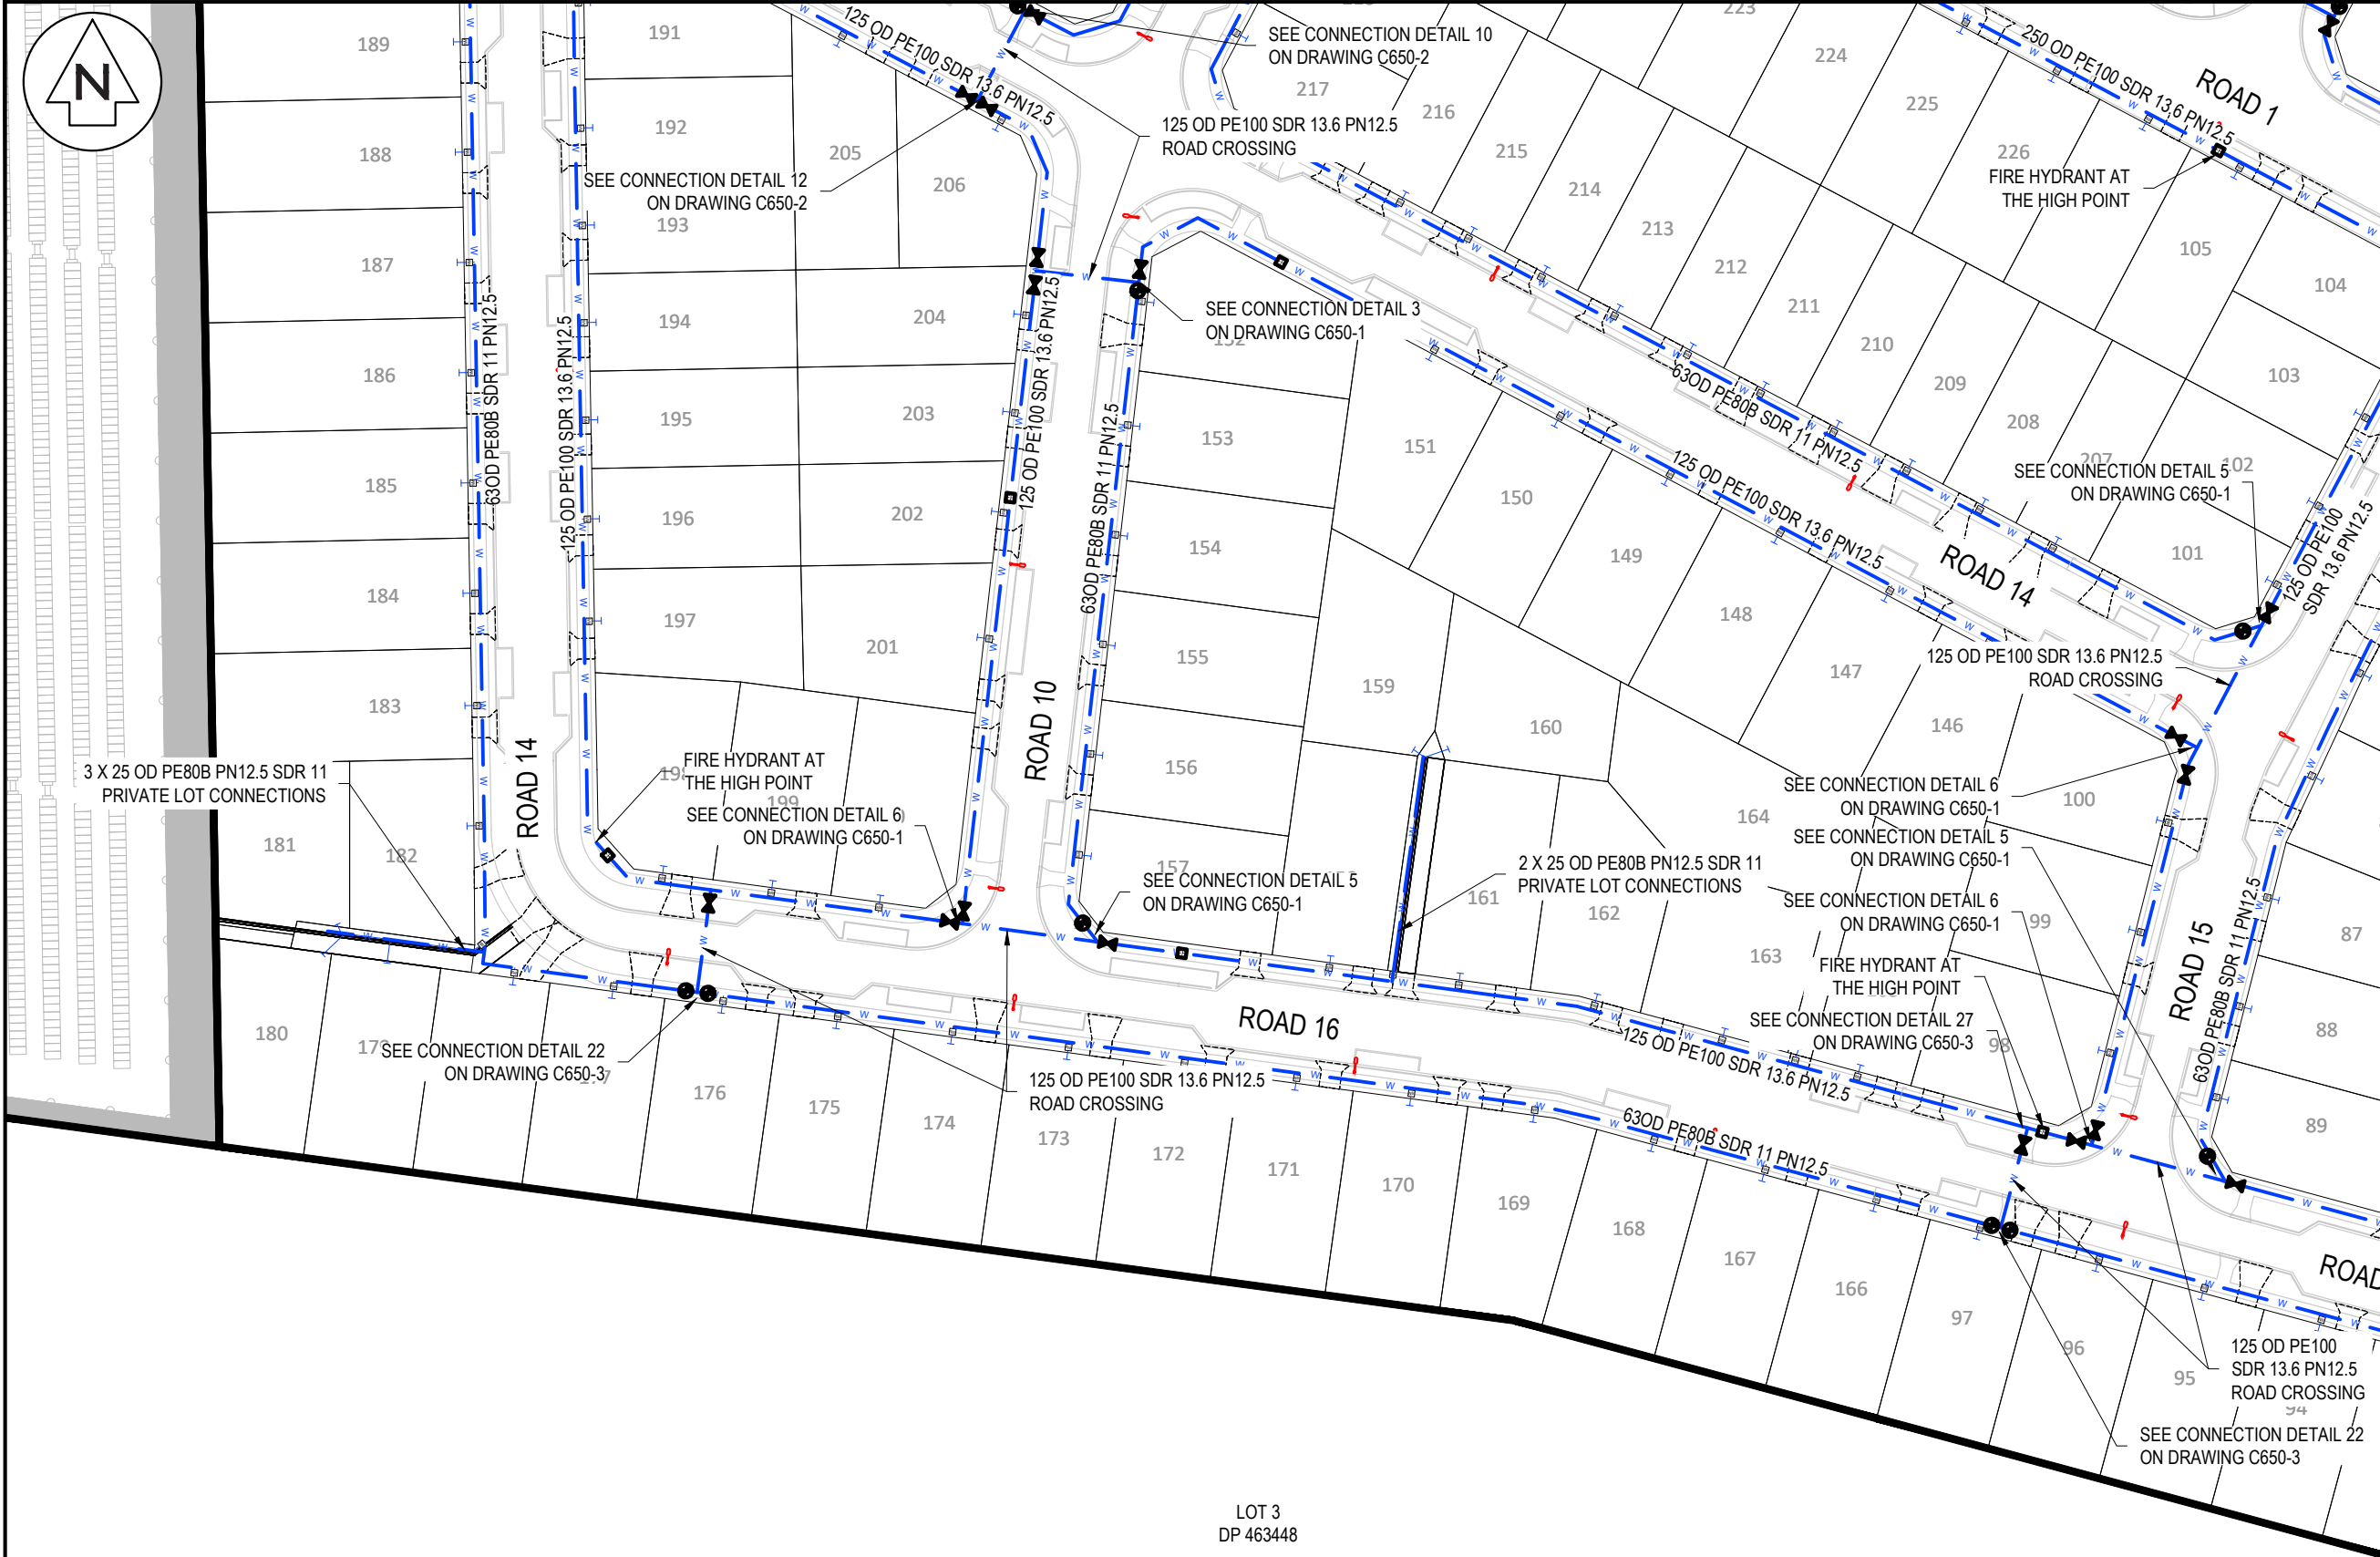
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**PROPOSED  
WATER SUPPLY PLAN  
SHEET 9 OF 11**

Project no.	289001		
Scale	1:1000 @ A3		
Cad file	C600-WATERSUPPLY.DWG		
Drawing no.	C600-9	Rev	E

RESOURCE CONSENT

DATE: 11/19/25 FILEPATH: F:\Maven\Hamilton\6. PROJECTS\289001 - STATION ROAD\DRAWING\11. ASHBORNE RESIDENTIAL\0200-WATERSUPPLY.DWG



NOTES

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Legend

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	EX BDY
	EX WATERMAIN
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	EX/PR SLUICE VALVE
	EX/PR PEET VALVE
	PR WATERMAIN
	PR LOT CONNECTION
	PR FLUSHING VALVE
	PR STORMWATER
	PR WASTEWATER
	EX/PR BLANKCAP

D	FAST TRACK APP	MKS	06/2025
C	FAST TRACK APP	MKS	05/2025
B	FAST TRACK APP	TCH	04/2025
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Rev	Description	By	Date
		By	Date
Survey	MAVEN		03/2024
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Project


**ASHBOURNE  
RESIDENTIAL  
FOR  
MATAMATA  
DEVELOPMENTS LTD**

Title

**PROPOSED  
WATER SUPPLY PLAN  
SHEET 10 OF 11**

Project no.	289001		
Scale	1:1000 @ A3		
Cad file	C600-WATERSUPPLY.DWG		
Drawing no.	C600-10	Rev	D



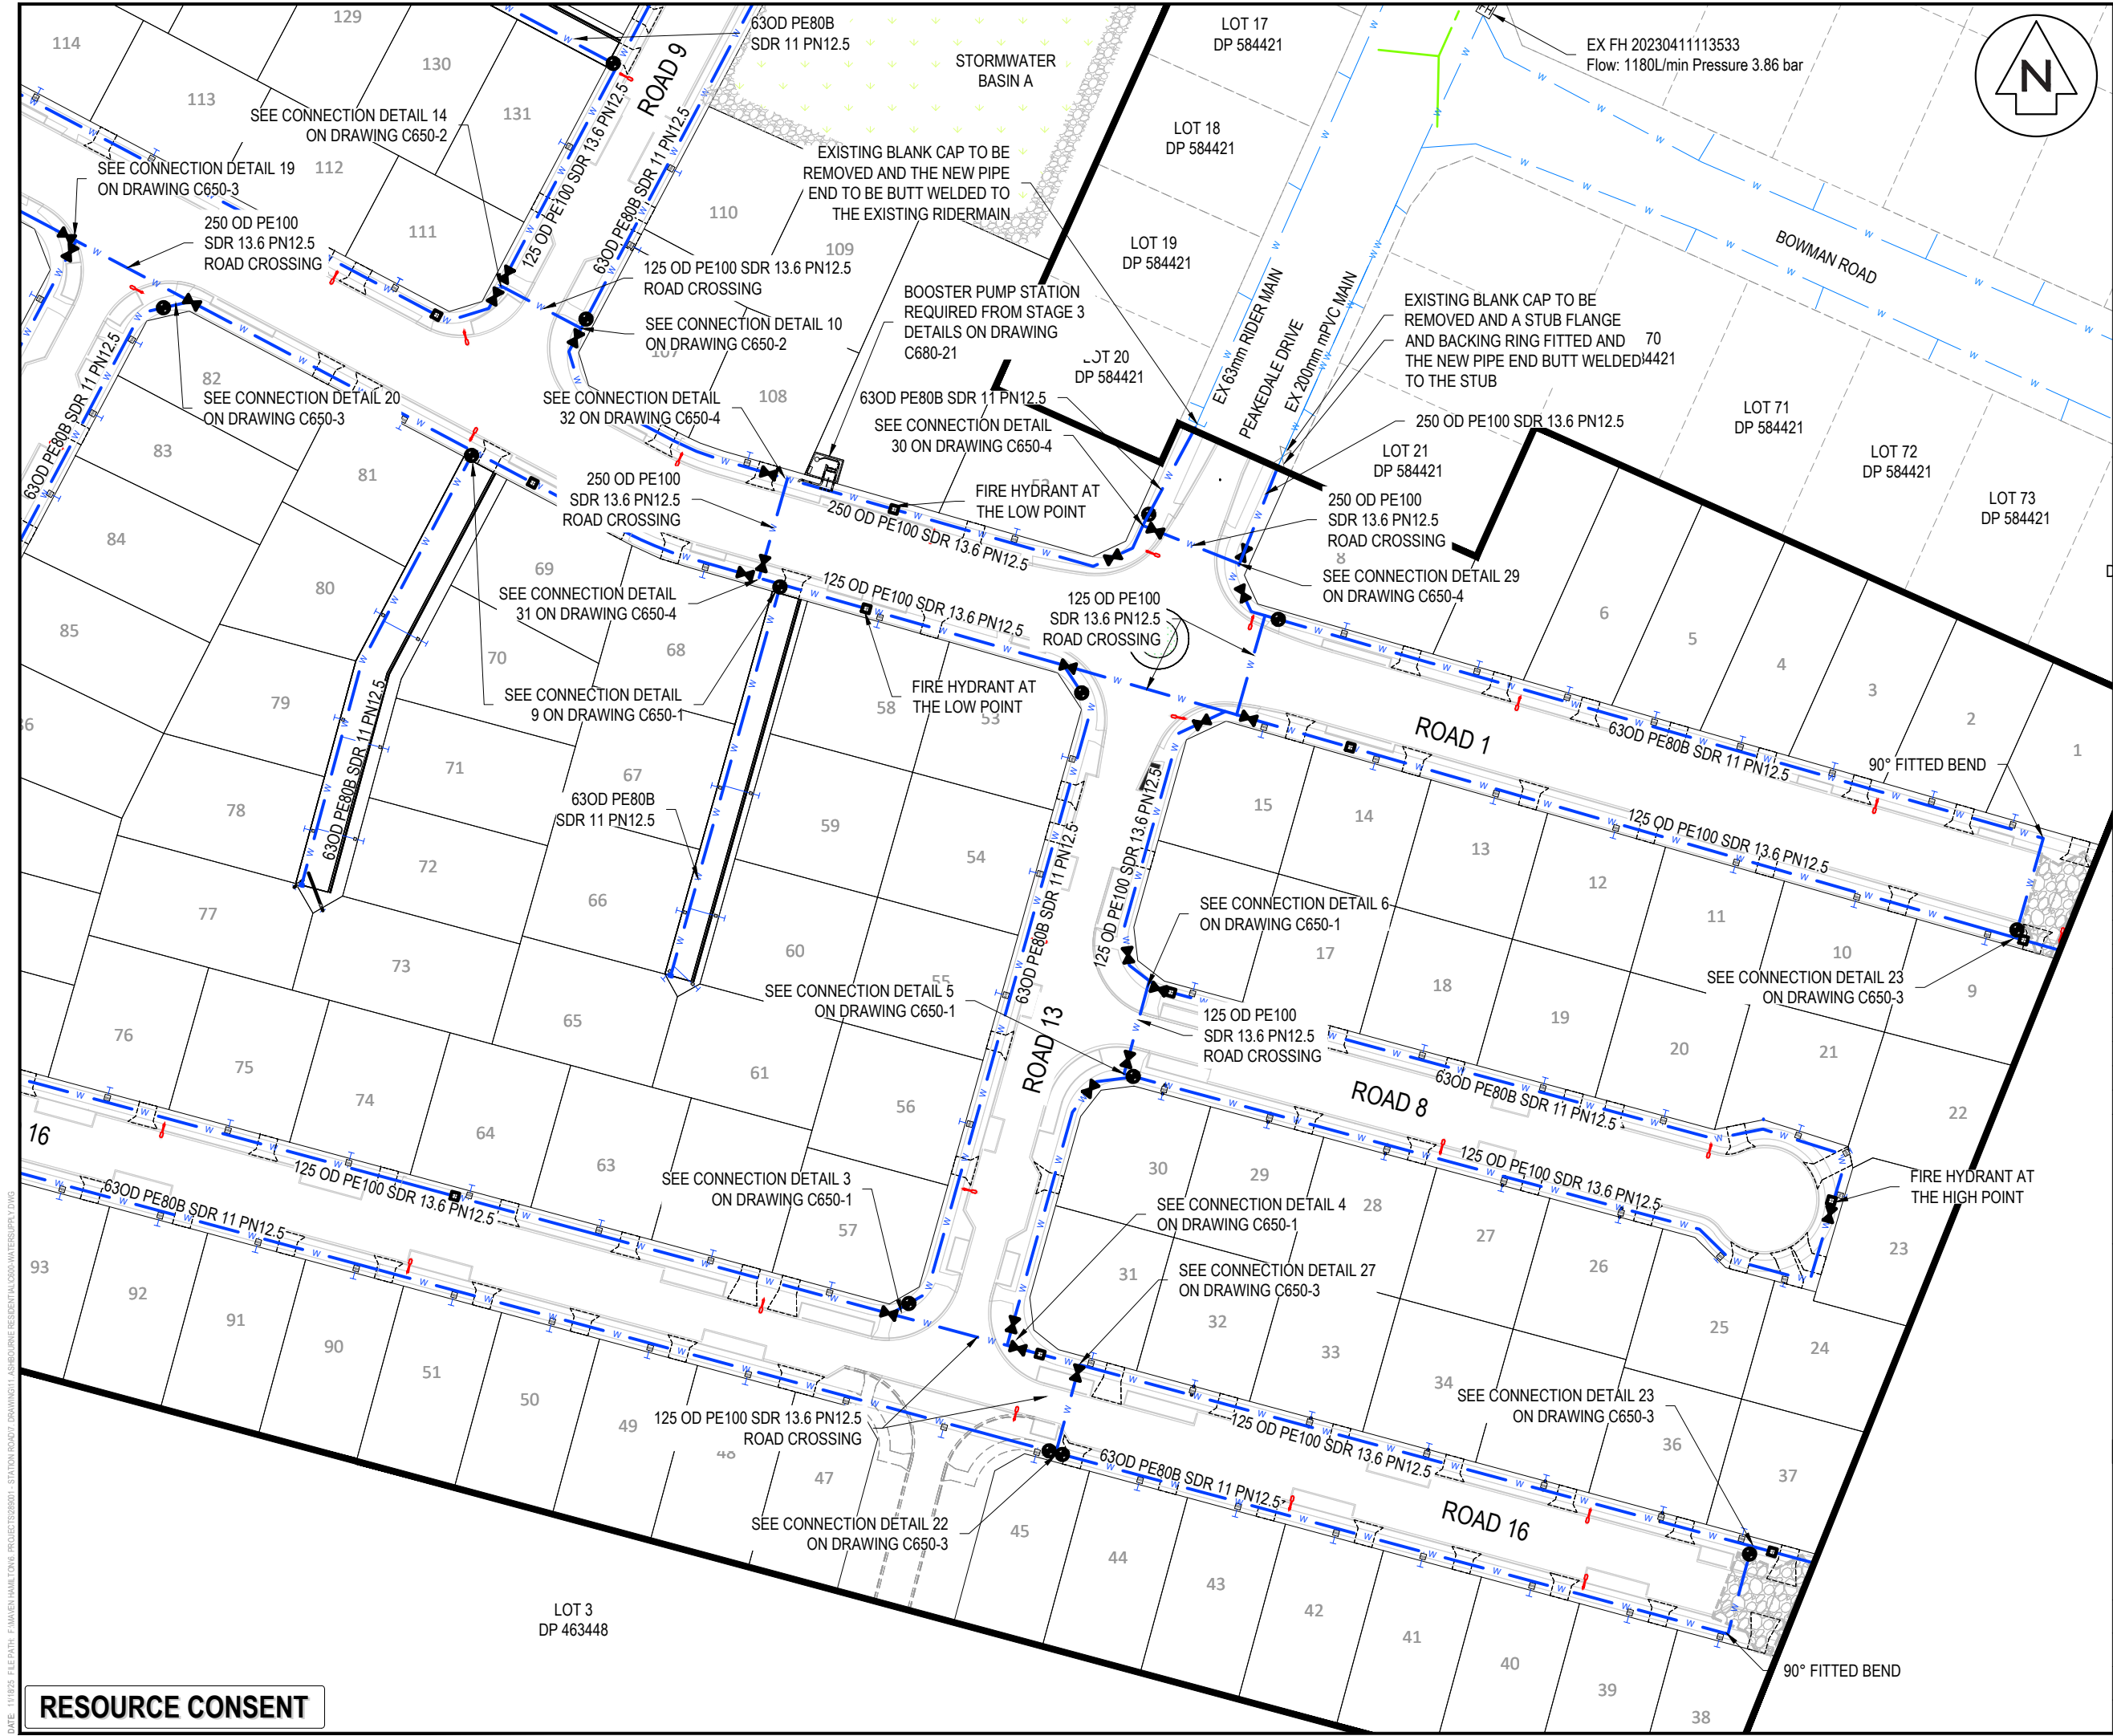

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  8. THRUST BLOCKS HAVE NOT BEEN INDICATED ON DETAILS, ALL THRUST BLOCKS TO BE INSTALLED AS PER REGIONAL INFRASTRUCTURE TECHNICAL SPECIFICATIONS (RITS). PLEASE REFER DETAILS ON SHEET C680-20.

Legend

	PR BOUNDARY
	EX BDY
	EX WATERMAIN
	EX/PR HYDRANT
	EX/PR METER
	EX/PR SLUICE VALVE
	EX/PR PEET VALVE
	PR WATERMAIN
	PR LOT CONNECTION
	PR FLUSHING VALVE
	PR STORMWATER
	PR WASTEWATER
	EX/PR BLANKCAP

D	FAST TRACK APP	MKS	06/2025
C	FAST TRACK APP	MKS	05/2025
B	FAST TRACK APP	TCH	04/2025
A	FAST TRACK APP	TCH	04/2025
Rev	Description	By	Date
		By	Date
Survey	MAVEN		03/2024
Design	TCH		04/2025
Drawn	TCH		04/2025
Checked	DJM		06/2025




Project  
**ASHBOURNE  
RESIDENTIAL  
FOR  
MATAMATA  
DEVELOPMENTS LTD**

Title  
**PROPOSED  
WATER SUPPLY PLAN  
SHEET 11 OF 11**

Project no.	289001
Scale	1:1000 @ A3
Cad file	C600-WATERSUPPLY.DWG
Drawing no.	C600-11
Rev	D


RESOURCE CONSENT



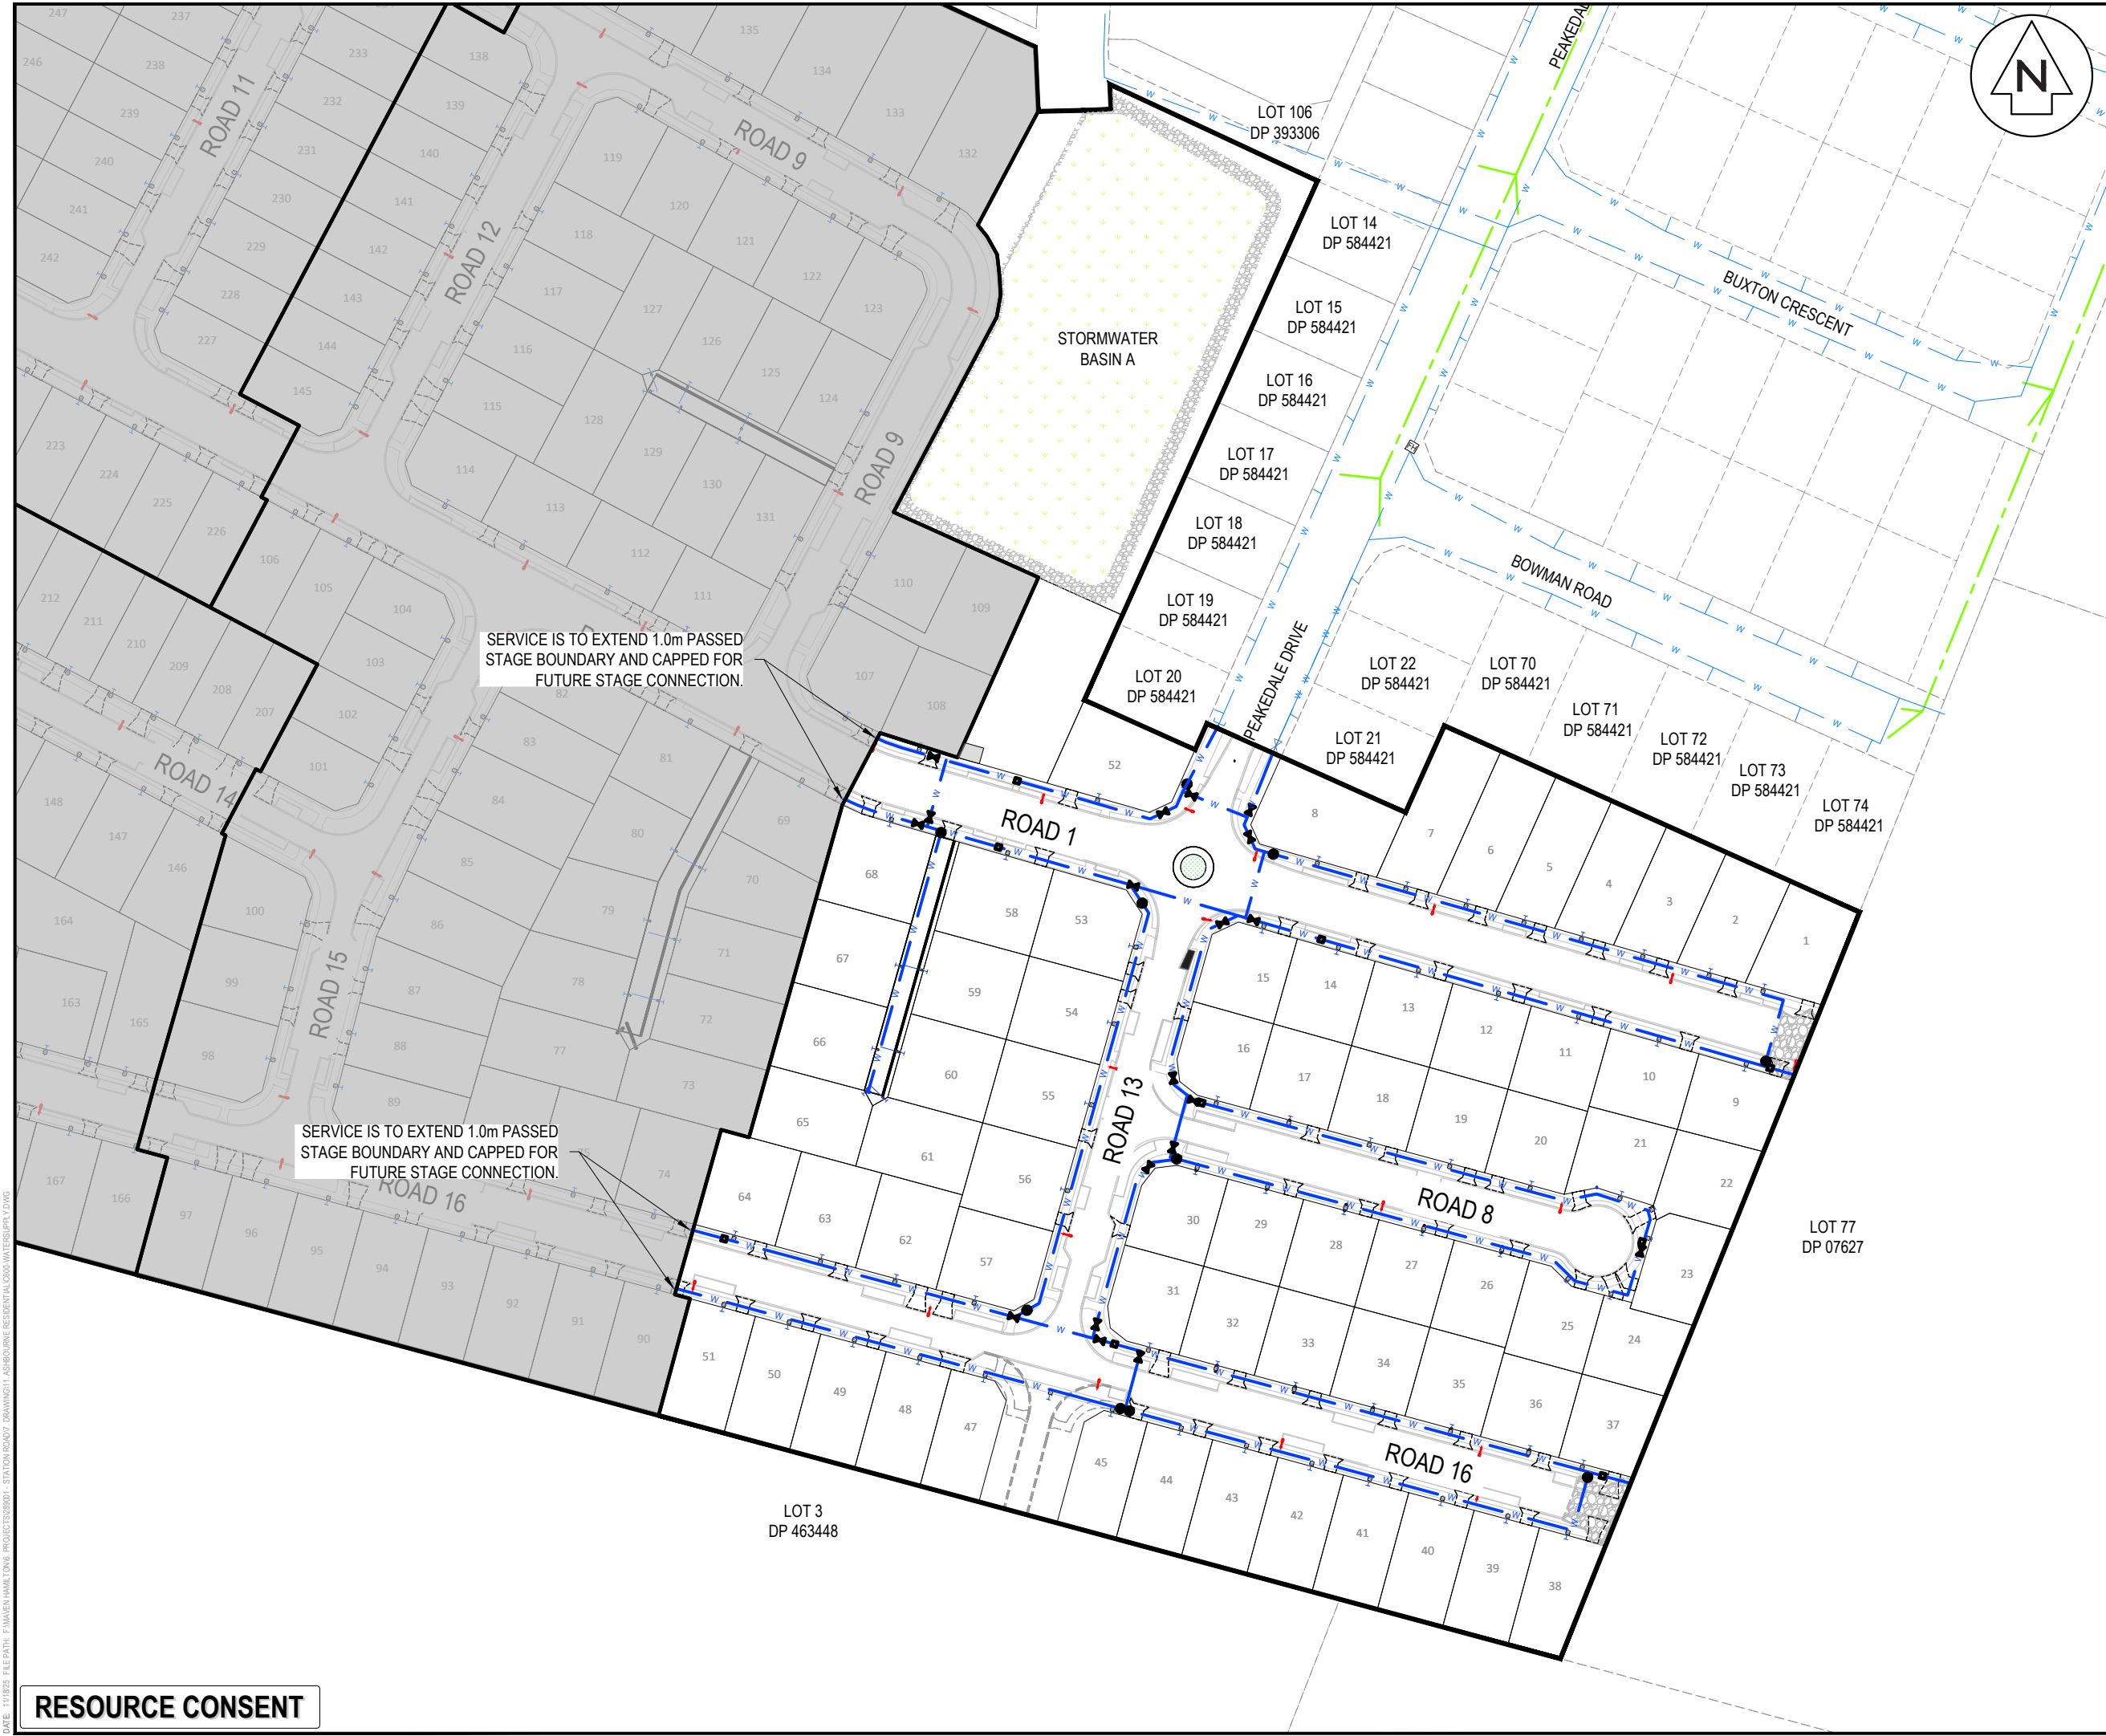

RESOURCE CONSENT



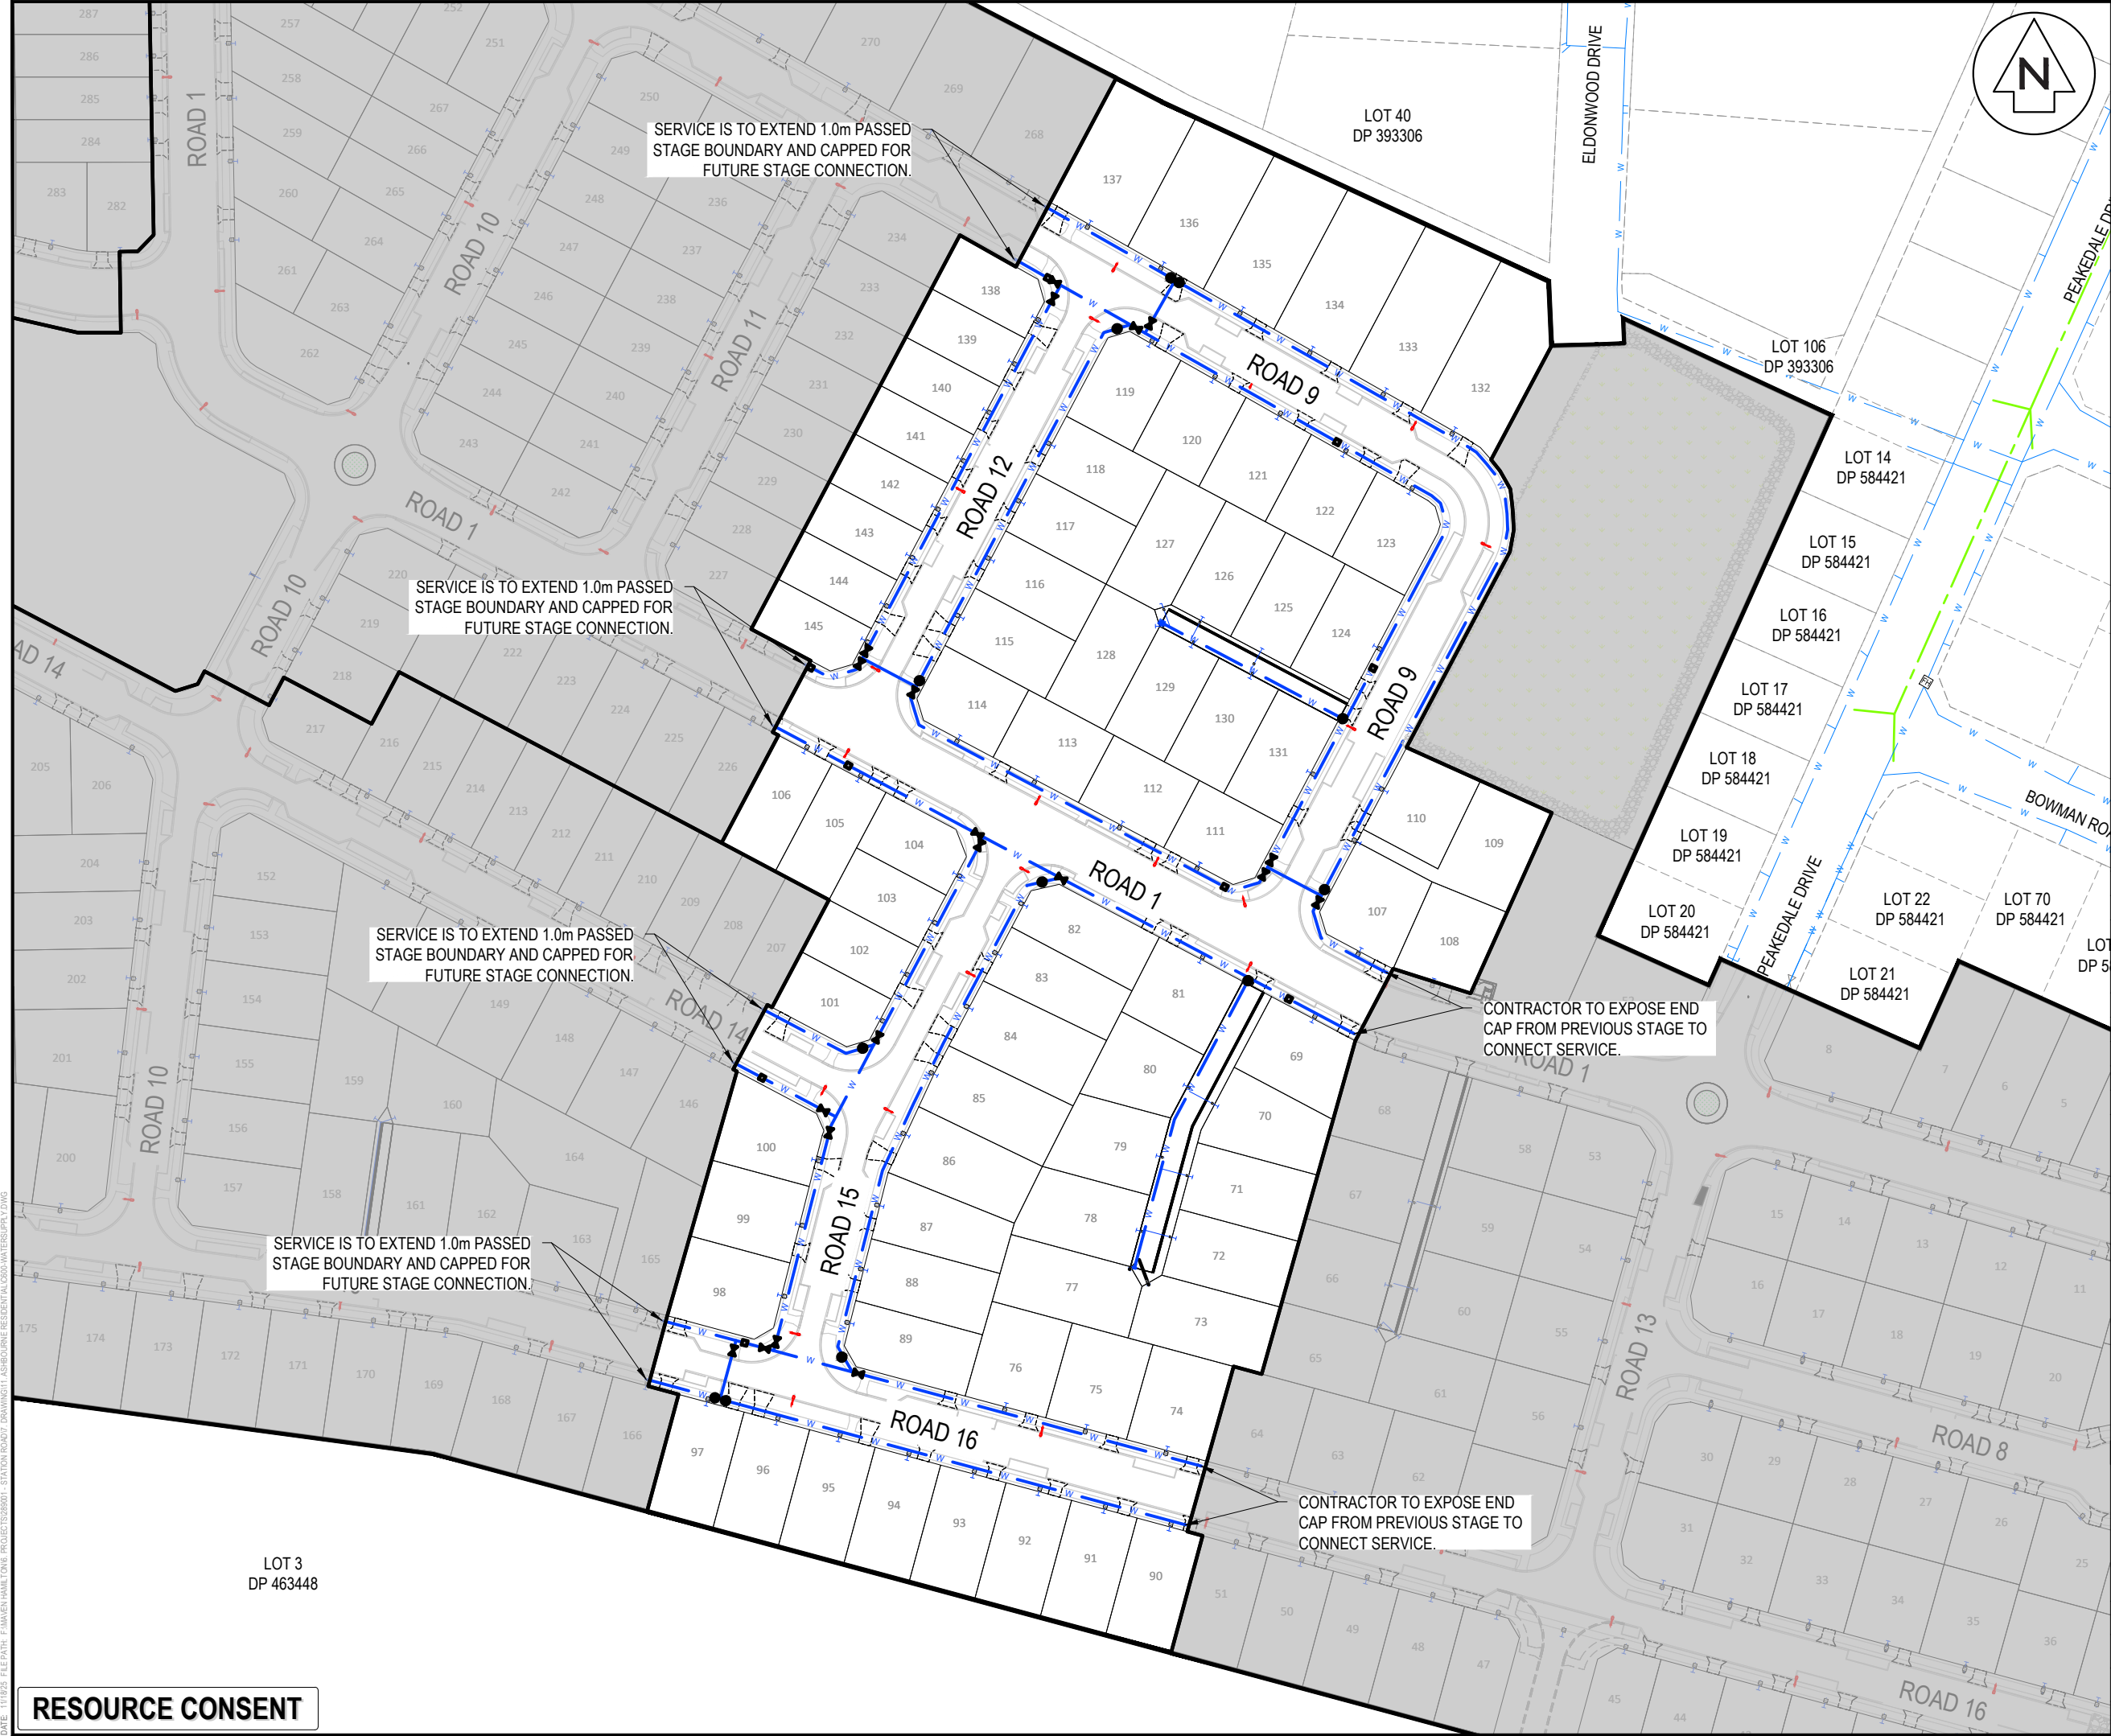

NOTES

1. ALL WORKS TO BE IN ACCORDANCE WITH REGIONAL INFRASTRUCTURE TECHNICAL SPECIFICATIONS (RITS).
2. CO-ORDINATES IN TERMS OF NZ GEODETIC DATUM MOUNT EDEN 2000.
3. LEVELS IN TERMS OF THE NEW ZEALAND VERTICAL DATUM 2016.
4. BENCHMARK: IT 1 DPS 29877 RL:65.51. SOURCED FROM THE LINZ GEODETIC DATABASE.
5. ALL WATER LINES TO BE BLANK CAPPED BEYOND STAGING BOUNDARY. CONTRACTOR TO MAKE SURE BLANK CAP IS OUTSIDE OF FOOTPATH EXTENTS AND ACCESSIBLE FOR FUTURE EXTENSIONS.
6. ALL TOBIES WITHIN RIGHT OF WAYS (ROW) TO BE PLACED IN HEAVY DUTY TRAFFICABLE MANIFOLD BOX.
7. EXISTING SERVICES SHOWN ARE FROM B4UDIG AND ARE INDICATIVE ONLY. CONTRACTOR TO CONFIRM THEIR LOCATION PRIOR TO CONSTRUCTION.
8. THRUST BLOCKS HAVE NOT BEEN INDICATED ON DETAILS, ALL THRUST BLOCKS TO BE INSTALLED AS PER REGIONAL INFRASTRUCTURE TECHNICAL SPECIFICATIONS (RITS). PLEASE REFER DETAILS ON SHEET C680-20.

Legend

	PR BOUNDARY
	EX BDY
	PR SITE BOUNDARY
	PR STAGE BOUNDARY
	EX WATERMAIN
	EX/PR HYDRANT
	EX/PR METER
	EX/PR SLUICE VALVE
	EX/PR PEET VALVE
	PR WATERMAIN
	PR LOT CONNECTION
	PR FLUSHING VALVE
	PR STORMWATER
	PR WASTEWATER
	EX/PR BLANKCAP

C	FAST TRACK APP	GNT	11/2025
B	FAST TRACK APP	MKS	06/2025
A	FAST TRACK APP	NDL	05/2025
Rev	Description	By	Date
Survey	MAVEN		03/2024
Design	MES		05/2025
Drawn	NDL		05/2025
Checked	DJM		06/2025

**Maven Waikato**  
07 242 0601  
info@maven.co.nz  
www.maven.co.nz  
Level 1 286 Victoria Street, Hamilton  
New Zealand

Project


**ASHBOURNE  
RESIDENTIAL  
FOR  
MATAMATA  
DEVELOPMENTS LTD**

Title

**PROPOSED  
WATER SUPPLY  
PLAN STAGE 2**

Project no.	289001		
Scale	1:1500 @ A3		
Cad file	C600-WATERSUPPLY.DWG		
Drawing no.	C600-13	Rev	<b>C</b>



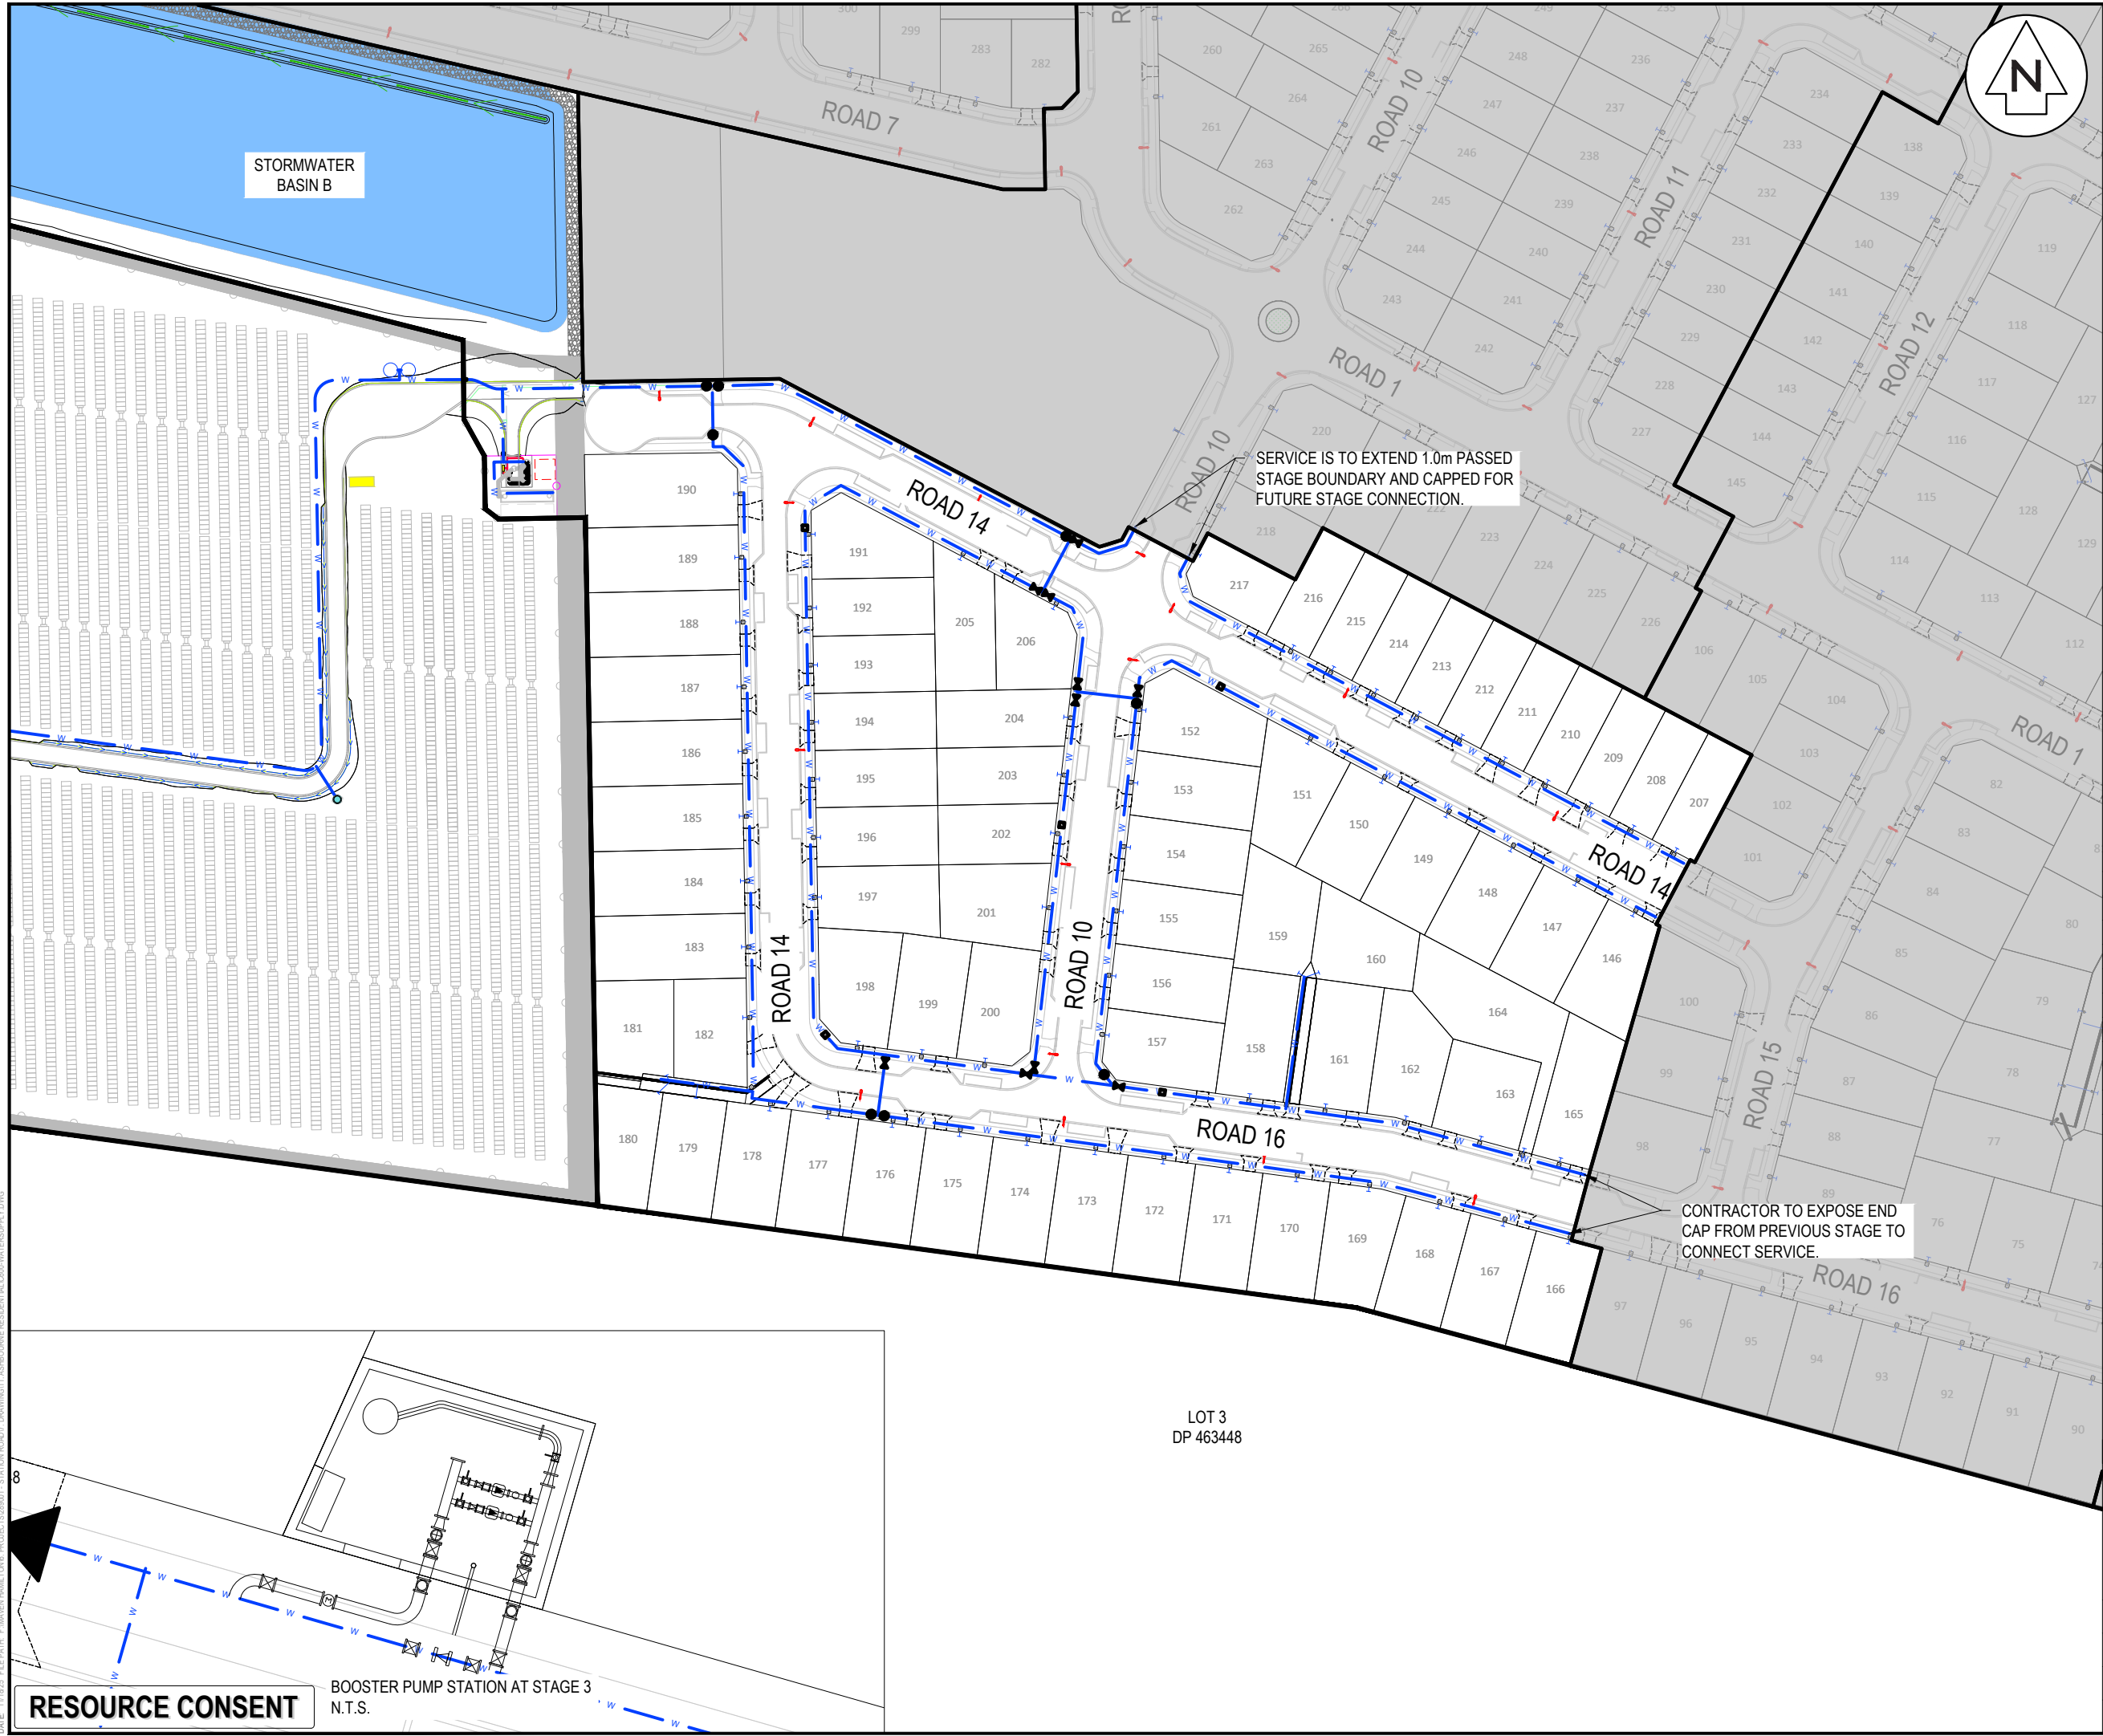

- NOTES
1. ALL WORKS TO BE IN ACCORDANCE WITH REGIONAL INFRASTRUCTURE TECHNICAL SPECIFICATIONS (RITS).
  2. CO-ORDINATES IN TERMS OF NZ GEODETIC DATUM MOUNT EDEN 2000.
  3. LEVELS IN TERMS OF THE NEW ZEALAND VERTICAL DATUM 2016.
  4. BENCHMARK: IT I DPS 29877 RL:65.51. SOURCED FROM THE LINZ GEODETIC DATABASE.
  5. ALL WATER LINES TO BE BLANK CAPPED BEYOND STAGING BOUNDARY. CONTRACTOR TO MAKE SURE BLANK CAP IS OUTSIDE OF FOOTPATH EXTENTS AND ACCESSIBLE FOR FUTURE EXTENSIONS.
  6. ALL TOBIES WITHIN RIGHT OF WAYS (ROW) TO BE PLACED IN HEAVY DUTY TRAFFICABLE MANIFOLD BOX.
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  8. THRUST BLOCKS HAVE NOT BEEN INDICATED ON DETAILS, ALL THRUST BLOCKS TO BE INSTALLED AS PER REGIONAL INFRASTRUCTURE TECHNICAL SPECIFICATIONS (RITS). PLEASE REFER DETAILS ON SHEET C680-20.

Legend

	PR BOUNDARY
	EX BDY
	PR SITE BOUNDARY
	PR STAGE BOUNDARY
	EX WATERMAIN
	EX/PR HYDRANT
	EX/PR METER
	EX/PR SLUICE VALVE
	EX/PR PEET VALVE
	PR WATERMAIN
	PR LOT CONNECTION
	PR FLUSHING VALVE
	PR STORMWATER
	PR WASTEWATER
	EX/PR BLANKCAP

C	FAST TRACK APP	MKS	06/2025
B	FAST TRACK APP	MKS	06/2025
A	FAST TRACK APP	NDL	05/2025
Rev	Description	By	Date
		By	Date
Survey	MAVEN		03/2024
Design	MES		05/2025
Drawn	NDL		05/2025
Checked	DJM		06/2025

**Maven Waikato**  
07 242 0601  
info@maven.co.nz  
www.maven.co.nz  
Level 1 286 Victoria Street, Hamilton  
New Zealand

Project  
**ASHBOURNE  
RESIDENTIAL  
FOR  
MATAMATA  
DEVELOPMENTS LTD**

Title  
**PROPOSED  
WATER SUPPLY  
PLAN STAGE 3**


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Scale	1:1500 @ A3		
Cad file	C600-WATERSUPPLY.DWG		
Drawing no.	C600-14	Rev	C

RESOURCE CONSENT

BOOSTER PUMP STATION AT STAGE 3  
N.T.S.

DATE: 11/10/25 FILE PATH: F:\MVEN\HAMILTON\6 PROJECTS\289001 - STATION ROAD\7 DRAWING\11 ASHBORNE RESIDENTIAL\0600-WATERSUPPLY.DWG



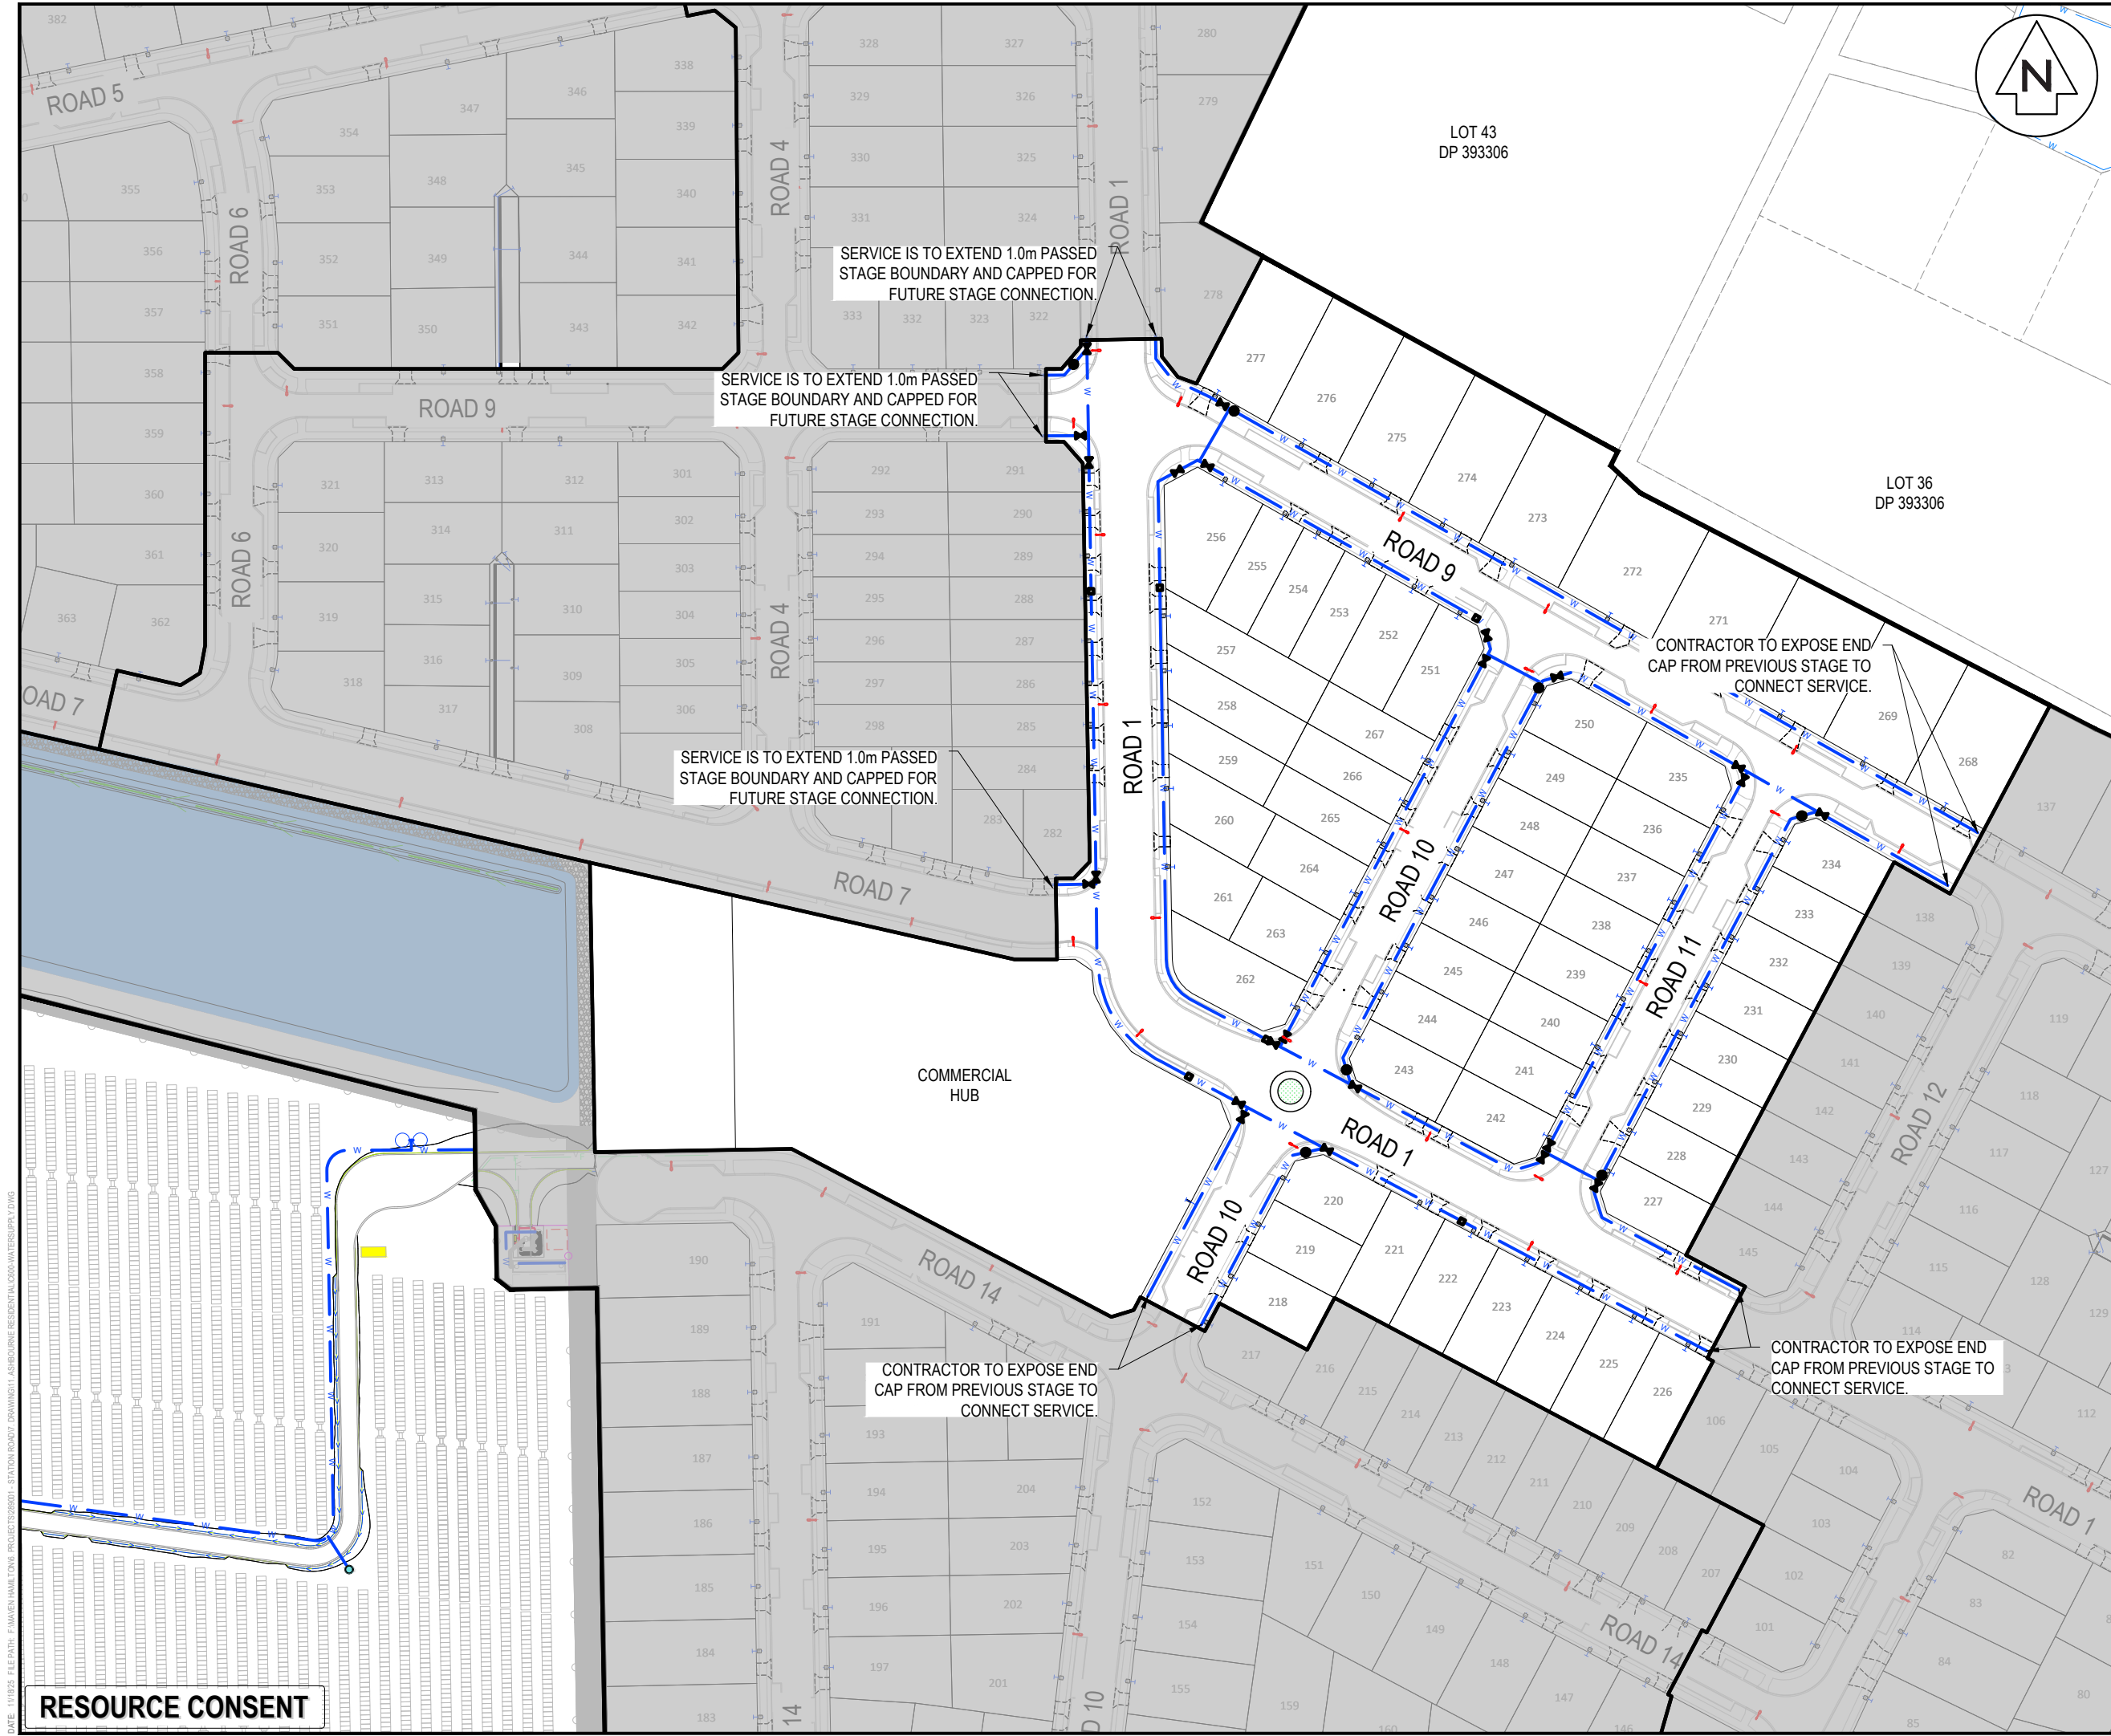

- NOTES
1. ALL WORKS TO BE IN ACCORDANCE WITH REGIONAL INFRASTRUCTURE TECHNICAL SPECIFICATIONS (RITS).
  2. CO-ORDINATES IN TERMS OF NZ GEODETIC DATUM MOUNT EDEN 2000.
  3. LEVELS IN TERMS OF THE NEW ZEALAND VERTICAL DATUM 2016.
  4. BENCHMARK: IT I DPS 29877 RL:65.51. SOURCED FROM THE LINZ GEODETIC DATABASE.
  5. ALL WATER LINES TO BE BLANK CAPPED BEYOND STAGING BOUNDARY. CONTRACTOR TO MAKE SURE BLANK CAP IS OUTSIDE OF FOOTPATH EXTENTS AND ACCESSIBLE FOR FUTURE EXTENSIONS.
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  8. THRUST BLOCKS HAVE NOT BEEN INDICATED ON DETAILS, ALL THRUST BLOCKS TO BE INSTALLED AS PER REGIONAL INFRASTRUCTURE TECHNICAL SPECIFICATIONS (RITS). PLEASE REFER DETAILS ON SHEET C680-20.

Legend

	PR BOUNDARY
	EX BDY
	PR SITE BOUNDARY
	PR STAGE BOUNDARY
	EX WATERMAIN
	EX/PR HYDRANT
	EX/PR METER
	EX/PR SLUICE VALVE
	EX/PR PEET VALVE
	PR WATERMAIN
	PR LOT CONNECTION
	PR FLUSHING VALVE
	PR STORMWATER
	PR WASTEWATER
	EX/PR BLANKCAP

B	FAST TRACK APP	MKS	06/2025
A	FAST TRACK APP	NDL	05/2025
Rev	Description	By	Date
		By	Date
Survey	MAVEN		03/2024
Design	MES		05/2025
Drawn	NDL		05/2025
Checked	DJM		06/2025

**Maven Waikato**  
07 242 0601  
info@maven.co.nz  
www.maven.co.nz  
Level 1 286 Victoria Street, Hamilton  
New Zealand


Project  
**ASHBOURNE  
RESIDENTIAL  
FOR  
MATAMATA  
DEVELOPMENTS LTD**

Title  
**PROPOSED  
WATER SUPPLY  
PLAN STAGE 4**

Project no.	289001		
Scale	1:1500 @ A3		
Cad file	C600-WATERSUPPLY.DWG		
Drawing no.	C600-15	Rev	<b>B</b>

RESOURCE CONSENT

DATE: 11/19/25 FILE PATH: F:\Maven\Hamilton\6. PROJECTS\289001 - STATION ROAD\7. DRAWING\1. ASHBORNE RESIDENTIAL\0200-WATERSUPPLY.DWG

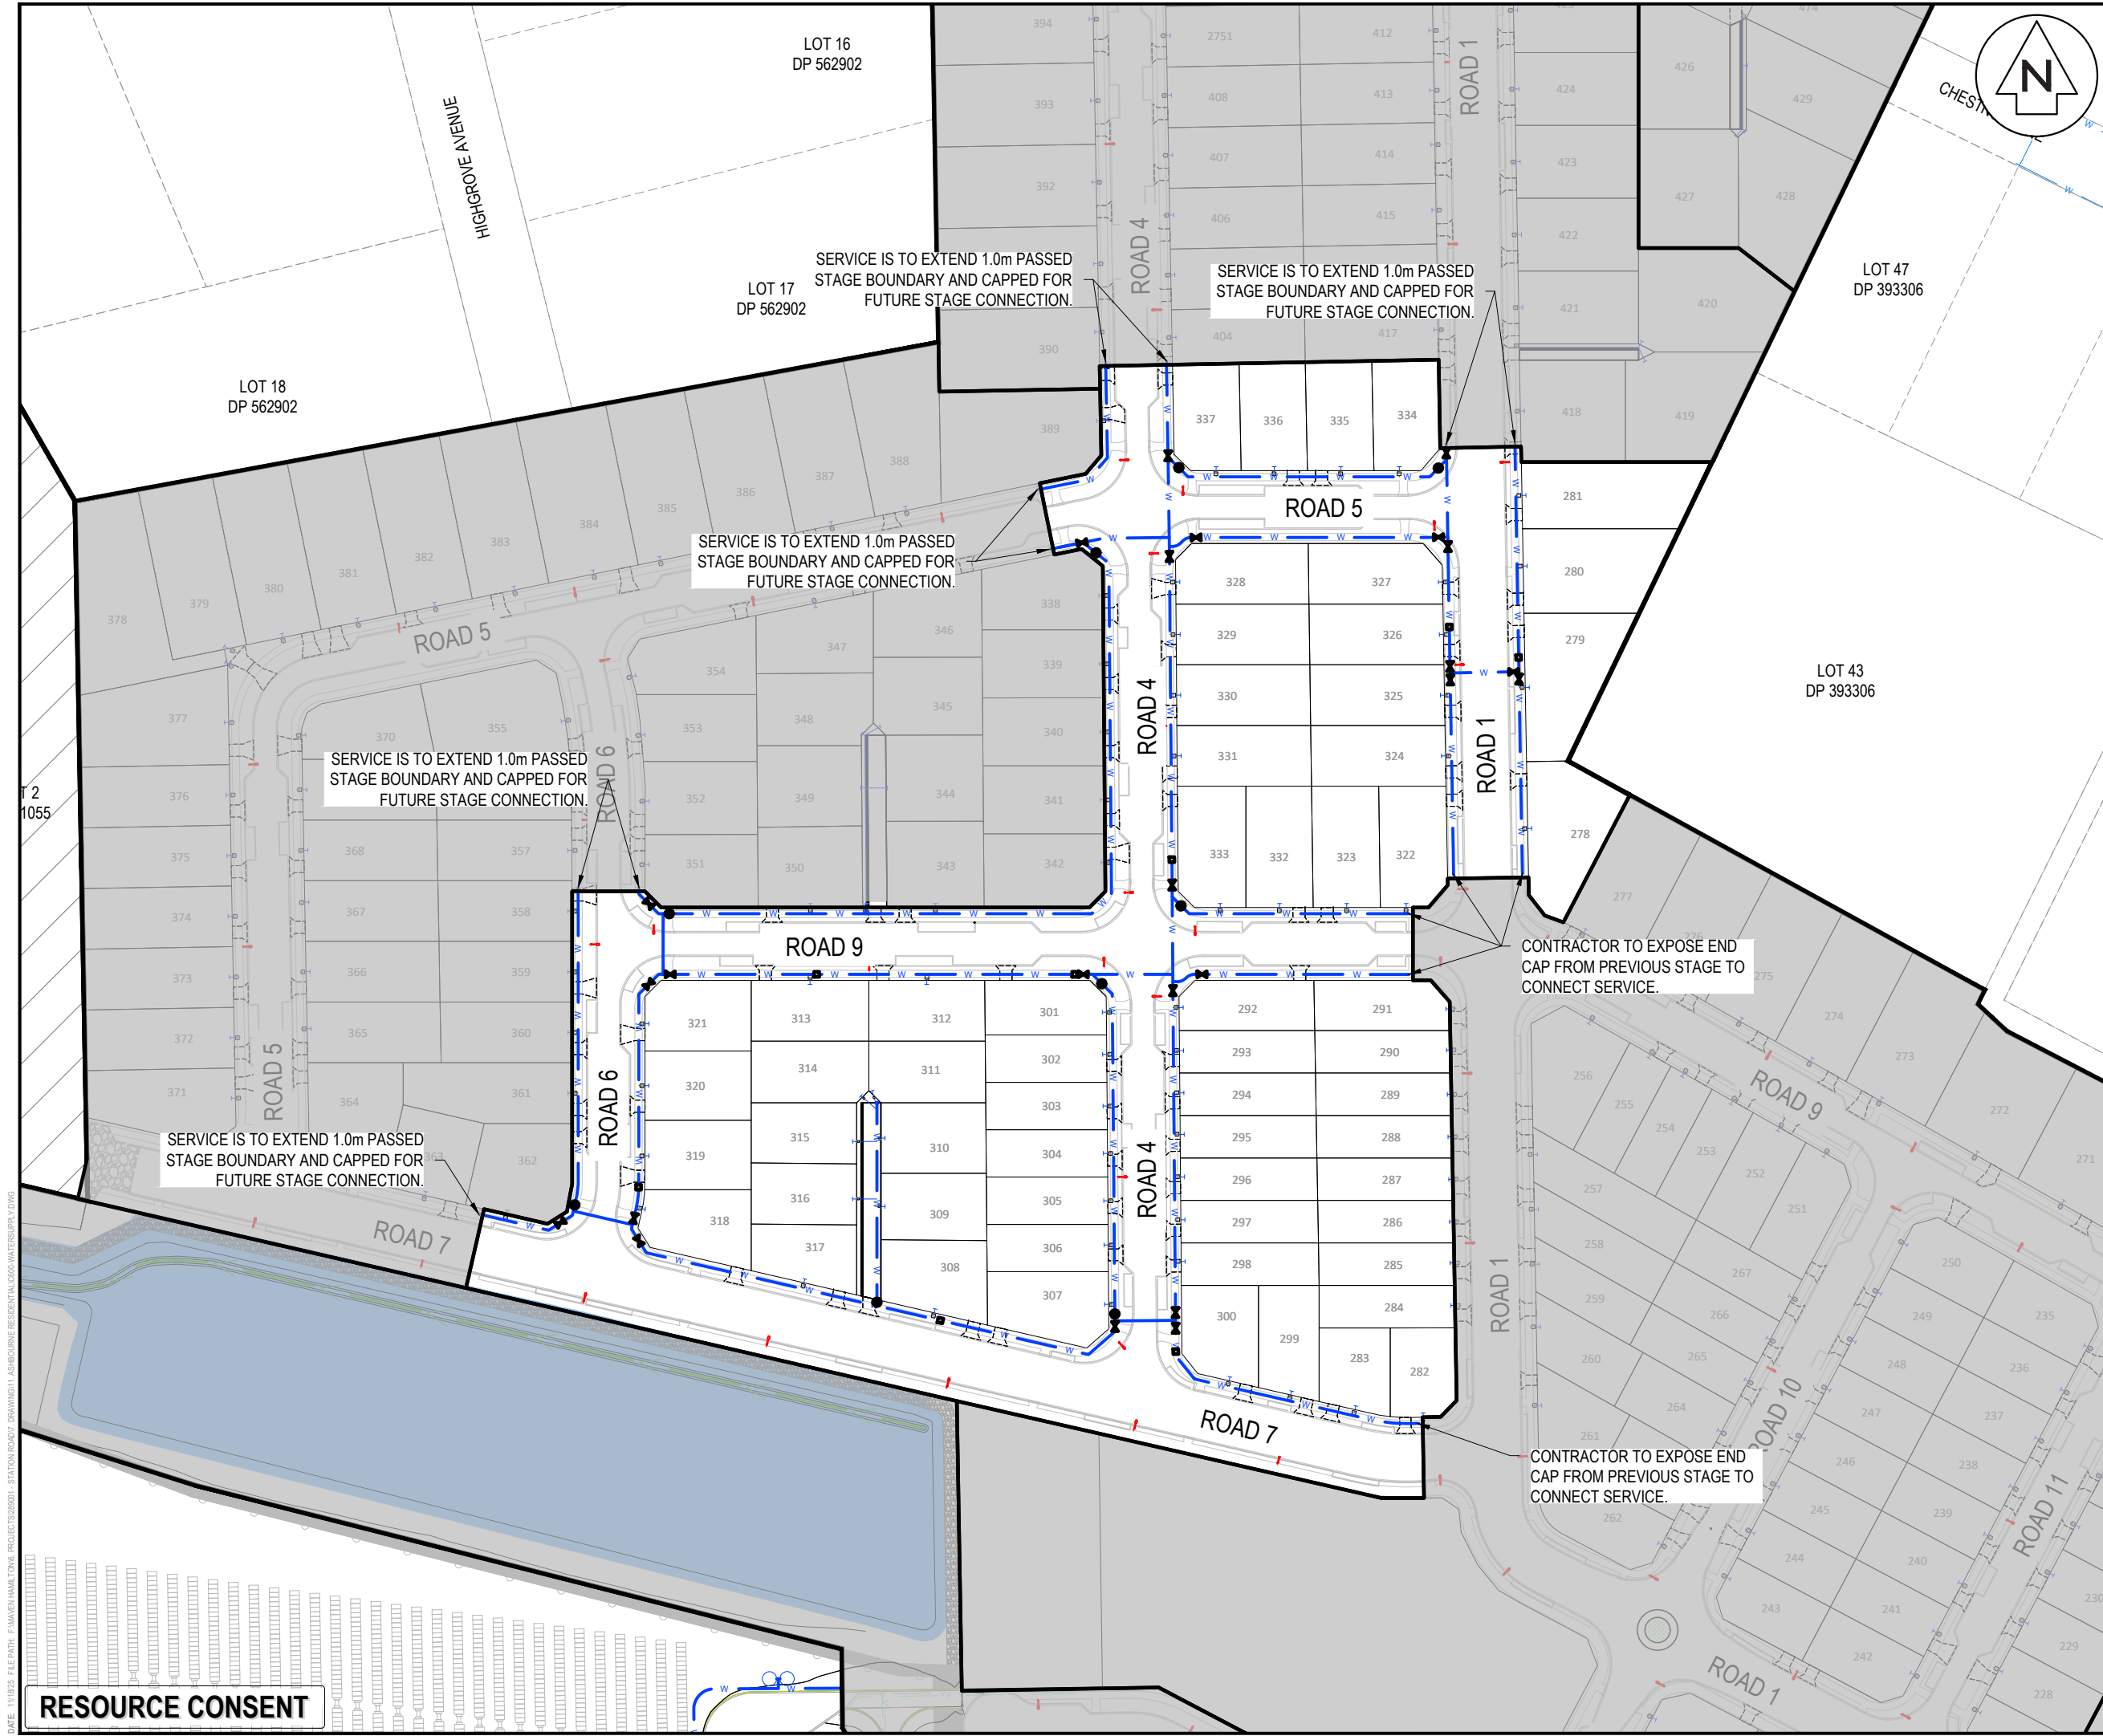

NOTES

1. ALL WORKS TO BE IN ACCORDANCE WITH REGIONAL INFRASTRUCTURE TECHNICAL SPECIFICATIONS (RITS).

2. CO-ORDINATES IN TERMS OF NZ GEODETIC DATUM MOUNT EDEN 2000.

3. LEVELS IN TERMS OF THE NEW ZEALAND VERTICAL DATUM 2016.

4. BENCHMARK: IT I DPS 29877 RL:65.51. SOURCED FROM THE LINZ GEODETIC DATABASE.

5. ALL WATER LINES TO BE BLANK CAPPED BEYOND STAGING BOUNDARY. CONTRACTOR TO MAKE SURE BLANK CAP IS OUTSIDE OF FOOTPATH EXTENTS AND ACCESSIBLE FOR FUTURE EXTENSIONS.

6. ALL TOBIES WITHIN RIGHT OF WAYS (ROW) TO BE PLACED IN HEAVY DUTY TRAFFICABLE MANIFOLD BOX.

7. EXISTING SERVICES SHOWN ARE FROM B4UDIG AND ARE INDICATIVE ONLY. CONTRACTOR TO CONFIRM THEIR LOCATION PRIOR TO CONSTRUCTION.

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Legend

PR BOUNDARY

EX BDY

PR SITE BOUNDARY

PR STAGE BOUNDARY

EX WATERMAIN

EX/PR HYDRANT

EX/PR METER

EX/PR SLUICE VALVE

EX/PR PEET VALVE

PR WATERMAIN

PR LOT CONNECTION

PR FLUSHING VALVE

PR STORMWATER

PR WASTEWATER

EX/PR BLANKCAP

C	FAST TRACK APP	GNT	11/2025
B	FAST TRACK APP	MKS	06/2025
A	FAST TRACK APP	NDL	05/2025
Rev	Description	By	Date
Survey	MAVEN		03/2024
Design	MES		05/2025
Drawn	NDL		05/2025
Checked	DJM		06/2025

M

MAVEN

Maven Waikato

07 242 0601

info@maven.co.nz

www.maven.co.nz

Level 1 286 Victoria Street, Hamilton

New Zealand

Project

ASHBOURNE  
RESIDENTIAL  
FOR  
MATAMATA  
DEVELOPMENTS LTD

Title

PROPOSED  
WATER SUPPLY  
PLAN STAGE 5


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Drawing no.	C600-16	Rev	C

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RESOURCE CONSENT



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- NOTES
1. ALL WORKS TO BE IN ACCORDANCE WITH REGIONAL INFRASTRUCTURE TECHNICAL SPECIFICATIONS (RITS).
  2. CO-ORDINATES IN TERMS OF NZ GEODETIC DATUM MOUNT EDEN 2000.
  3. LEVELS IN TERMS OF THE NEW ZEALAND VERTICAL DATUM 2016.
  4. BENCHMARK: IT 1 DPS 29877 RL:65.51. SOURCED FROM THE LINZ GEODETIC DATABASE.
  5. ALL WATER LINES TO BE BLANK CAPPED BEYOND STAGING BOUNDARY. CONTRACTOR TO MAKE SURE BLANK CAP IS OUTSIDE OF FOOTPATH EXTENTS AND ACCESSIBLE FOR FUTURE EXTENSIONS.
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Legend

	PR BOUNDARY
	EX BDY
	PR SITE BOUNDARY
	PR STAGE BOUNDARY
	EX WATERMAIN
	EX/PR HYDRANT
	EX/PR METER
	EX/PR SLUICE VALVE
	EX/PR PEET VALVE
	PR WATERMAIN
	PR LOT CONNECTION
	PR FLUSHING VALVE
	PR STORMWATER
	PR WASTEWATER
	EX/PR BLANKCAP

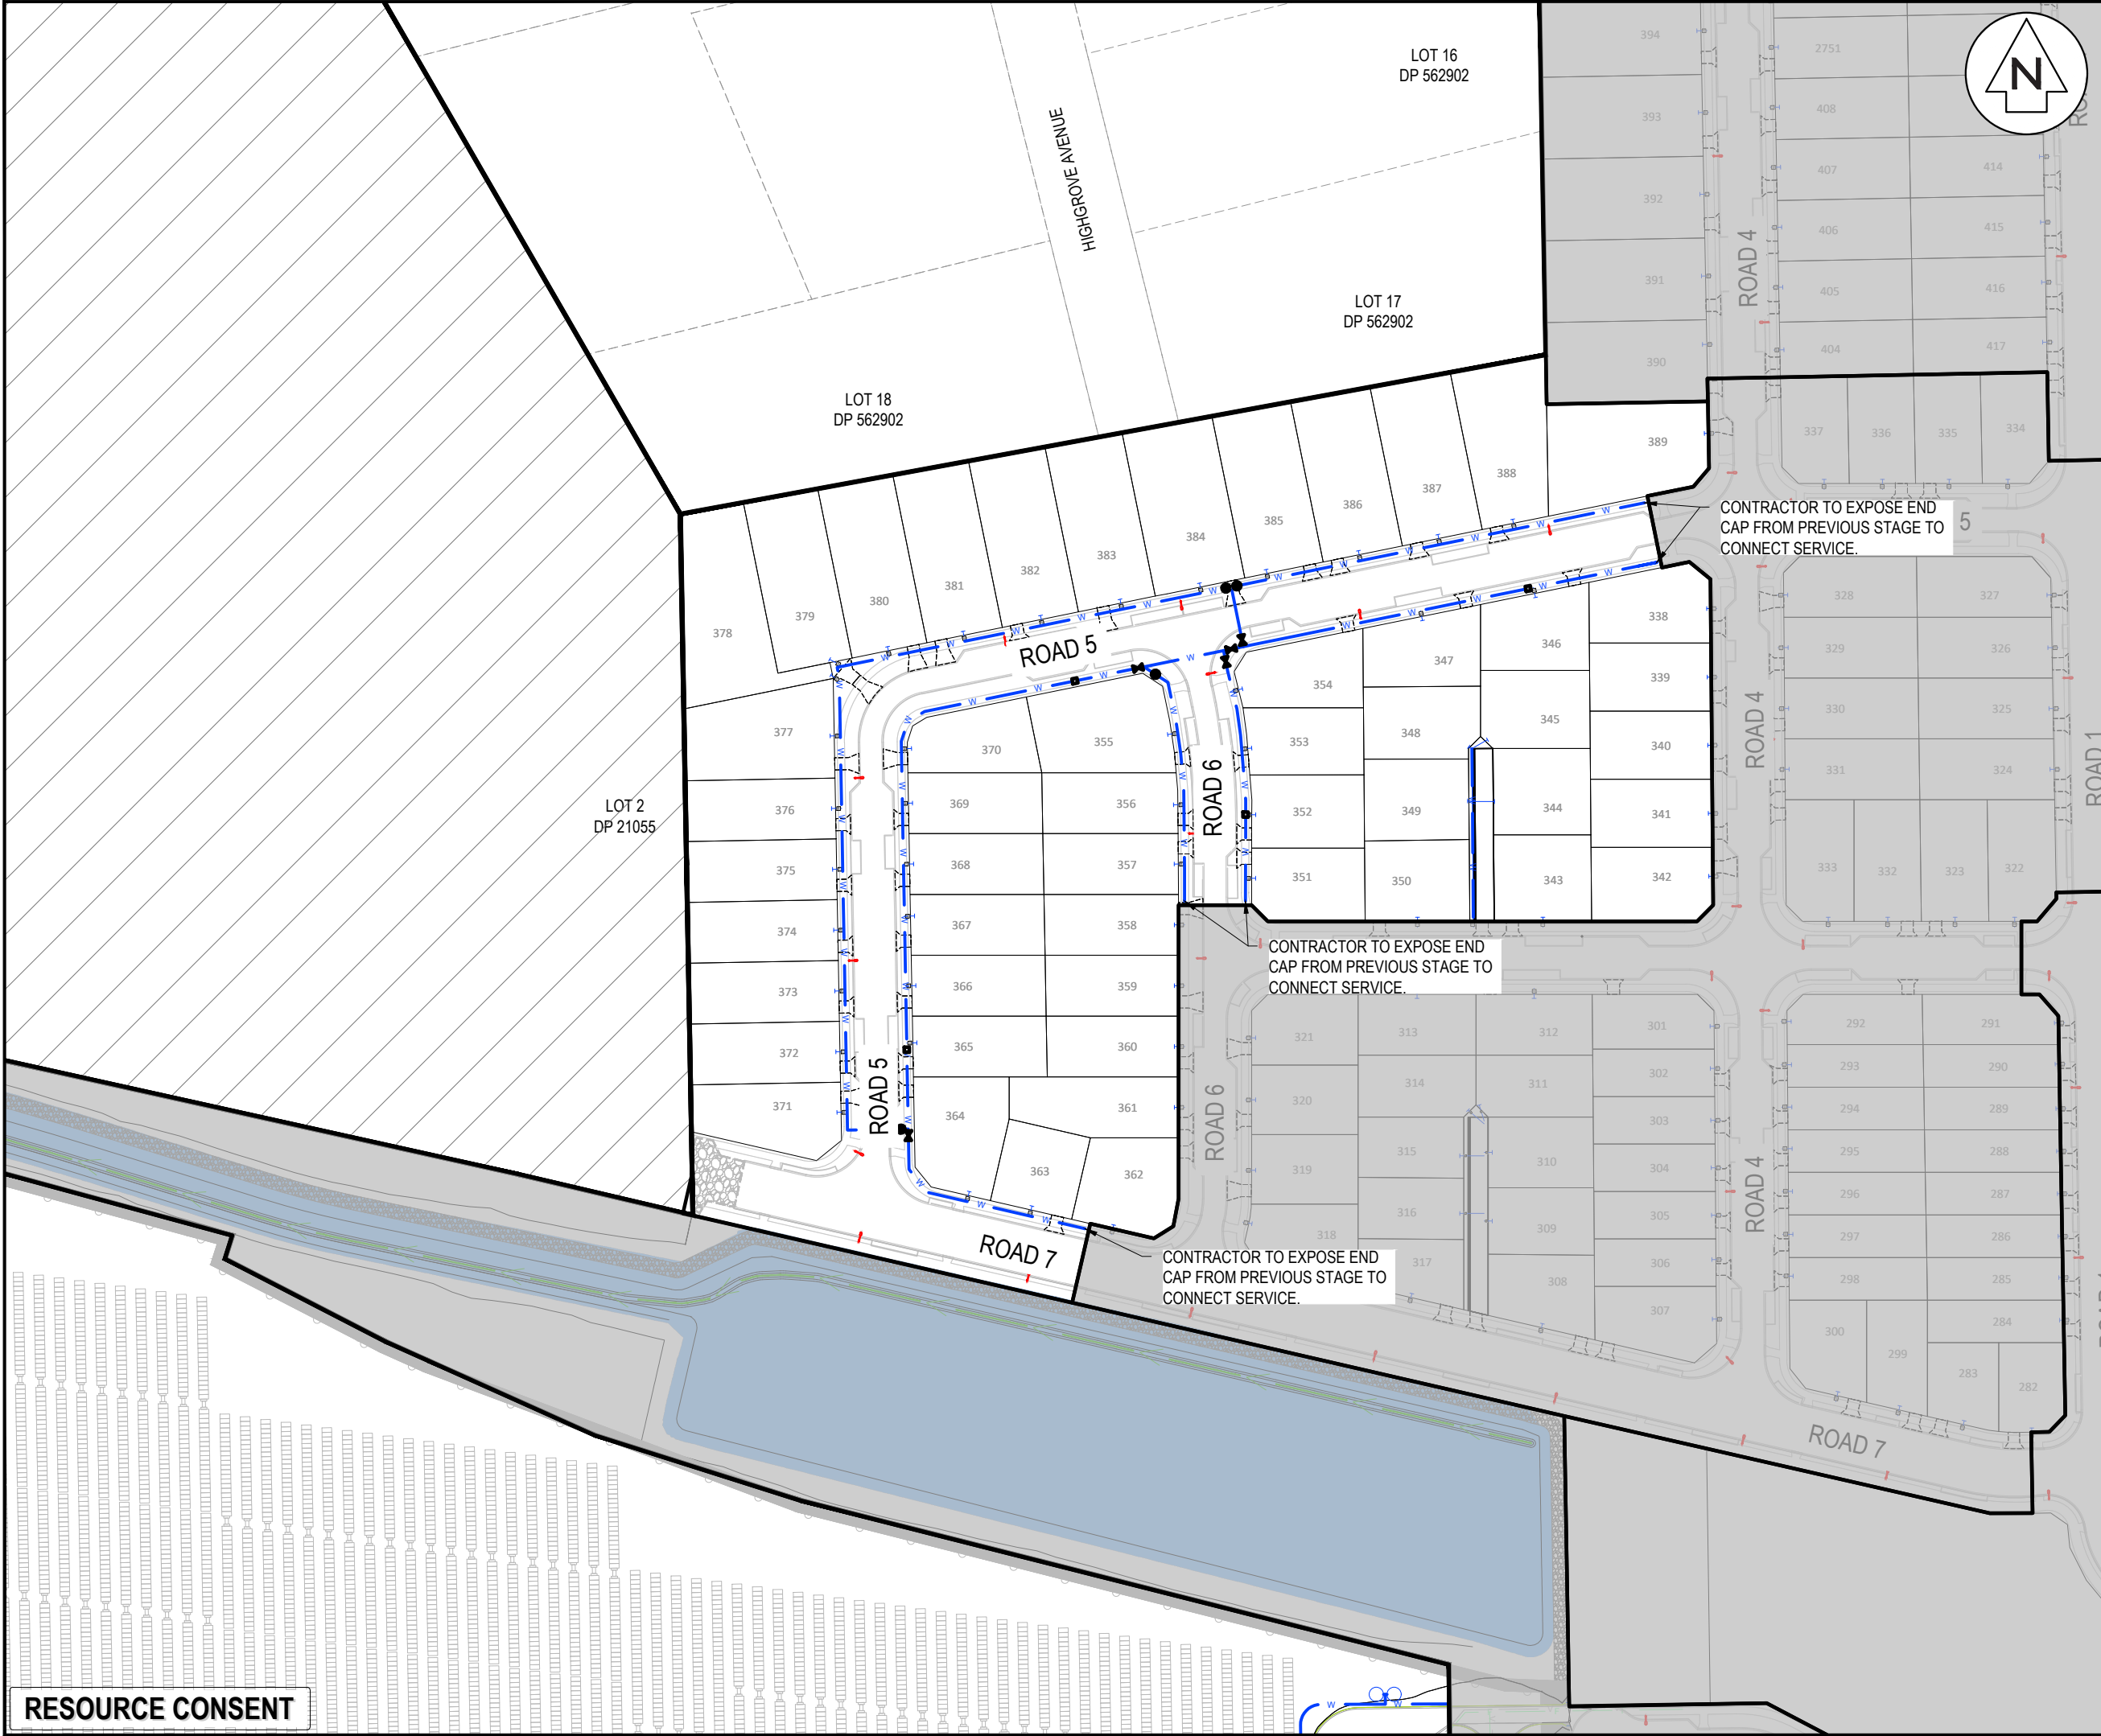C	FAST TRACK APP	GNT	11/2025
B	FAST TRACK APP	MKS	06/2025
A	FAST TRACK APP	NDL	05/2025
Rev	Description	By	Date
Survey	MAVEN		03/2024
Design	MES		05/2025
Drawn	NDL		05/2025
Checked	DJM		06/2025



Project


**ASHBOURNE  
RESIDENTIAL  
FOR  
MATAMATA  
DEVELOPMENTS LTD**

Title

**PROPOSED  
WATER SUPPLY  
PLAN STAGE 6**

Project no.	289001
Scale	1:1500 @ A3
Cad file	C600-WATERSUPPLY.DWG
Drawing no.	C600-17
Rev	C

RESOURCE CONSENT

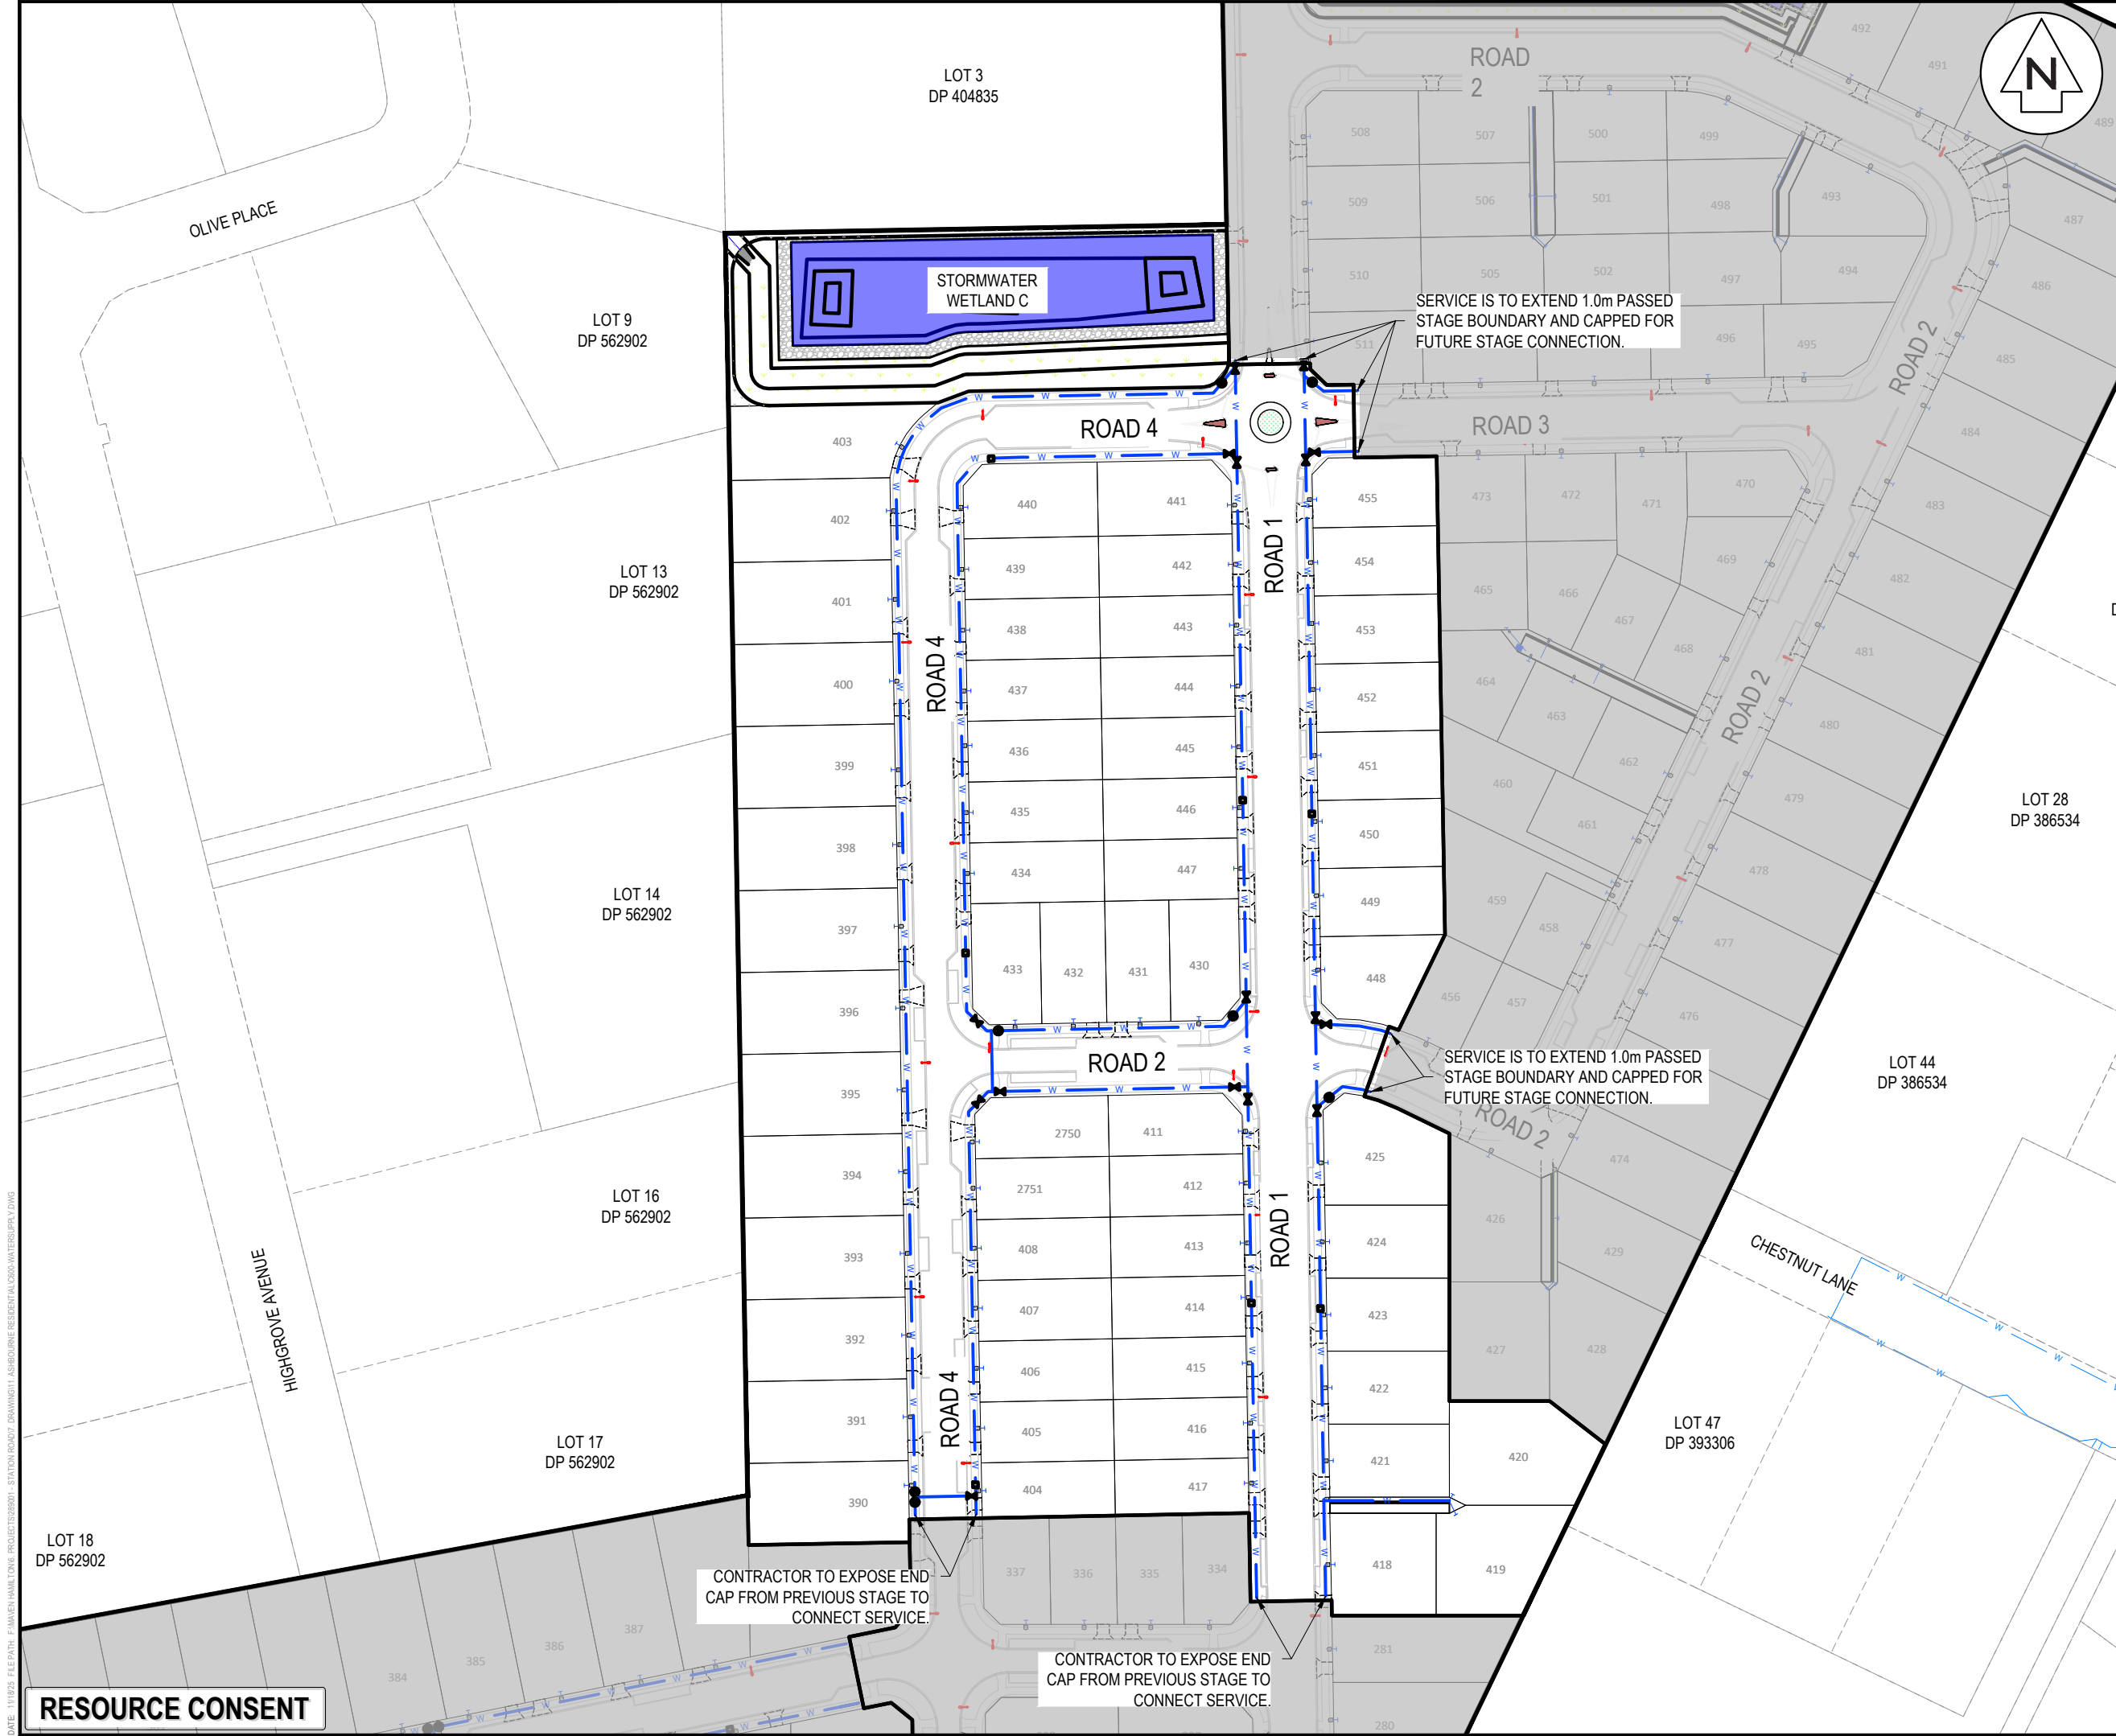

NOTES

1. ALL WORKS TO BE IN ACCORDANCE WITH REGIONAL INFRASTRUCTURE TECHNICAL SPECIFICATIONS (RITS).
2. CO-ORDINATES IN TERMS OF NZ GEODETIC DATUM MOUNT EDEN 2000.
3. LEVELS IN TERMS OF THE NEW ZEALAND VERTICAL DATUM 2016.
4. BENCHMARK: IT I DPS 29877 RL:65.51. SOURCED FROM THE LINZ GEODETIC DATABASE.
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Legend

	PR BOUNDARY
	EX BDY
	PR SITE BOUNDARY
	PR STAGE BOUNDARY
	EX WATERMAIN
	EX/PR HYDRANT
	EX/PR METER
	EX/PR SLUICE VALVE
	EX/PR PEET VALVE
	PR WATERMAIN
	PR LOT CONNECTION
	PR FLUSHING VALVE
	PR STORMWATER
	PR WASTEWATER
	EX/PR BLANKCAP

C	FAST TRACK APP	GNT	11/2025
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		By	Date
Survey	MAVEN		03/2024
Design	MES		05/2025
Drawn	NDL		05/2025
Checked	DJM		06/2025

**Maven Waikato**  
07 242 0601  
info@maven.co.nz  
www.maven.co.nz  
Level 1 286 Victoria Street, Hamilton  
New Zealand

Project

**ASHBOURNE  
RESIDENTIAL  
FOR  
MATAMATA  
DEVELOPMENTS LTD**


Title

**PROPOSED  
WATER SUPPLY  
PLAN STAGE 7**

Project no.	289001		
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Drawing no.	C600-18	Rev	<b>C</b>

DATE: 11/19/25 FILEPATH: F:\Maven\Hamilton\6. PROJECTS\289001 - STATION ROAD\DRAWING\1. ASHBORNE RESIDENTIAL\0600-WATERSUPPLY.DWG



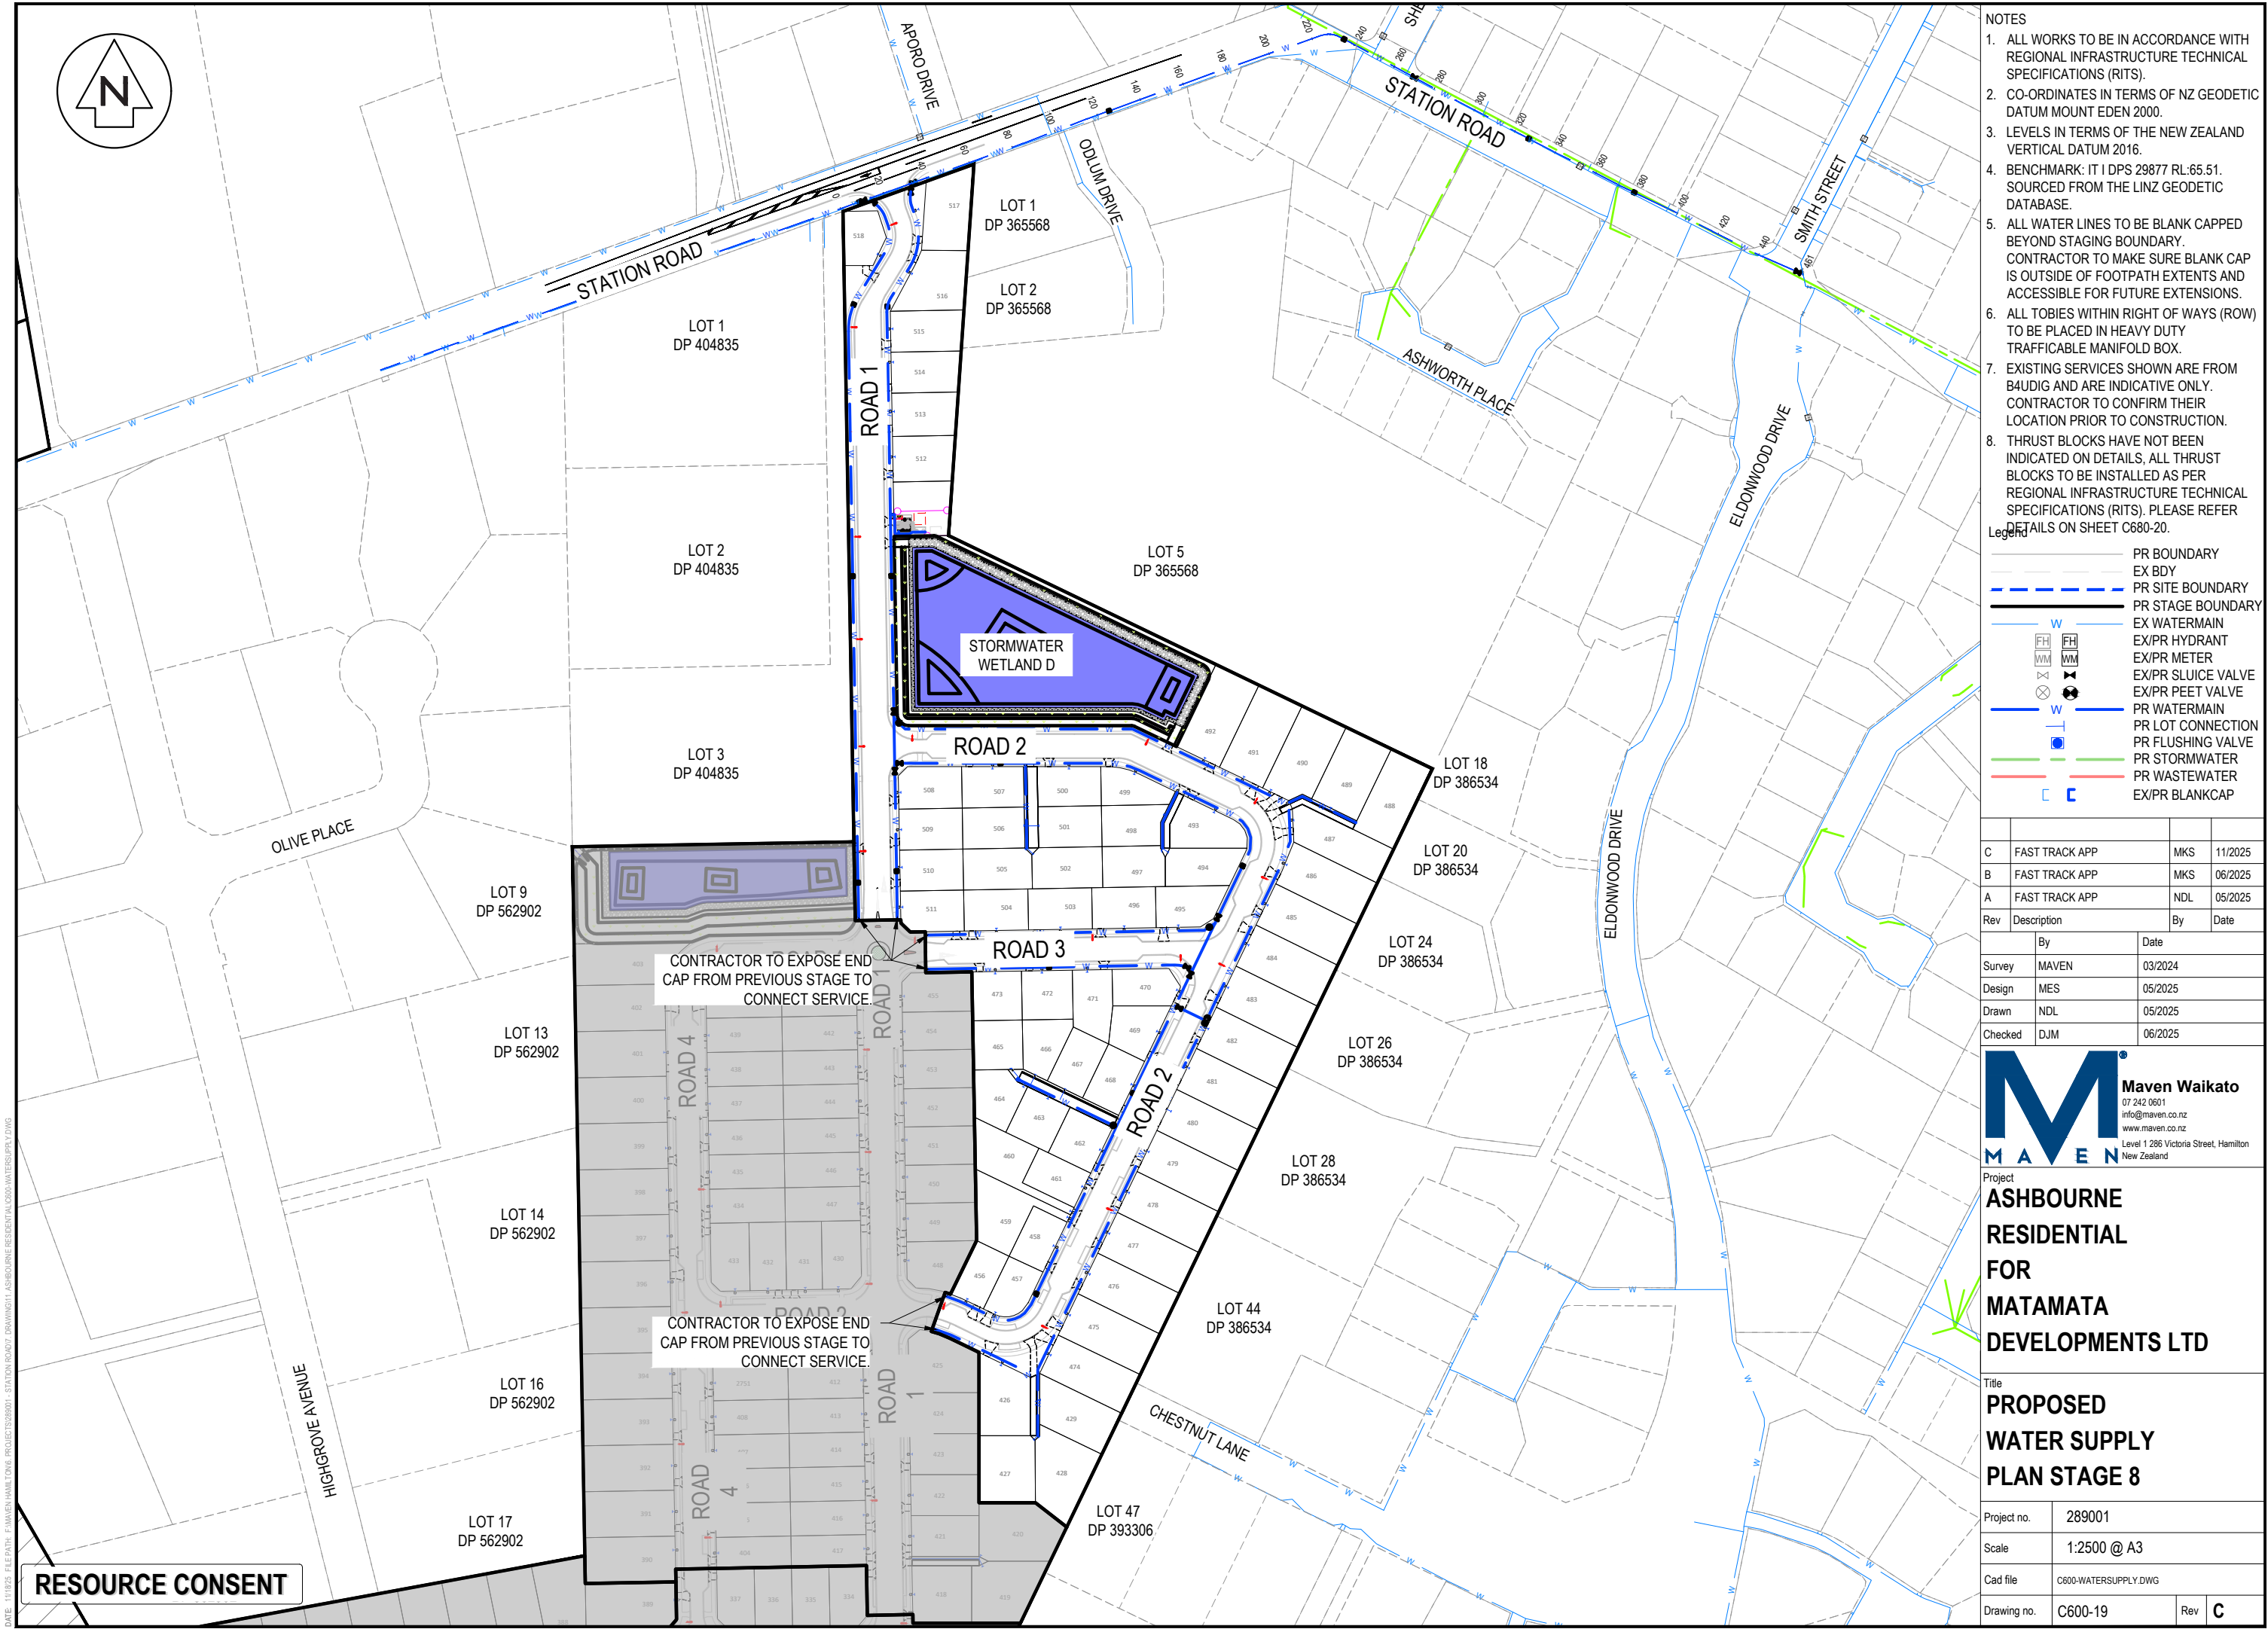

- NOTES
1. ALL WORKS TO BE IN ACCORDANCE WITH REGIONAL INFRASTRUCTURE TECHNICAL SPECIFICATIONS (RITS).
  2. CO-ORDINATES IN TERMS OF NZ GEODETIC DATUM MOUNT EDEN 2000.
  3. LEVELS IN TERMS OF THE NEW ZEALAND VERTICAL DATUM 2016.
  4. BENCHMARK: IT 1 DPS 29877 RL:65.51. SOURCED FROM THE LINZ GEODETIC DATABASE.
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Legend	
	PR BOUNDARY
	EX BDY
	PR SITE BOUNDARY
	PR STAGE BOUNDARY
	EX WATERMAIN
	EX/PR HYDRANT
	EX/PR METER
	EX/PR SLUICE VALVE
	EX/PR PEET VALVE
	PR WATERMAIN
	PR LOT CONNECTION
	PR FLUSHING VALVE
	PR STORMWATER
	PR WASTEWATER
	EX/PR BLANKCAP




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Rev	Description	By	Date
		By	Date
Survey	MAVEN		03/2024
Design	MES		05/2025
Drawn	NDL		05/2025
Checked	DJM		06/2025

**Maven Waikato**  
07 242 0601  
info@maven.co.nz  
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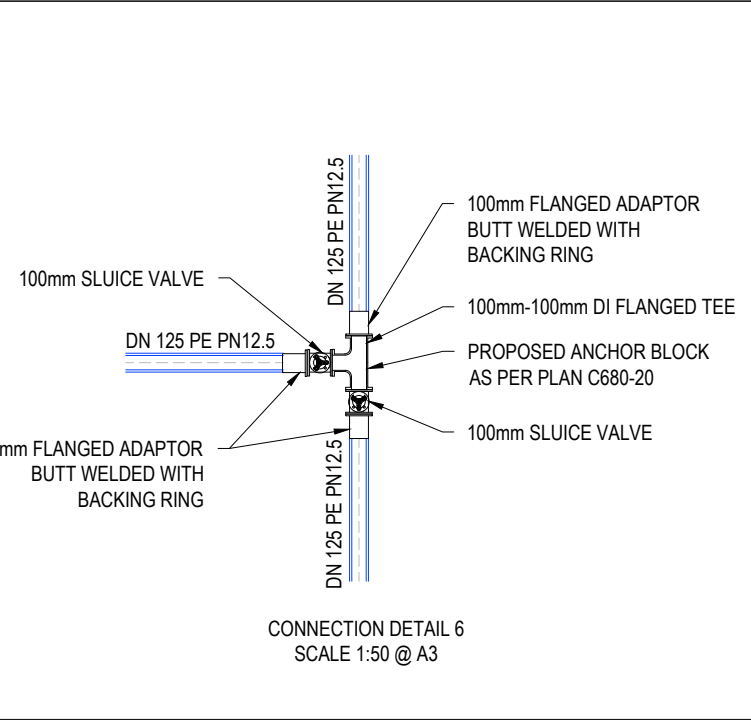
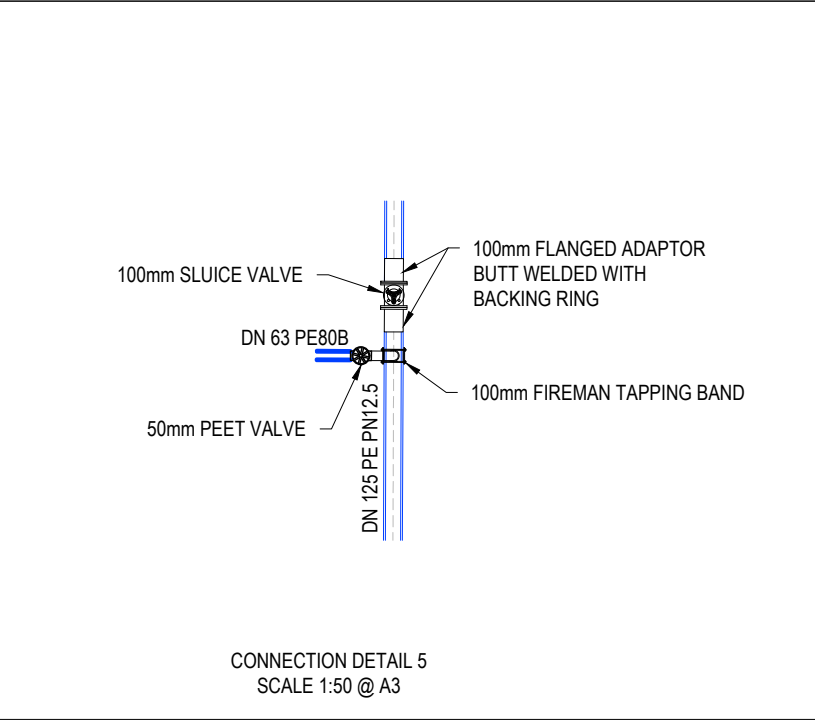
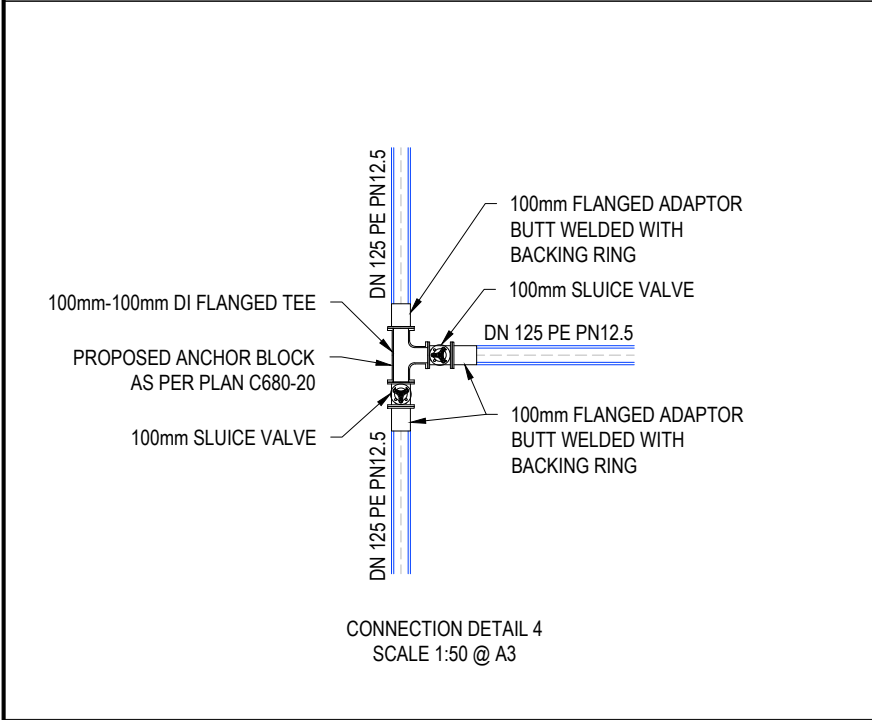
Project  
**ASHBOURNE  
RESIDENTIAL  
FOR  
MATAMATA  
DEVELOPMENTS LTD**

Title  
**PROPOSED  
WATER SUPPLY  
PLAN STAGE 8**




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Drawing no.	C600-19	Rev	C

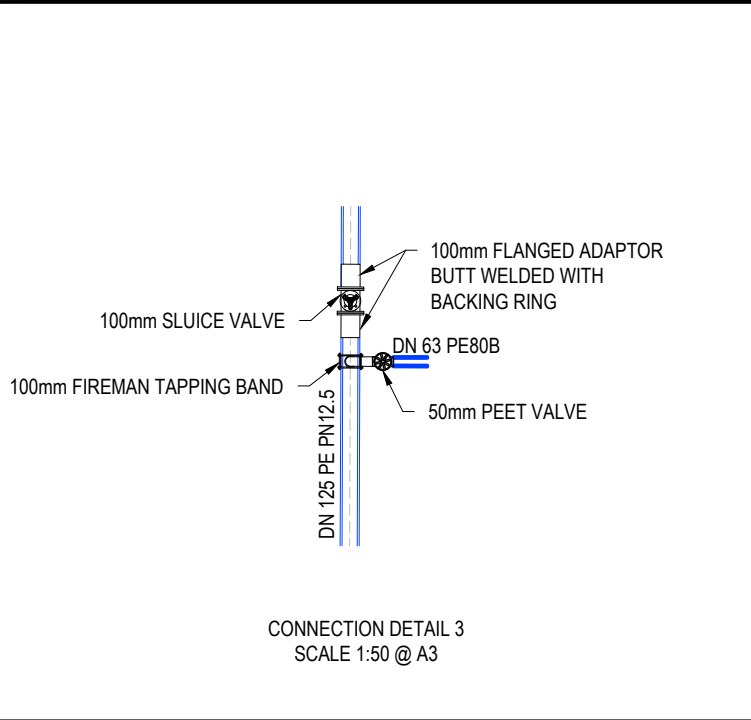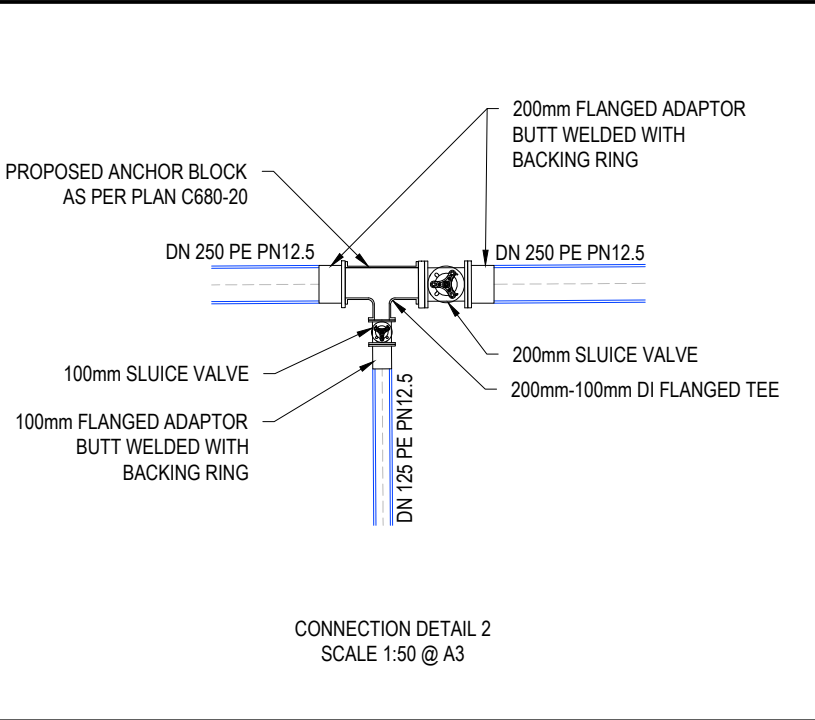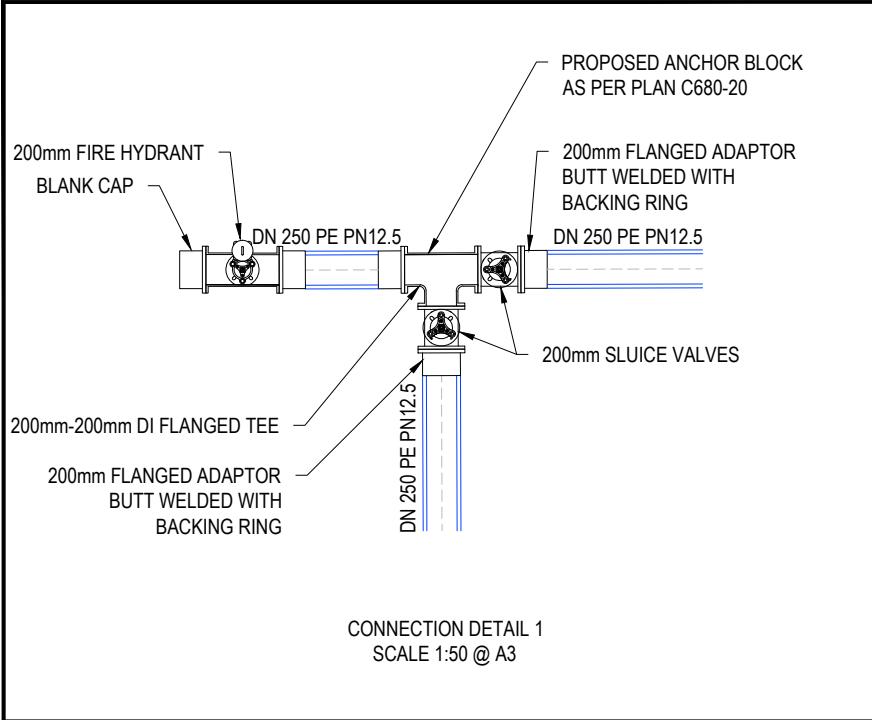


- NOTES
1. ALL WORKS TO BE IN ACCORDANCE WITH REGIONAL INFRASTRUCTURE TECHNICAL SPECIFICATIONS (RITS).
  2. CO-ORDINATES IN TERMS OF NZ GEODETIC DATUM MOUNT EDEN 2000.
  3. LEVELS IN TERMS OF THE NEW ZEALAND VERTICAL DATUM 2016.
  5. STUB FLANGE, BACKING RING AND STUB TO BE WELDED TO PE PIPE.
  6. THRUST BLOCKS HAVE NOT BEEN INDICATED ON DETAILS, ALL THRUST BLOCKS TO BE INSTALLED AS PER REGIONAL INFRASTRUCTURE TECHNICAL SPECIFICATIONS (RITS). PLEASE REFER DETAILS ON SHEET C680-20.
  7. REFER TO C600 SERIES DRAWINGS FOR WATER SUPPLY LAYOUT DRAWINGS.



C	FAST TRACK APP	MKS	05/2025
B	FAST TRACK APP	TCH	04/2025
A	FAST TRACK APP	TCH	04/2025
Rev	Description	By	Date
		By	Date
Survey	MAVEN		03/2024
Design	TCH		04/2025
Drawn	TCH		04/2025
Checked	DJM		06/2025

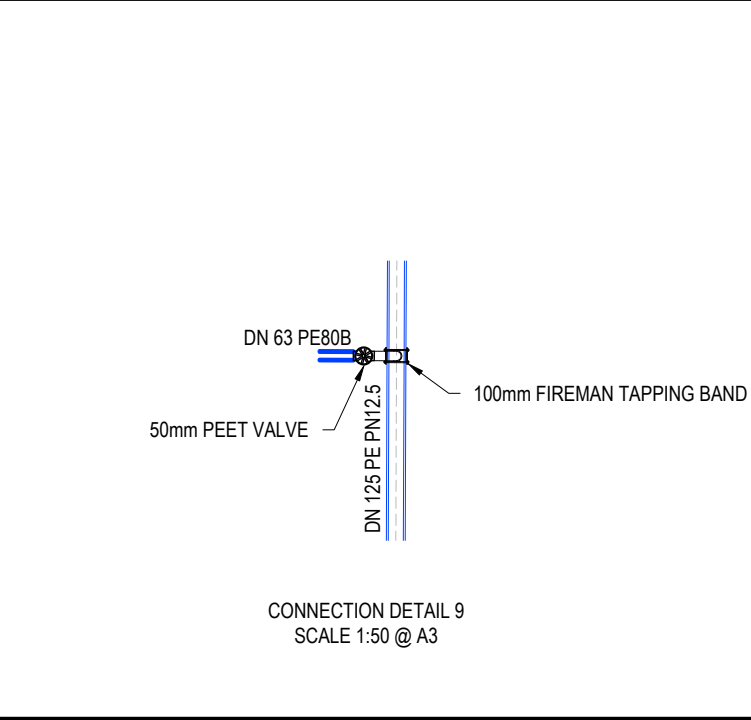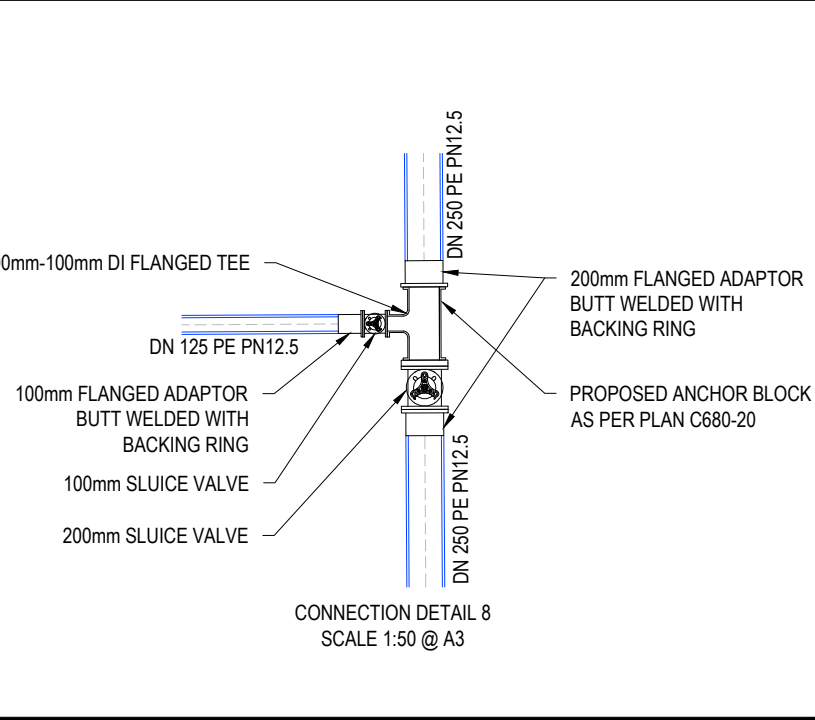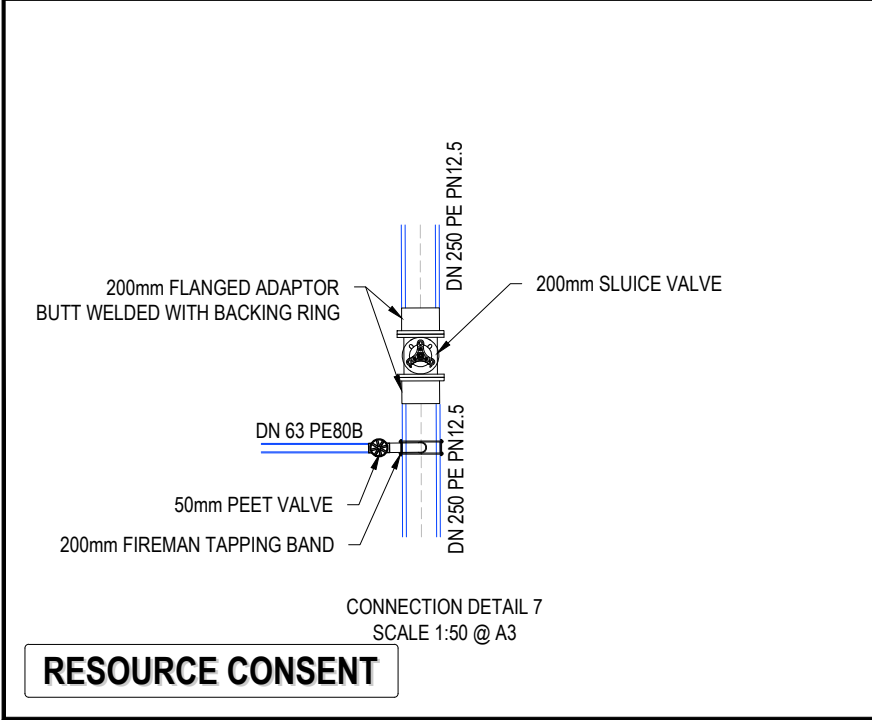



**Maven Waikato**  
07 242 0601  
info@maven.co.nz  
www.maven.co.nz  
Level 1 286 Victoria Street, Hamilton  
New Zealand

Project  
**ASHBOURNE  
RESIDENTIAL  
FOR  
MATAMATA  
DEVELOPMENTS LTD**


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**PROPOSED  
WATER SUPPLY DETAILS  
SHEET 1 OF 4**

Project no.	289001
Scale	AS SHOWN
Cad file	C600-WATERSUPPLY.DWG
Drawing no.	C650-1
Rev	C


RESOURCE CONSENT




DATE: 11/18/25 FILEPATH: F:\MVEN\HAMITON6 PROJECTS\289001 - STATION ROAD\DRAWING\1 ASHBORNE RESIDENTIAL\060-WATERSUPPLY.DWG

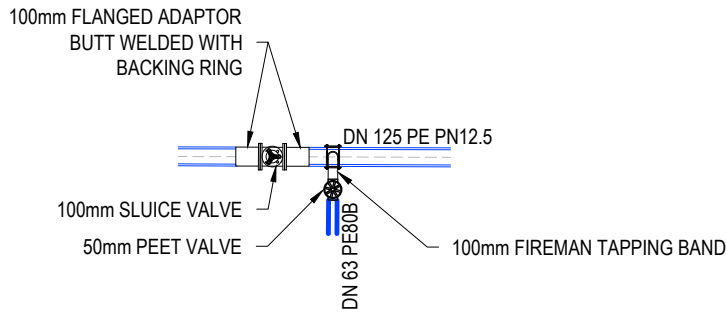


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SCALE 1:50 @ A3

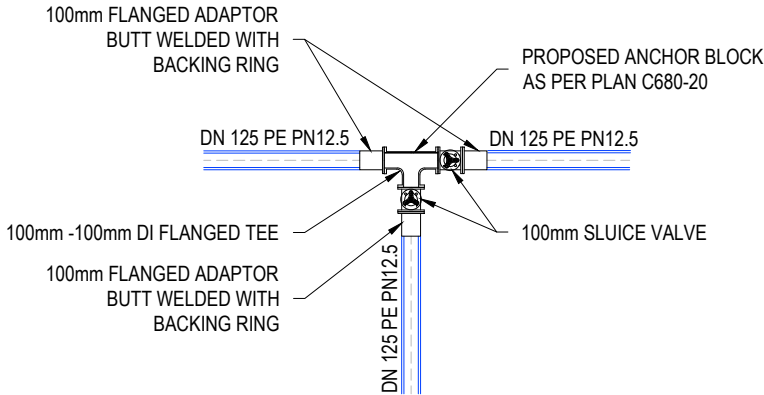


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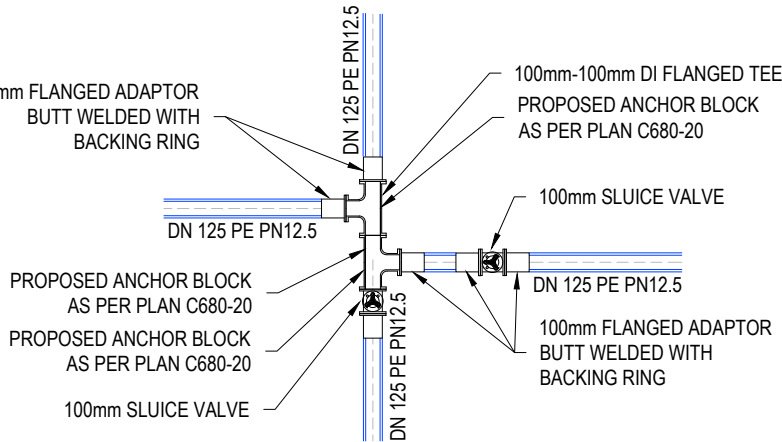
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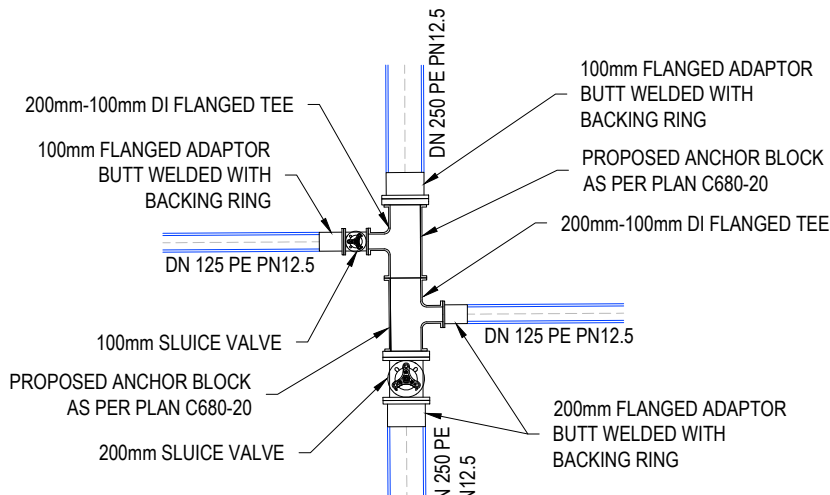
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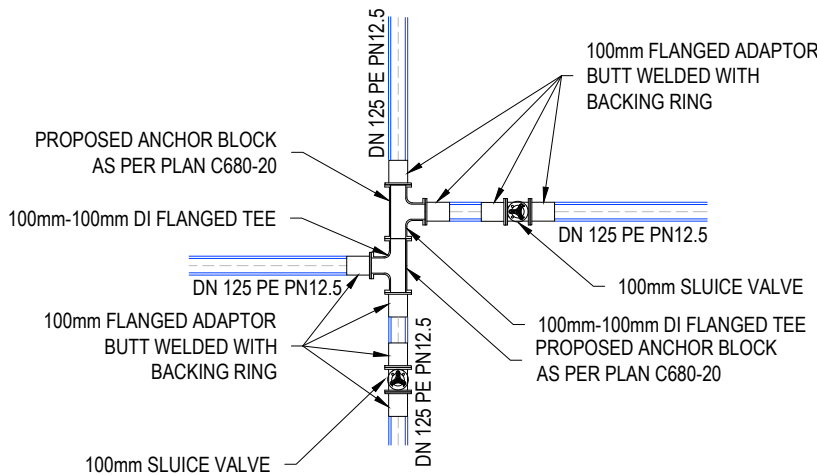
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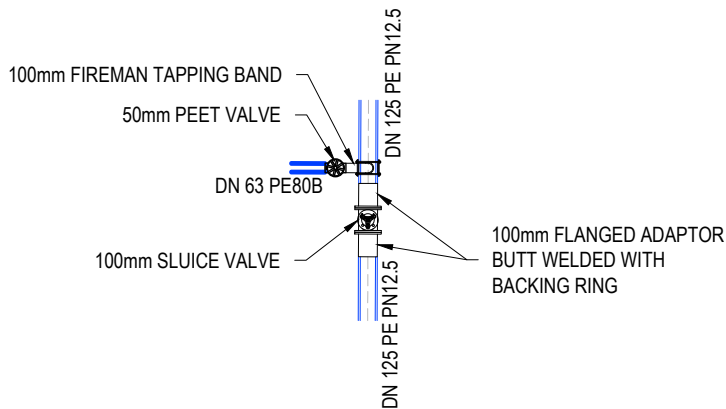
CONNECTION DETAIL 15  
SCALE 1:50 @ A3

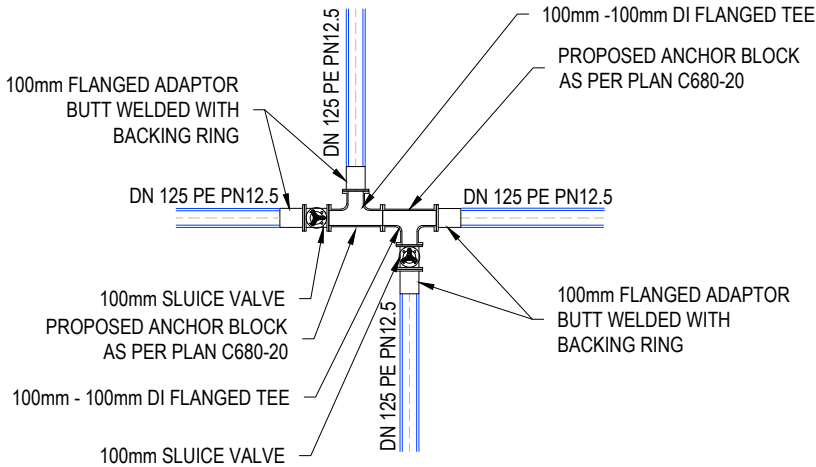

CONNECTION DETAIL 16  
SCALE 1:50 @ A3

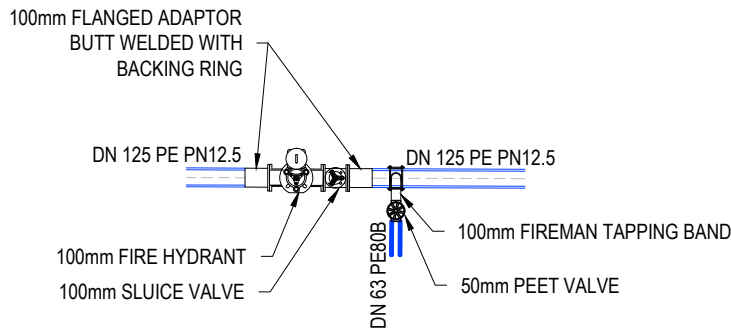

CONNECTION DETAIL 17  
SCALE 1:50 @ A3

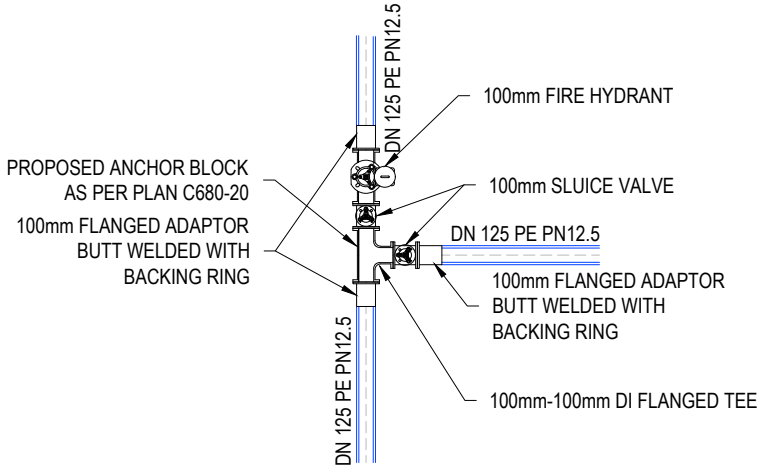

CONNECTION DETAIL 18  
SCALE 1:50 @ A3

RESOURCE CONSENT

- NOTES
1. ALL WORKS TO BE IN ACCORDANCE WITH REGIONAL INFRASTRUCTURE TECHNICAL SPECIFICATIONS (RITS).
  2. CO-ORDINATES IN TERMS OF NZ GEODETIC DATUM MOUNT EDEN 2000.
  3. LEVELS IN TERMS OF THE NEW ZEALAND VERTICAL DATUM 2016.
  5. STUB FLANGE, BACKING RING AND STUB TO BE WELDED TO PE PIPE.
  6. THRUST BLOCKS HAVE NOT BEEN INDICATED ON DETAILS, ALL THRUST BLOCKS TO BE INSTALLED AS PER REGIONAL INFRASTRUCTURE TECHNICAL SPECIFICATIONS (RITS). PLEASE REFER DETAILS ON SHEET C680-20.
  7. REFER TO C600 SERIES DRAWINGS FOR WATER SUPPLY LAYOUT DRAWINGS.

C	FAST TRACK APP	MKS	05/2025
B	FAST TRACK APP	TCH	04/2025
A	FAST TRACK APP	TCH	04/2025
Rev	Description	By	Date
		By	Date
Survey	MAVEN		03/2024
Design	TCH		04/2025
Drawn	TCH		04/2025
Checked	DJM		06/2025




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DEVELOPMENTS LTD**


Title  
**PROPOSED  
WATER SUPPLY DETAILS  
SHEET 2 OF 4**

Project no.	289001		
Scale	AS SHOWN		
Cad file	C600-WATERSUPPLY.DWG		
Drawing no.	C650-2	Rev	C


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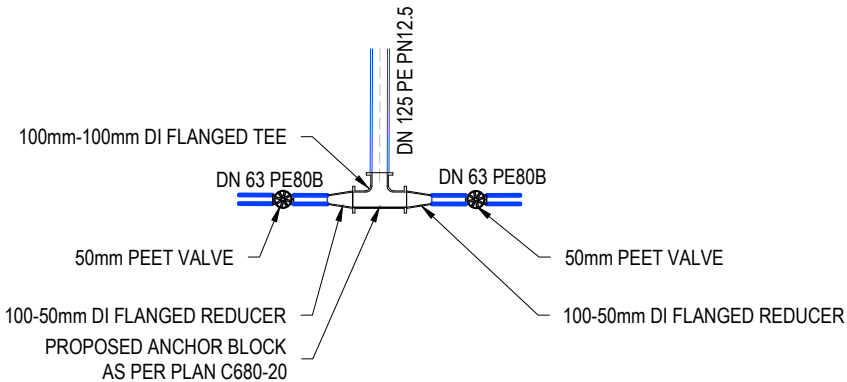
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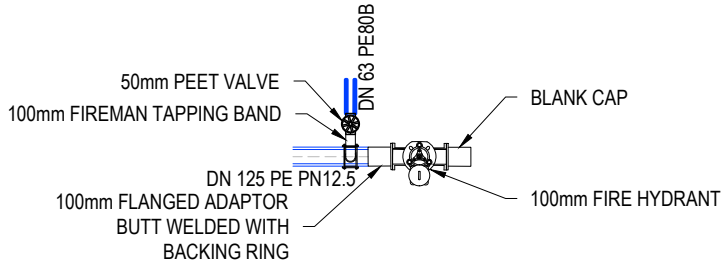
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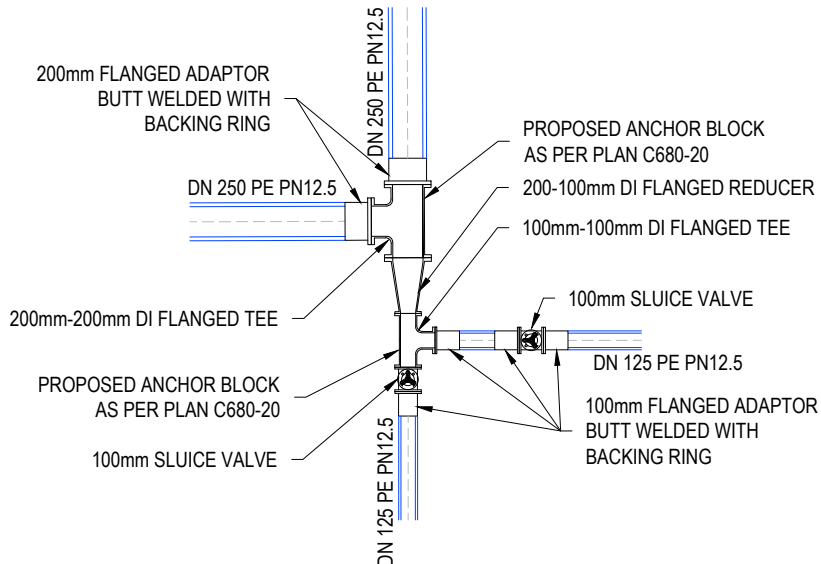
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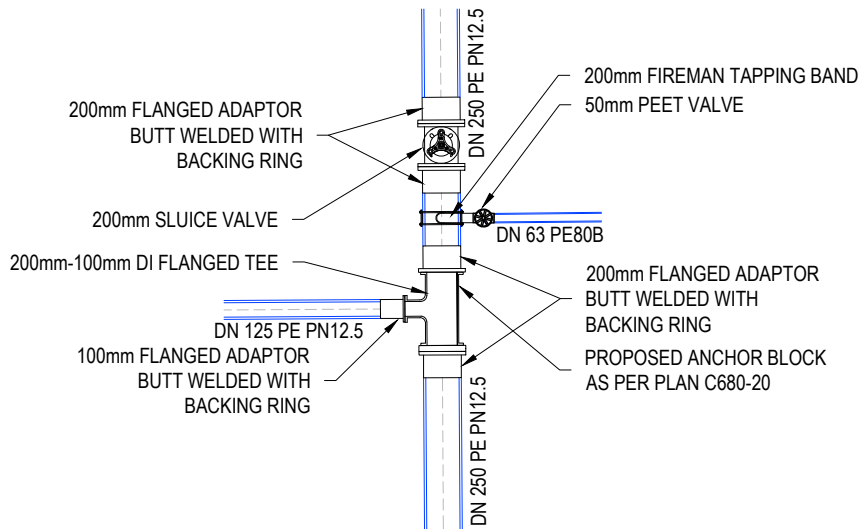
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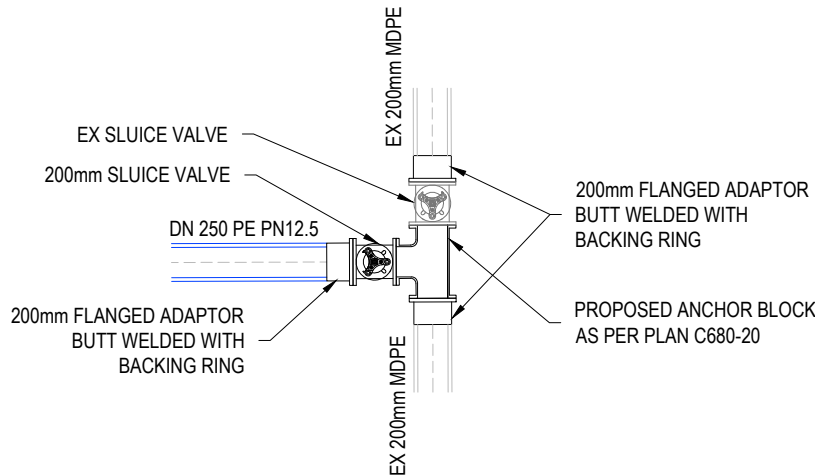
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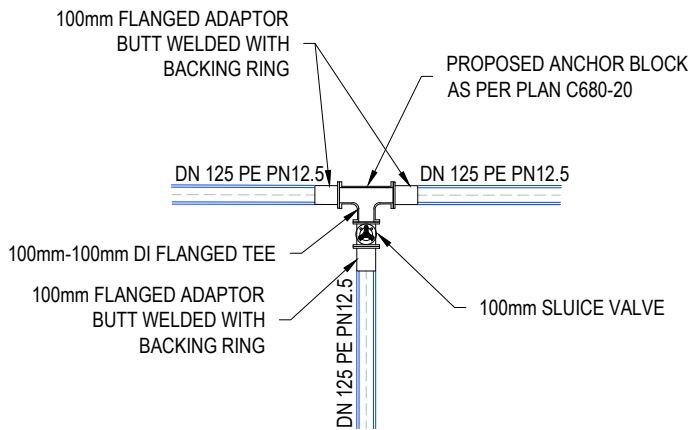
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CONNECTION DETAIL 25  
SCALE 1:50 @ A3

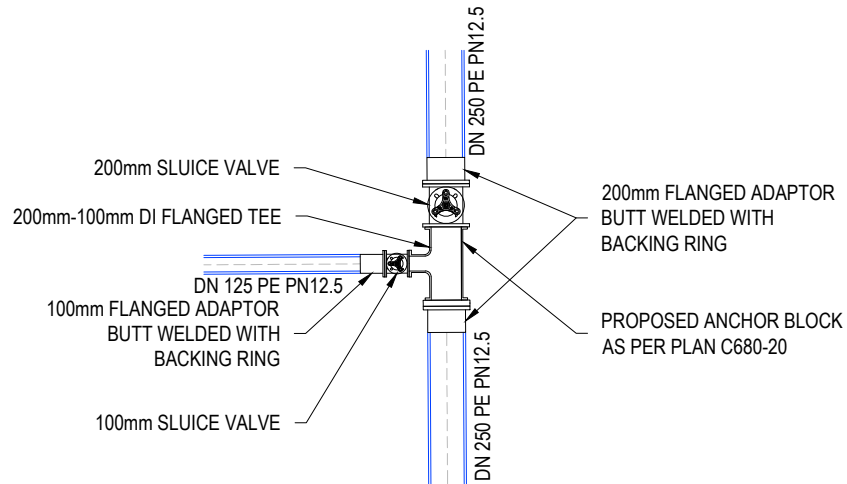

CONNECTION DETAIL 26  
SCALE 1:50 @ A3

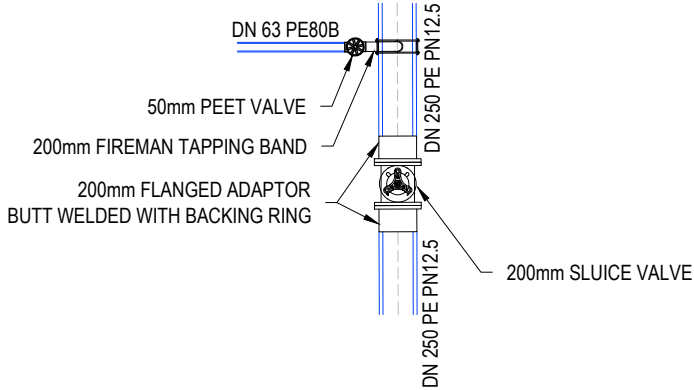

CONNECTION DETAIL 27  
SCALE 1:50 @ A3

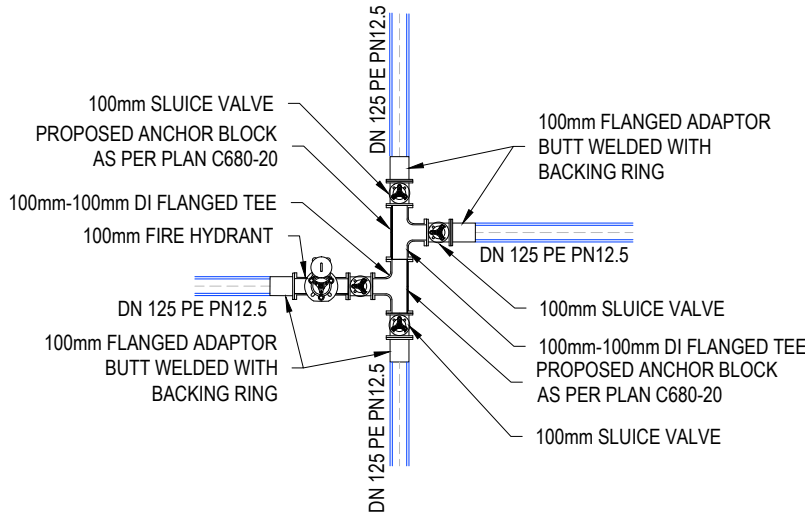RESOURCE CONSENT

- NOTES
1. ALL WORKS TO BE IN ACCORDANCE WITH REGIONAL INFRASTRUCTURE TECHNICAL SPECIFICATIONS (RITS).
  2. CO-ORDINATES IN TERMS OF NZ GEODETIC DATUM MOUNT EDEN 2000.
  3. LEVELS IN TERMS OF THE NEW ZEALAND VERTICAL DATUM 2016.
  5. STUB FLANGE, BACKING RING AND STUB TO BE WELDED TO PE PIPE.
  6. THRUST BLOCKS HAVE NOT BEEN INDICATED ON DETAILS, ALL THRUST BLOCKS TO BE INSTALLED AS PER REGIONAL INFRASTRUCTURE TECHNICAL SPECIFICATIONS (RITS). PLEASE REFER DETAILS ON SHEET C680-20.
  7. REFER TO C600 SERIES DRAWINGS FOR WATER SUPPLY LAYOUT DRAWINGS.

Rev	Description	By	Date
C	FAST TRACK APP	MKS	05/2025
B	FAST TRACK APP	TCH	04/2025
A	FAST TRACK APP	TCH	04/2025

**M** **MAVEN** **Waikato**  
07 242 0601  
info@maven.co.nz  
www.maven.co.nz  
Level 1 286 Victoria Street, Hamilton  
New Zealand

Project  
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DEVELOPMENTS LTD**


Title  
**PROPOSED  
WATER SUPPLY DETAILS  
SHEET 3 OF 4**

Project no.	289001
Scale	AS SHOWN
Cad file	C600-WATERSUPPLY.DWG
Drawing no.	C650-3
Rev	C




DATE: 11/19/25 FILEPATH: F:\MVEN\HAMITON6 PROJECTS\289001 - STATION ROAD\7 DRAWING\11 ASHBORNE RESIDENTIAL\0600-WATERSUPPLY.DWG


RESOURCE CONSENT

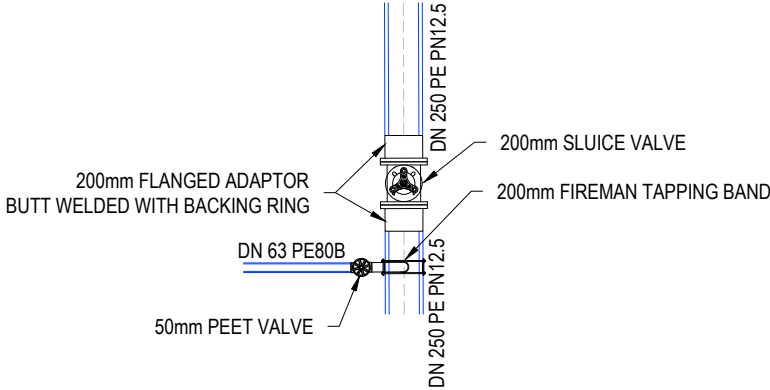


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SCALE 1:50 @ A3

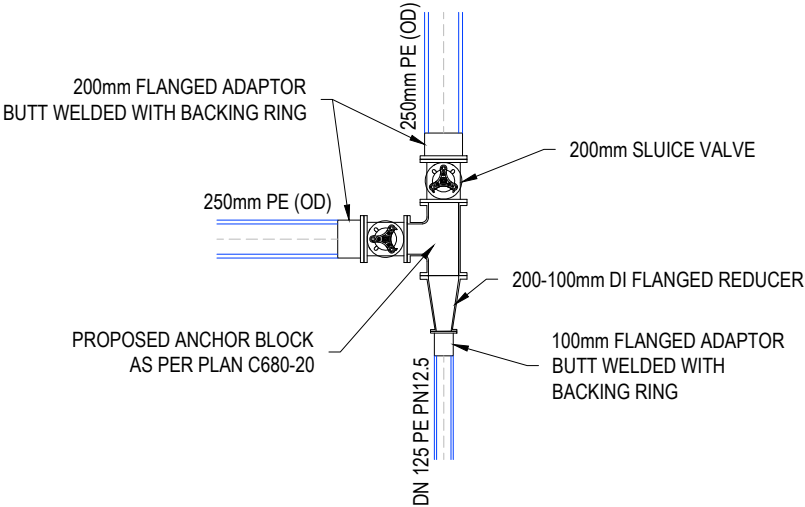


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SCALE 1:50 @ A3

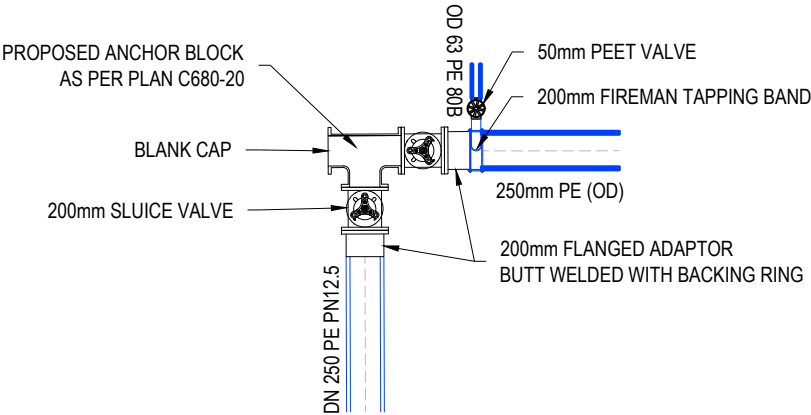

CONNECTION DETAIL 30  
SCALE 1:50 @ A3

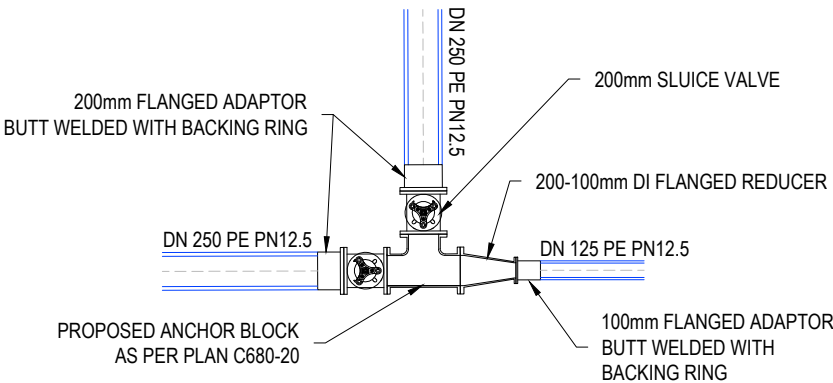

CONNECTION DETAIL 31  
SCALE 1:50 @ A3

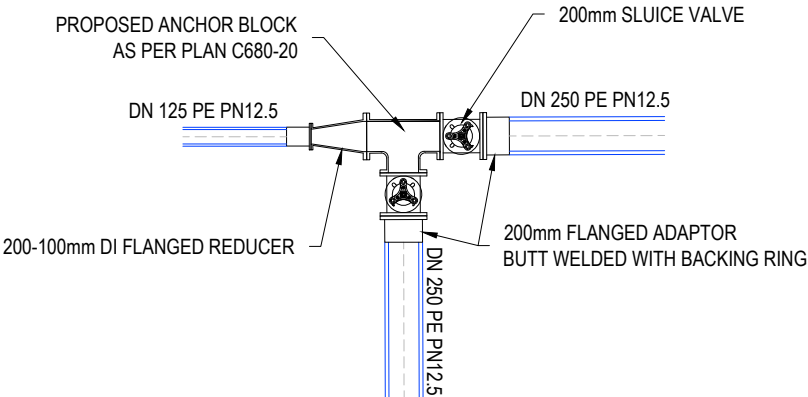

CONNECTION DETAIL 32  
SCALE 1:50 @ A3

- NOTES
1. ALL WORKS TO BE IN ACCORDANCE WITH REGIONAL INFRASTRUCTURE TECHNICAL SPECIFICATIONS (RITS).
  2. CO-ORDINATES IN TERMS OF NZ GEODETIC DATUM MOUNT EDEN 2000.
  3. LEVELS IN TERMS OF THE NEW ZEALAND VERTICAL DATUM 2016.
  5. STUB FLANGE, BACKING RING AND STUB TO BE WELDED TO PE PIPE.
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  7. REFER TO C600 SERIES DRAWINGS FOR WATER SUPPLY LAYOUT DRAWINGS.

D	FAST TRACK APP	MKS	06/2025
C	FAST TRACK APP	MKS	05/2025
B	FAST TRACK APP	TCH	04/2025
A	FAST TRACK APP	TCH	04/2025
Rev	Description	By	Date
		By	Date
Survey	MAVEN		03/2024
Design	TCH		04/2025
Drawn	TCH		04/2025
Checked	DJM		06/2025

**M** **A** **E** **N** **Maven Waikato**  
07 242 0601  
info@maven.co.nz  
www.maven.co.nz  
Level 1 286 Victoria Street, Hamilton  
New Zealand

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FOR  
MATAMATA  
DEVELOPMENTS LTD**



Title  
**PROPOSED  
WATER SUPPLY DETAILS  
SHEET 4 OF 4**

Project no.	289001		
Scale	AS SHOWN		
Cad file	C600-WATERSUPPLY.DWG		
Drawing no.	C650-4	Rev	D

Notes :



1. Thrust block dimensions for firm soil conditions.
2. The dimensions to be increased or decreased for variation in soil conditions.
3. Allowable bearing stress used - 100KPa.
4. Internal pipe test pressure up to 1400KPa.
5. As built locations to be obtained prior to backfill.
6. Protective membrane ( Polythene ) between concrete & pipe.
7. 75mm clearance between fittings/flanges and concrete casting.
8. All fittings to be Denso wrapped to the product specification. ( Butyl system for Plastic pipes )

Dia. mm	Dimension		
	A	B	C
100	670	250	450
150	1250	300	450
200	1500	450	550
250	1750	600	600

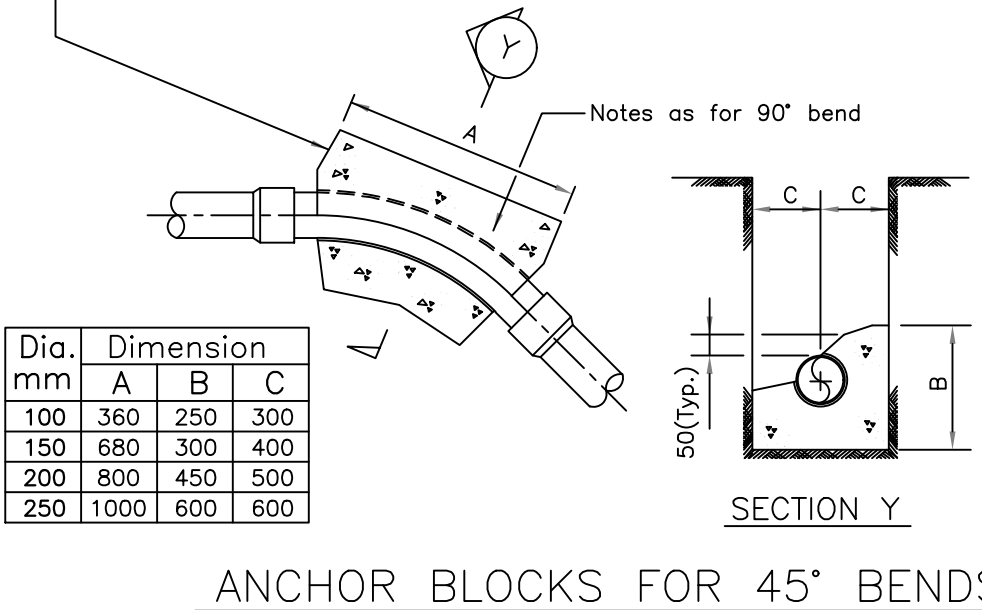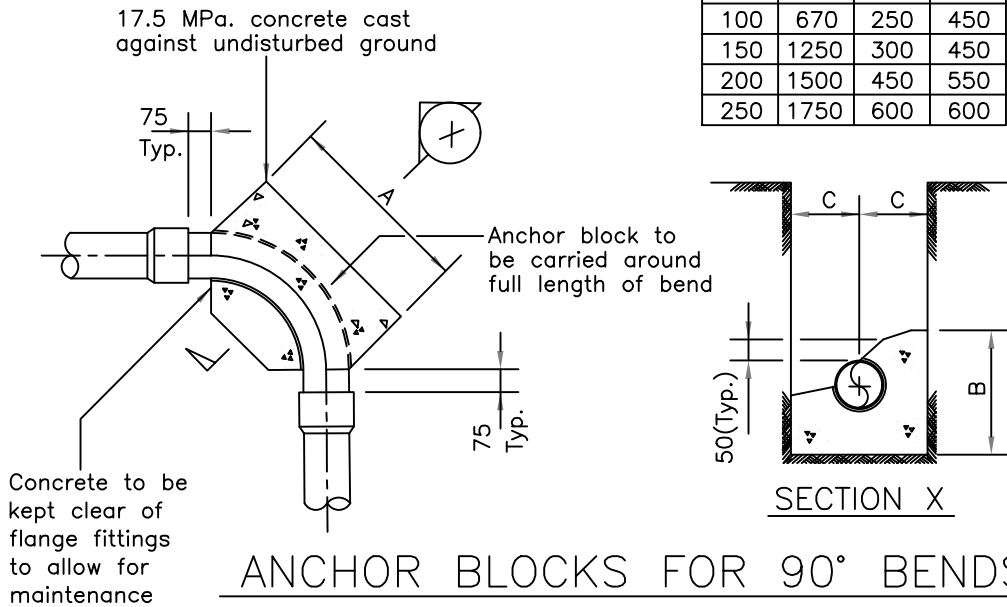

Notes :

1. Thrust block dimensions for firm soil conditions.
2. The dimensions to be increased or decreased for variation in soil conditions.
3. Allowable bearing stress used - 100KPa.
4. Internal pipe test pressure up to 1400KPa.
5. As built locations to be obtained prior to backfill.
6. Protective membrane ( Polythene ) between concrete & pipe.
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- NOTES
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  3. LEVELS IN TERMS OF THE NEW ZEALAND VERTICAL DATUM 2016.
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  7. REFER TO C600 SERIES DRAWINGS FOR WATER SUPPLY LAYOUT DRAWINGS.

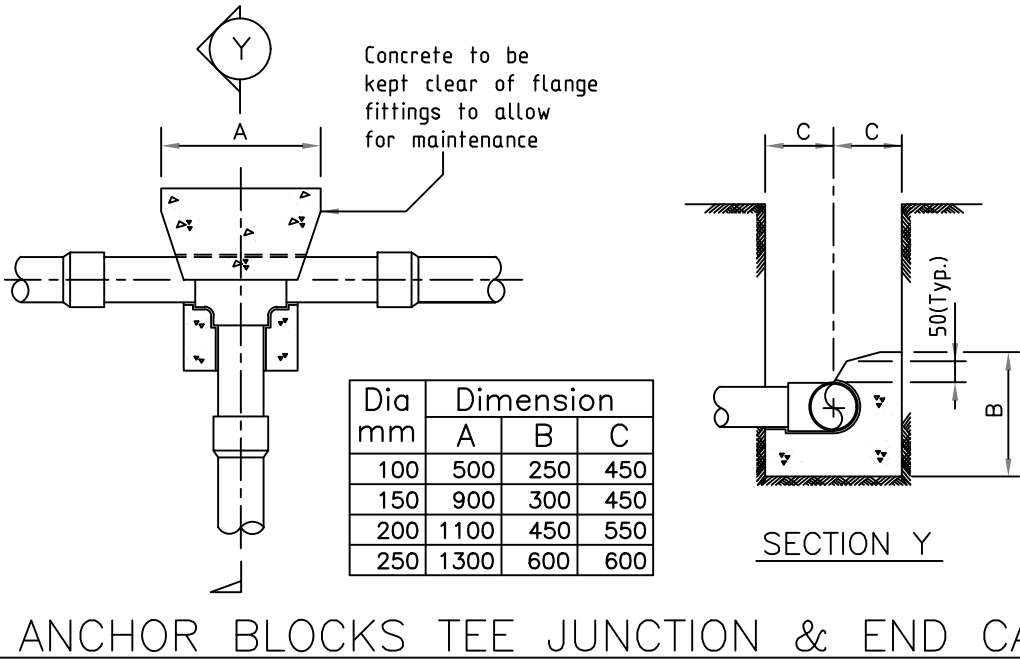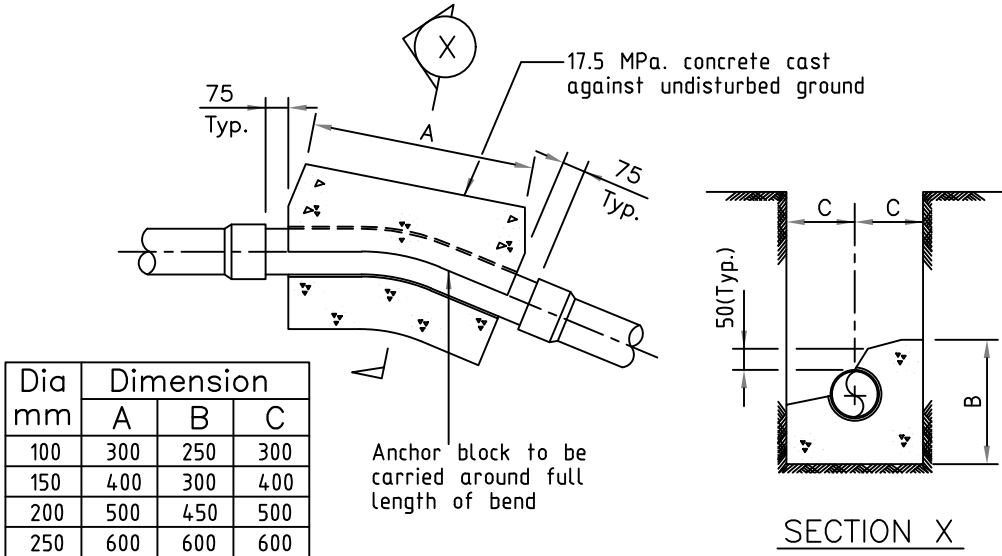C	FAST TRACK APP	MKS	05/2025
B	FAST TRACK APP	TCH	04/2025
A	FAST TRACK APP	TCH	04/2025
Rev	Description	By	Date
		By	Date
Survey	MAVEN		03/2024
Design	TCH		04/2025
Drawn	TCH		04/2025
Checked	DJM		06/2025




Project  
**ASHBOURNE  
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DEVELOPMENTS LTD**

Title  
**PROPOSED  
WATER SUPPLY  
ANCHOR BLOCK DETAILS**

Project no.	289001
Scale	AS SHOWN
Cad file	C600-WATERSUPPLY.DWG
Drawing no.	C680-20
Rev	C



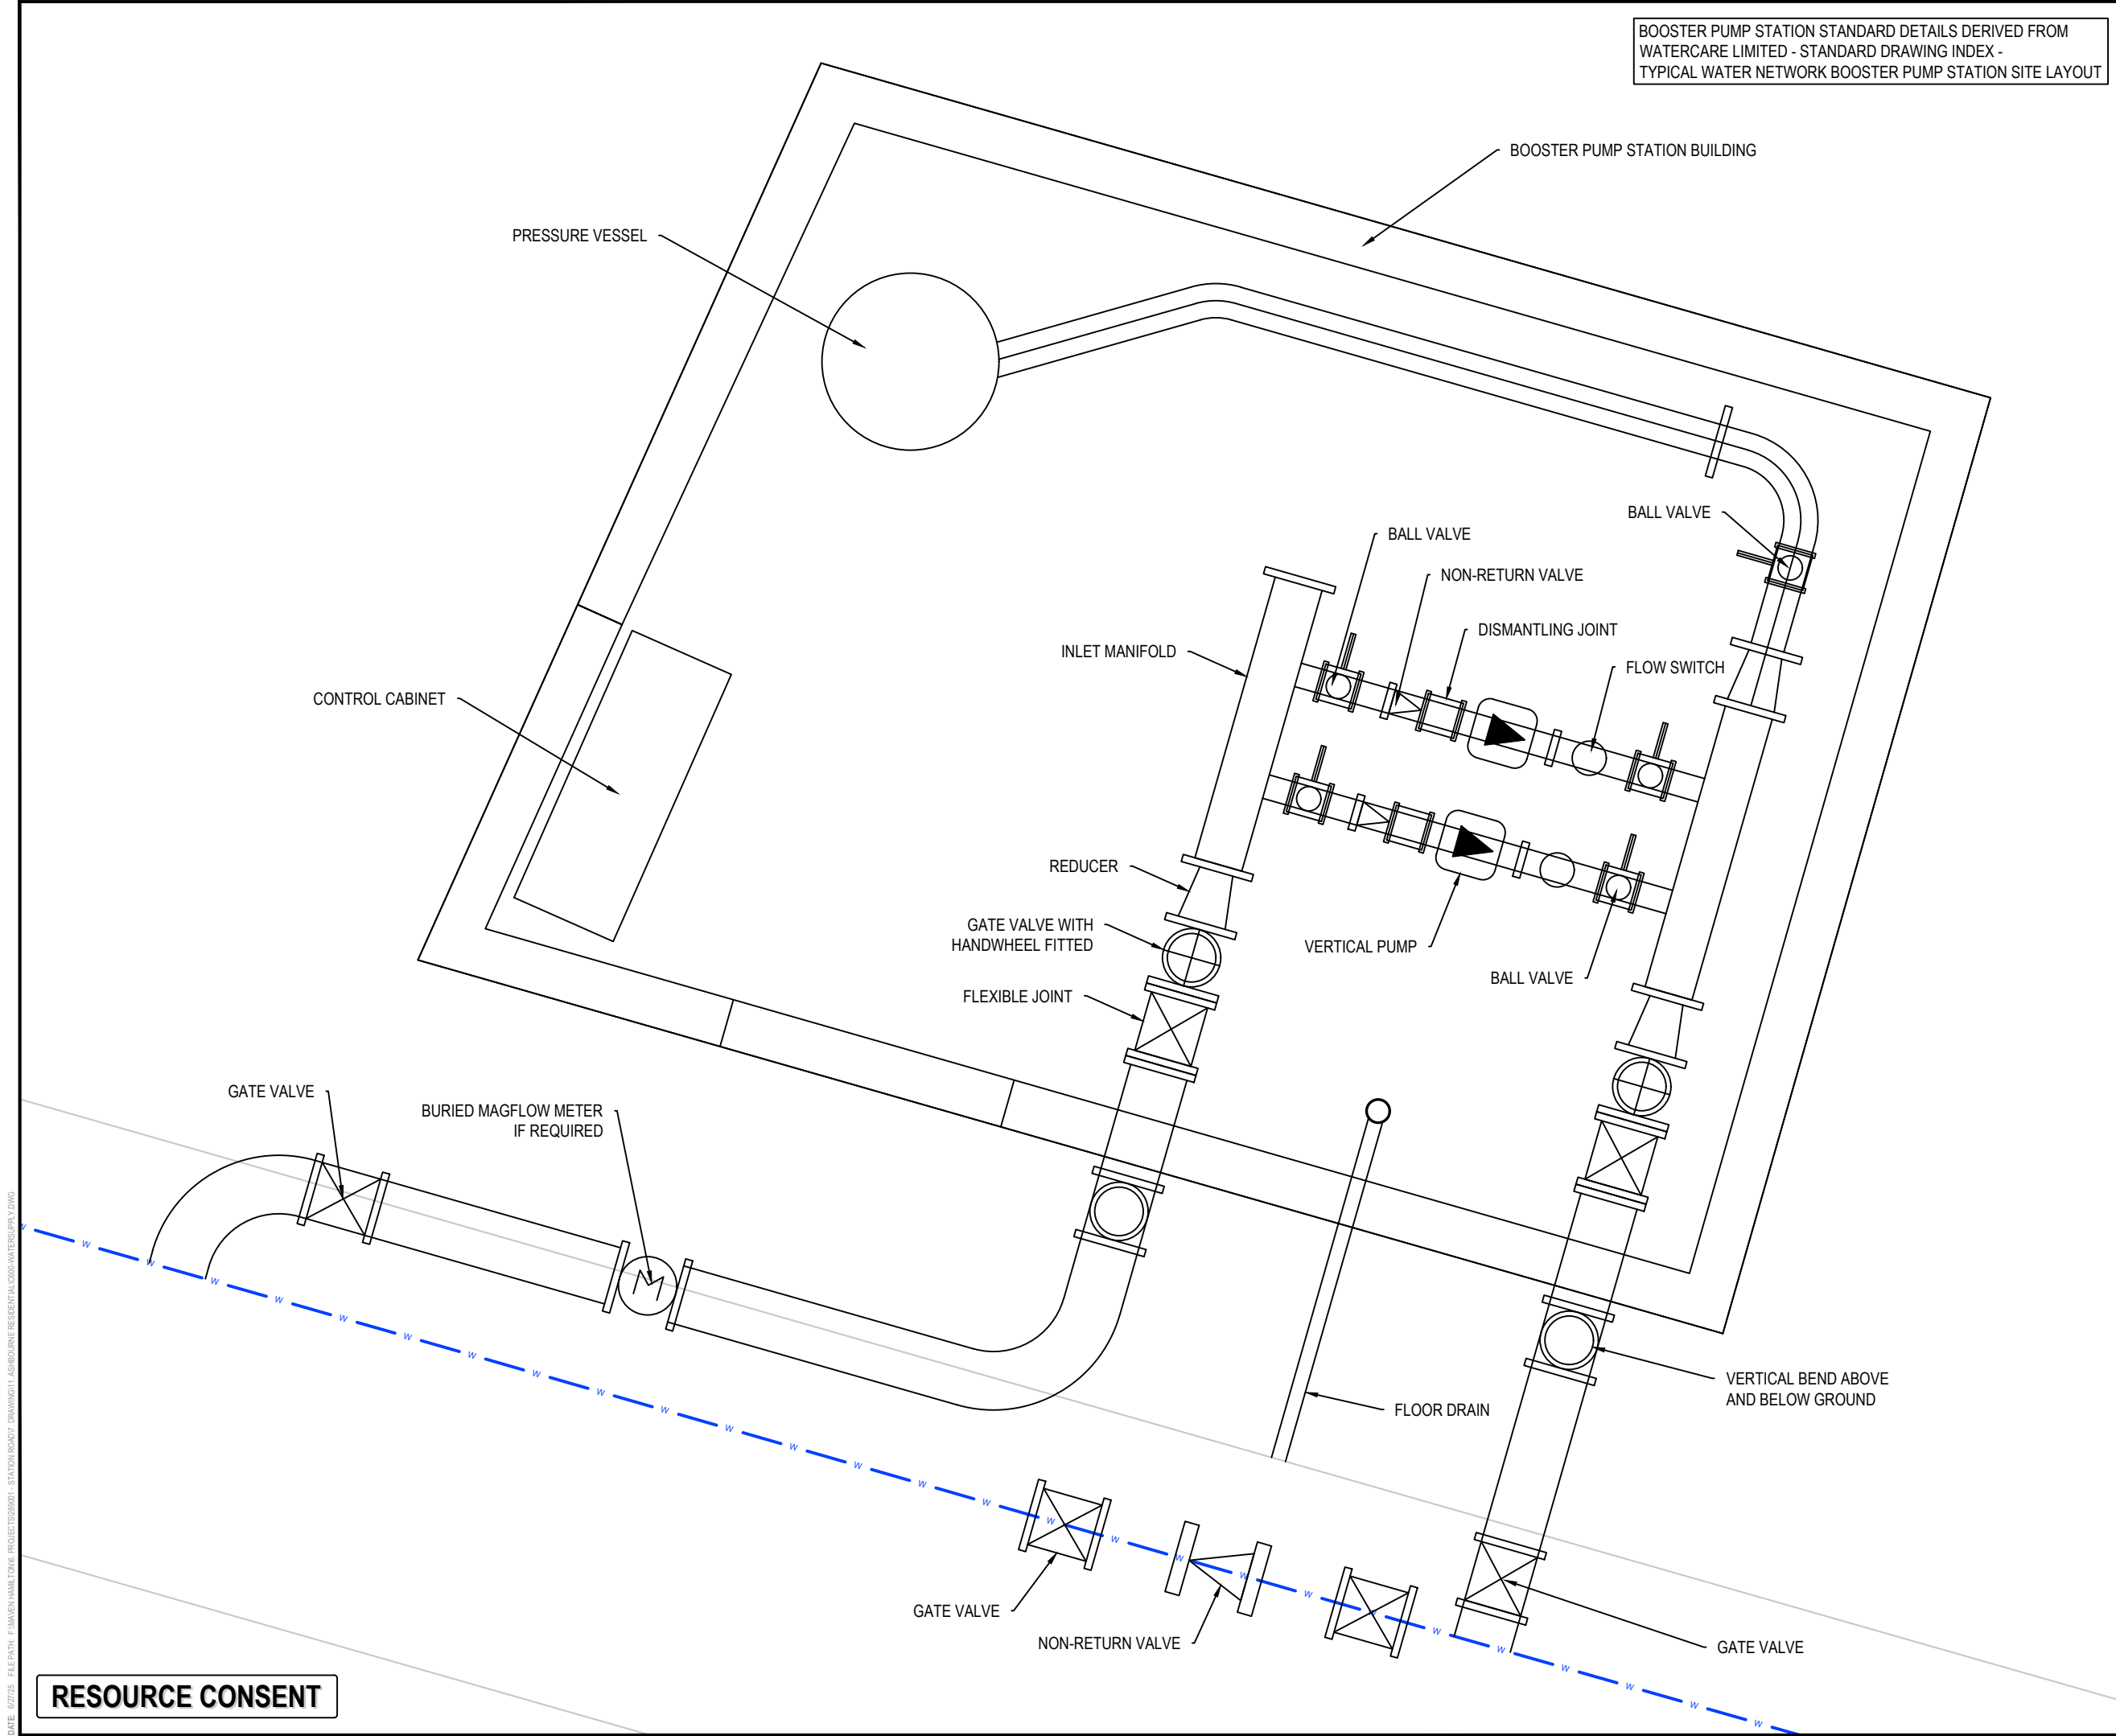

BOOSTER PUMP STATION STANDARD DETAILS DERIVED FROM WATERCARE LIMITED - STANDARD DRAWING INDEX - TYPICAL WATER NETWORK BOOSTER PUMP STATION SITE LAYOUT

- NOTES
1. SITE BUILDING AESTHETICS SHALL BE MANAGED WITH PLANTING AND BE IN ACCORDANCE WITH THE PUMP STATION RESOURCE CONSENT CONDITIONS.
  2. THE PUMP STATION SITE SHALL BE MADE LEVEL TO ITS FULL EXTENT.
  3. SITE DRAINAGE SHALL ADEQUATELY DRAIN WATER FROM THE SITE AND THE PUMP STATION BUILDING.
  4. BURIED MAGFLOW METER IF REQUIRED WITH CLEARANCE FROM BENDS AND VALVES OF 9 X DIAMETER OF PIPE UP STREAM & 5 X DIAMETER OF PIPE DOWN STREAM.
  5. SITE MAY BE REQUIRED TO BE FULLY FENCED.
  6. SITE PARKING REQUIRED WHERE OFF-SITE PARKING IS NOT AVAILABLE.
  7. FOR BOOSTER PUMP STATIONS WITH PUMP MANIFOLD < 32mm DIAMETER THE PUMPSET MAYBE LOCATED IN A CHAMBER.

A	FAST TRACK APP	MKS	06/2025
Rev	Description	By	Date
		By	Date
Survey	MAVEN		05/2024
Design	MKS		06/2025
Drawn	MKS		06/2025
Checked	DJM		06/2025

**M** Maven Waikato  
07 242 0601  
info@maven.co.nz  
www.maven.co.nz  
Level 1 286 Victoria Street, Hamilton  
New Zealand  
**M A V E N**

Project  
**ASHBOURNE  
RESIDENTIAL  
FOR  
MATAMATA  
DEVELOPMENTS LTD**

Title  
**PROPOSED  
WATER SUPPLY  
BOOSTER PS DETAILS**

Project no.	289001
Scale	1:25 @ A3
Cad file	C680-WATERSUPPLY.DWG
Drawing no.	C680-21
Rev	<b>A</b>

RESOURCE CONSENT



PROPOSED  
NORTHERN SOLAR FARM

C700-1  
STATION ROAD

C700-2

C700-3

BALANCE LOT

PROPOSED  
RETIREMENT VILLAGE

C700-4

C700-5

PROPOSED GREENWAY

C700-6

C700-7

C700-8

PROPOSED  
SOUTHERN SOLAR FARM

C700-9

C700-10

LOT 3 DP 463448

LOT 1 DP 463448

RESOURCE CONSENT

#### Notes

1. All works to be in accordance with Regional Infrastructure Technical Specification (RITS).
2. Co-ordinates in terms of NZ Geodetic Datum Mount Eden 2000.
3. Levels in terms of the New Zealand Vertical Datum 2016.
4. All ducts to be 100mm unless specified otherwise. Streetlight ducts to 50mm.
5. All road crossings to have 1.2m cover below finished levels unless specified otherwise.
6. Refer to drawing series C340 for Service Trench details.

#### Legend

- EX BOUNDARY
- EX BOUNDARY
- EX FIBRE
- EX WATER SUPPLY
- EX TELECOM
- PR INDICATIVE DRAFT HOUSE LAYOUT
- PR LOT & ROAD BDY
- PR BOUNDARY
- PR WATER SUPPLY
- PR TRENCH CROSSING
- PR BERM TRENCH TYPE 1
- PR BERM TRENCH TYPE 2
- FIRE HYDRANT
- EX/PR SLUICE VALVE
- EX/PR PEET VALVE
- PROP STREET LIGHT

E	FAST TRACK APP	GNT	11/2025
D	FAST TRACK APP	MKS	06/2025
C	FAST TRACK APP	MKS	05/2025
B	FAST TRACK APP	NDL	04/2025
Rev	Description	By	Date
Survey	MAVEN		05/2024
Design	WPJ		11/2024
Drawn	WPJ		11/2024
Checked	DJM		06/2025



Project  
**ASHBOURNE  
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FOR  
MATAMATA  
DEVELOPMENTS LTD**

Title  
**PROPOSED  
SERVICES  
OVERVIEW PLAN**

Project no.	289001		
Scale	1:6000 @ A3		
Cad file	C700-SERVICES.DWG		
Drawing no.	C700	Rev	E





WATER SUPPLY TO  
BE EXTENDED DOWN  
STATION ROAD BY OTHERS

LOT 1  
DP 404835

LV POWER TO BE EXTEND  
DURING STAGE 7 FOR THE  
CENTRAL WASTEWATER  
PUMP STATION

LOT 2  
DP 404835

APORO DRIVE

STATION ROAD

ODLUM DRIVE

LOT 1  
DP 365568

LOT 2  
DP 365568

ROAD 1

NORTHERN WASTEWATER PUMP STATION

STORMWATER  
WETLAND D

LOT 5  
DP 365568

#### Notes

1. All works to be in accordance with Regional Infrastructure Technical Specification (RITS).
2. Co-ordinates in terms of NZ Geodetic Datum Mount Eden 2000.
3. Levels in terms of the New Zealand Vertical Datum 2016.
4. All ducts to be 100mm unless specified otherwise. Streetlight ducts to 50mm.
5. All road crossings to have 1.2m cover below finished levels unless specified otherwise.

#### Legend

---	EX BOUNDARY
---	EX BOUNDARY
-F-	EX FIBRE
-W-	EX WATER SUPPLY
-T-	EX TELECOM
---	PR INDICATIVE DRAFT HOUSE LAYOUT
---	PR LOT & ROAD BDY
---	PR BOUNDARY
-W-	PR WATER SUPPLY
---	PR TRENCH CROSSING
---	PR BERM TRENCH
---	TYPE 1
---	PR BERM TRENCH
---	TYPE 2
---	FIRE HYDRANT
---	EX/PR SLUICE VALVE
---	EX/PR PEET VALVE
---	PROP STREET LIGHT

E	FAST TRACK APP	MKS	11/2025
D	FAST TRACK APP	MKS	06/2025
C	FAST TRACK APP	MKS	05/2025
B	FAST TRACK APP	NDL	04/2025
Rev	Description	By	Date
Survey	MAVEN		05/2024
Design	WPJ		11/2024
Drawn	WPJ		11/2024
Checked	DJM		06/2025




Project  
**ASHBOURNE  
RESIDENTIAL  
FOR  
MATAMATA  
DEVELOPMENTS LTD**

Title  
**PROPOSED  
SERVICES  
PLAN SHEET 1 OF 10**

Project no.	289001		
Scale	1:1000 @ A3		
Cad file	C700-SERVICES.DWG		
Drawing no.	C700-1	Rev	E

RESOURCE CONSENT

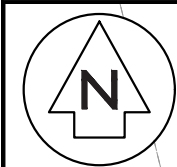

OLIVE PLACE

LOT 3  
DP 404835

LOT 9  
DP 562902

LOT 13  
DP 562902

LOT 14  
DP 562902

STORMWATER  
WETLAND C

ROAD 4

ROAD 4

- Notes
1. All works to be in accordance with Regional Infrastructure Technical Specification (RITS).
  2. Co-ordinates in terms of NZ Geodetic Datum Mount Eden 2000.
  3. Levels in terms of the New Zealand Vertical Datum 2016.
  4. All ducts to be 100mm unless specified otherwise. Streetlight ducts to 50mm.
  5. All road crossings to have 1.2m cover below finished levels unless specified otherwise.

Legend

---	---	EX BOUNDARY
---	---	EX BOUNDARY
-F-	-F-	EX FIBRE
-W-	-W-	EX WATER SUPPLY
-T-	-T-	EX TELECOM
- - -		PR INDICITIVE DRAFT HOUSE LAYOUT
---	---	PR LOT & ROAD BDY
---	---	PR BOUNDARY
-W-	-W-	PR WATER SUPPLY
---	---	PR TRENCH CROSSING
---	---	PR BERM TRENCH TYPE 1
---	---	PR BERM TRENCH TYPE 2
[FH]		FIRE HYDRANT
[SV]		EX/PR SLUICE VALVE
[PV]		EX/PR PEET VALVE
[SL]		PROP STREET LIGHT

E	FAST TRACK APP	MKS	11/2025
D	FAST TRACK APP	MKS	06/2025
C	FAST TRACK APP	MKS	05/2025
B	FAST TRACK APP	NDL	04/2025
Rev	Description	By	Date
		By	Date
Survey	MAVEN		05/2024
Design	WPJ		11/2024
Drawn	WPJ		11/2024
Checked	DJM		06/2025



**Maven Waikato**  
07 242 0601  
info@maven.co.nz  
www.maven.co.nz  
Level 1 286 Victoria Street, Hamilton  
New Zealand


Project  
**ASHBOURNE  
RESIDENTIAL  
FOR  
MATAMATA  
DEVELOPMENTS LTD**

Title  
**PROPOSED  
SERVICES  
PLAN SHEET 2 OF 10**

Project no.	289001		
Scale	1:1000 @ A3		
Cad file	C700-SERVICES.DWG		
Drawing no.	C700-2	Rev	E

RESOURCE CONSENT



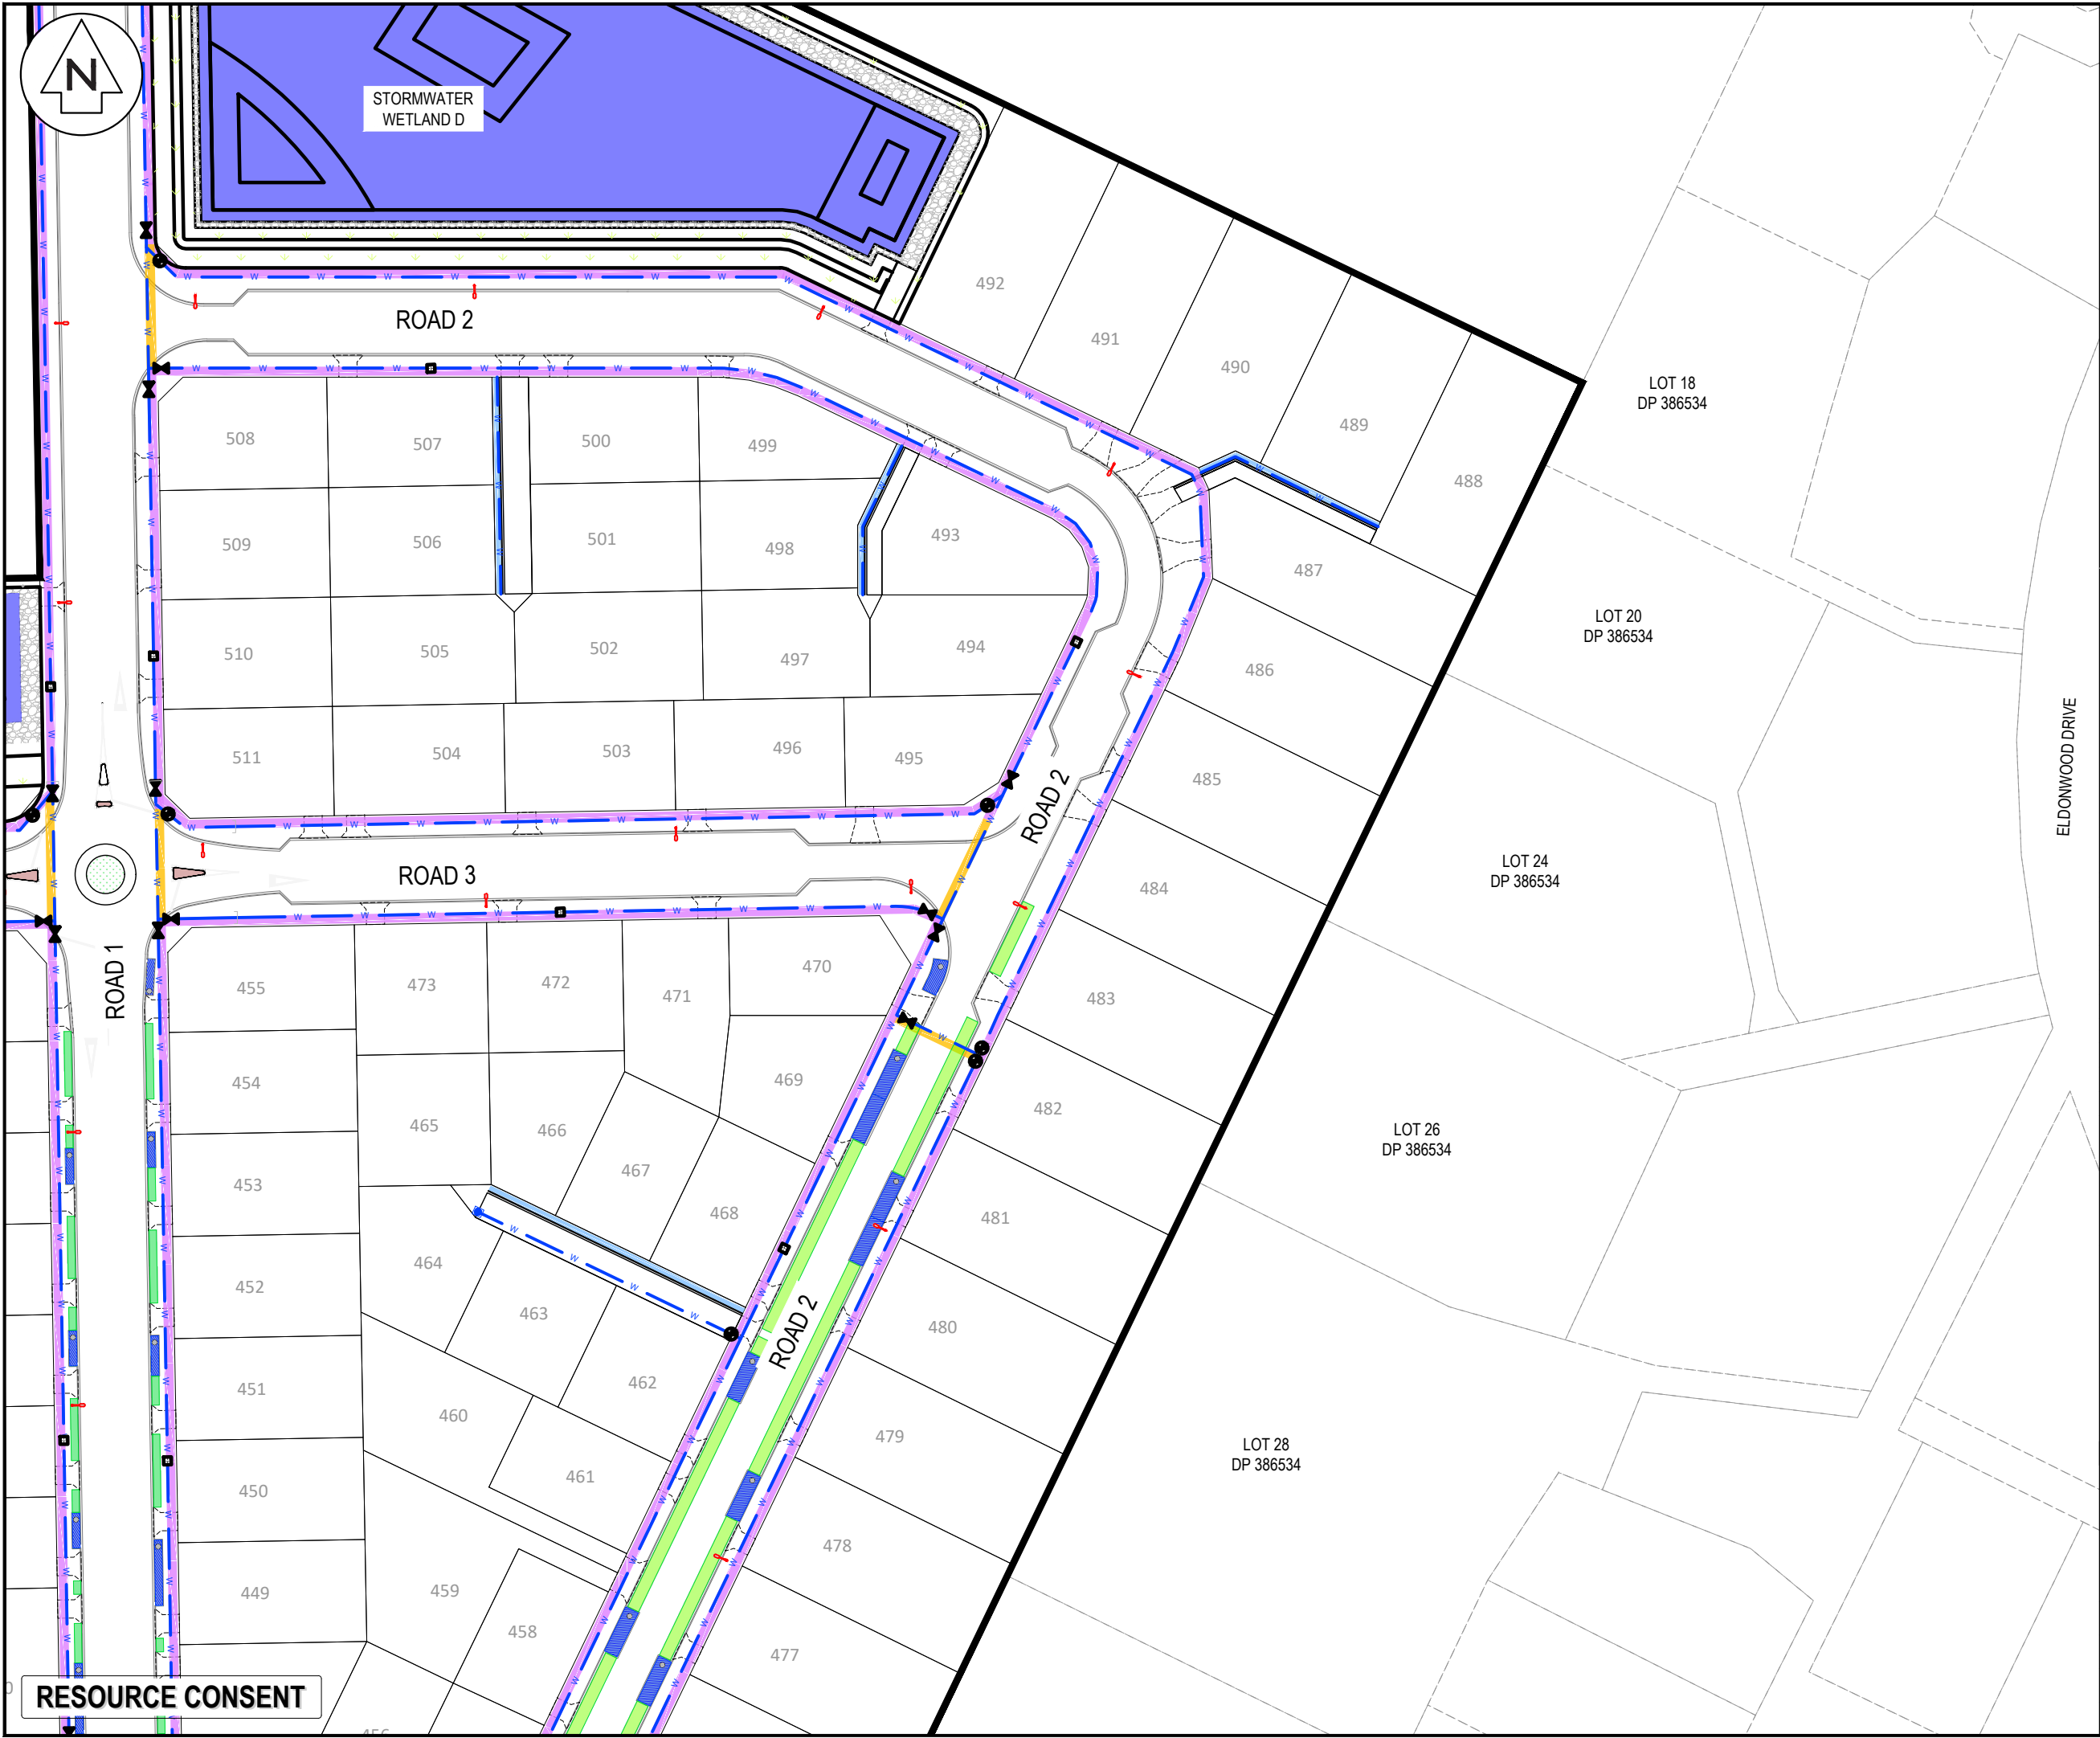

Notes

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Legend

—

EX BOUNDARY

—

EX BOUNDARY

— F

EX FIBRE

— w

EX WATER SUPPLY

— T

EX TELECOM

---

PR INDICITIVE DRAFT HOUSE LAYOUT

---

PR LOT & ROAD BDY

---

PR BOUNDARY

— w

PR WATER SUPPLY

—

PR TRENCH CROSSING

—

PR BERM TRENCH TYPE 1

—

PR BERM TRENCH TYPE 2

FIRE HYDRANT

EX/PR SLUICE VALVE

EX/PR PEET VALVE

PROP STREET LIGHT

E	FAST TRACK APP	MKS	11/2025
D	FAST TRACK APP	MKS	06/2025
C	FAST TRACK APP	MKS	05/2025
B	FAST TRACK APP	NDL	04/2025
Rev	Description	By	Date
		By	Date
Survey	MAVEN		05/2024
Design	WPJ		11/2024
Drawn	WPJ		11/2024
Checked	DJM		06/2025

Maven Waikato

07 242 0601

info@maven.co.nz

www.maven.co.nz

Level 1 286 Victoria Street, Hamilton

New Zealand

Project

**ASHBOURNE  
RESIDENTIAL  
FOR  
MATAMATA  
DEVELOPMENTS LTD**

Title

**PROPOSED  
SERVICES  
PLAN SHEET 3 OF 10**

Project no.	289001		
Scale	1:1000 @ A3		
Cad file	C700-SERVICES.DWG		
Drawing no.	C700-3	Rev	E

DATE: 11/11/25 FILEPATH: F:\MAVEN\HAMILTON\6 PROJECTS\289001 - STATION ROAD\7 DRAWING\11 ASHBOURNE RESIDENTIAL\C700-SERVICES.DWG

RESOURCE CONSENT



HIGHGROVE AVENUE

LOT 16  
DP 562902

LOT 17  
DP 562902

LOT 18  
DP 562902

LOT 2  
DP 21055

RESOURCE CONSENT

ROAD 2

ROAD 4

ROAD 5

ROAD 5

ROAD 6

ROAD 9

- Notes
1. All works to be in accordance with Regional Infrastructure Technical Specification (RITS).
  2. Co-ordinates in terms of NZ Geodetic Datum Mount Eden 2000.
  3. Levels in terms of the New Zealand Vertical Datum 2016.
  4. All ducts to be 100mm unless specified otherwise. Streetlight ducts to 50mm.
  5. All road crossings to have 1.2m cover below finished levels unless specified otherwise.

Legend

---	---	EX BOUNDARY
---	---	EX BOUNDARY
---	---	EX FIBRE
---	---	EX WATER SUPPLY
---	---	EX TELECOM
---	---	PR INDICATIVE DRAFT HOUSE LAYOUT
---	---	PR LOT & ROAD BDY
---	---	PR BOUNDARY
---	---	PR WATER SUPPLY
---	---	PR TRENCH CROSSING
---	---	PR BERM TRENCH TYPE 1
---	---	PR BERM TRENCH TYPE 2
---	---	FIRE HYDRANT
---	---	EX/PR SLUICE VALVE
---	---	EX/PR PEET VALVE
---	---	PROP STREET LIGHT

E	FAST TRACK APP	GNT	11/2025
D	FAST TRACK APP	MKS	06/2025
C	FAST TRACK APP	MKS	05/2025
B	FAST TRACK APP	NDL	04/2025
Rev	Description	By	Date
		By	Date
Survey	MAVEN		05/2024
Design	WPJ		11/2024
Drawn	WPJ		11/2024
Checked	DJM		06/2025


**M** Maven Waikato  
07 242 0601  
info@maven.co.nz  
www.maven.co.nz  
Level 1 286 Victoria Street, Hamilton  
New Zealand

Project  
**ASHBOURNE  
RESIDENTIAL  
FOR  
MATAMATA  
DEVELOPMENTS LTD**

Title  
**PROPOSED  
SERVICES  
PLAN SHEET 4 OF 10**

Project no.	289001
Scale	1:1000 @ A3
Cad file	C700-SERVICES.DWG
Drawing no.	C700-4
Rev	E

DATE: 11/11/25 FILEPATH: F:\MAVEN\HAMITONG6 PROJECTS\289001 - STATION ROAD\7. DRAWING\11. ASHBOURNE RESIDENTIAL\700-SERVICES.DWG

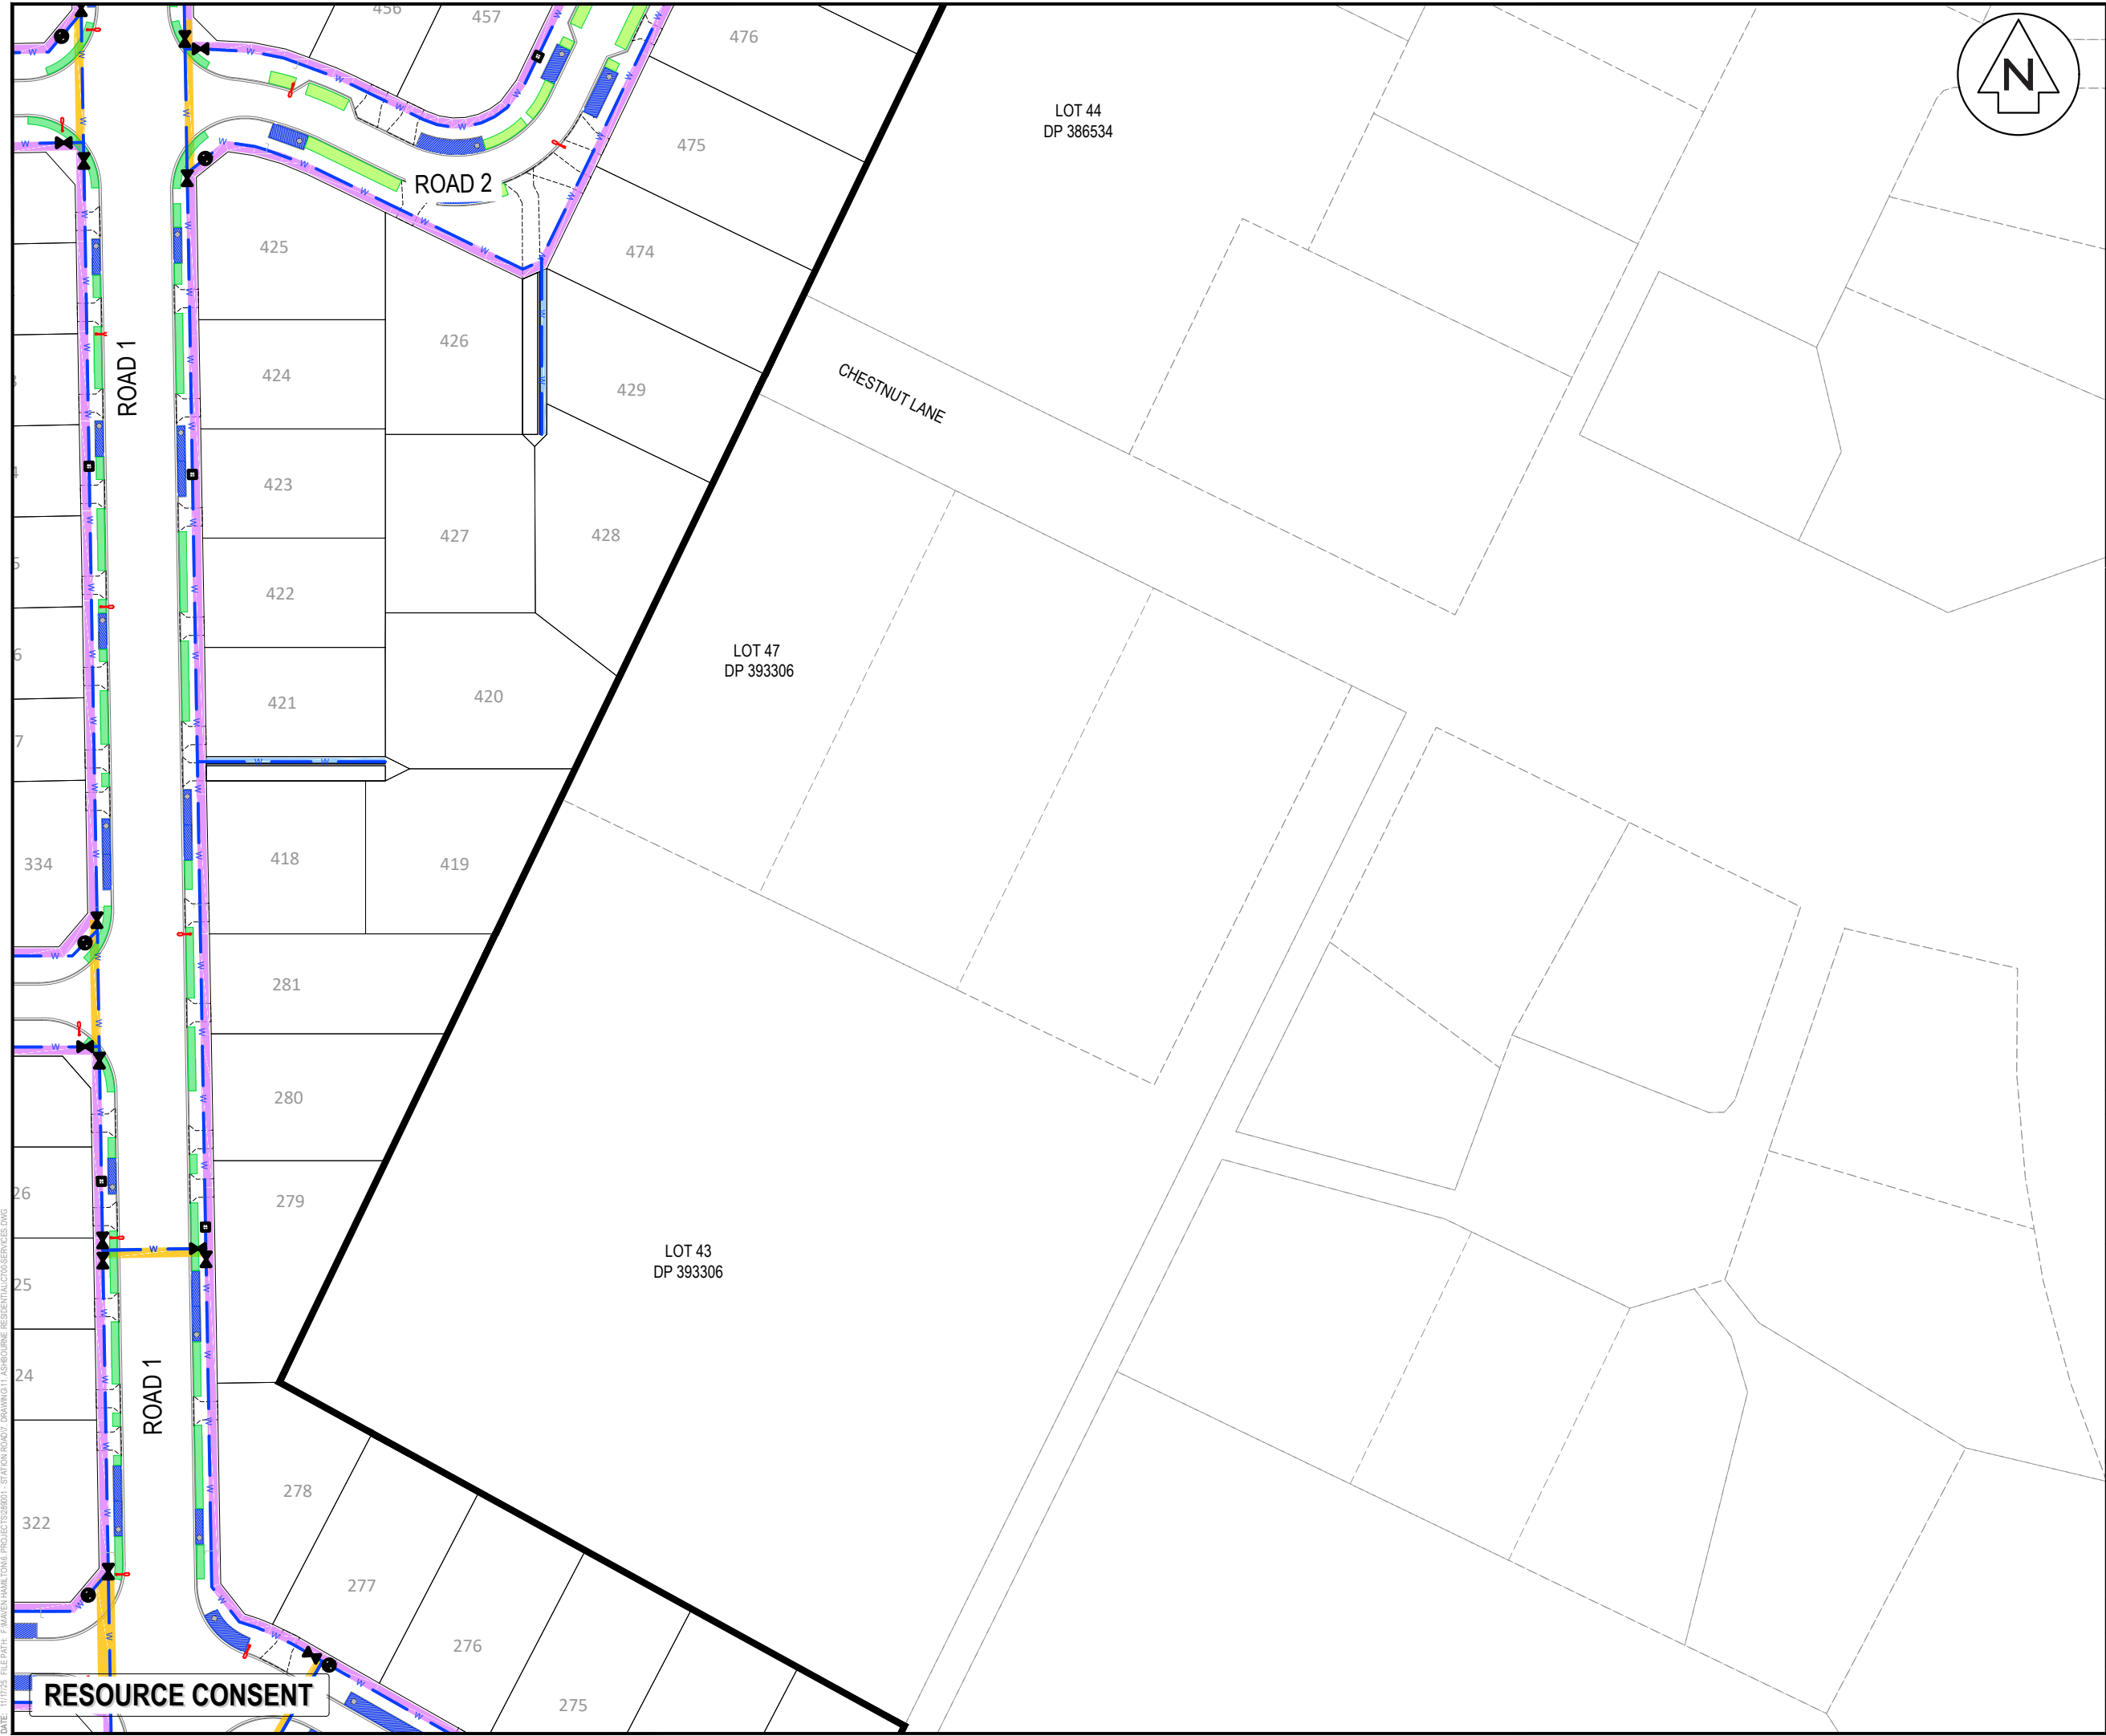

- Notes
1. All works to be in accordance with Regional Infrastructure Technical Specification (RITS).
  2. Co-ordinates in terms of NZ Geodetic Datum Mount Eden 2000.
  3. Levels in terms of the New Zealand Vertical Datum 2016.
  4. All ducts to be 100mm unless specified otherwise. Streetlight ducts to 50mm.
  5. All road crossings to have 1.2m cover below finished levels unless specified otherwise.

Legend

---	---	---	EX BOUNDARY
---	---	---	EX BOUNDARY
---	---	---	EX FIBRE
---	---	---	EX FIBRE
---	---	---	EX WATER SUPPLY
---	---	---	EX TELECOM
---	---	---	PR INDICITIVE DRAFT HOUSE LAYOUT
---	---	---	PR LOT & ROAD BDY
---	---	---	PR BOUNDARY
---	---	---	PR WATER SUPPLY
---	---	---	PR TRENCH CROSSING
---	---	---	PR BERM TRENCH TYPE 1
---	---	---	PR BERM TRENCH TYPE 2
---	---	---	FIRE HYDRANT
---	---	---	EX/PR SLUICE VALVE
---	---	---	EX/PR PEET VALVE
---	---	---	PROP STREET LIGHT

E	FAST TRACK APP	MKS	11/2025
D	FAST TRACK APP	MKS	06/2025
C	FAST TRACK APP	MKS	05/2025
B	FAST TRACK APP	NDL	04/2025
Rev	Description	By	Date
		By	Date
Survey	MAVEN		05/2024
Design	WPJ		11/2024
Drawn	WPJ		11/2024
Checked	DJM		06/2025



**Maven Waikato**  
07 242 0601  
info@maven.co.nz  
www.maven.co.nz  
Level 1 286 Victoria Street, Hamilton  
New Zealand

Project

**ASHBOURNE  
RESIDENTIAL  
FOR  
MATAMATA  
DEVELOPMENTS LTD**

Title


**PROPOSED  
SERVICES  
PLAN SHEET 5 OF 10**

Project no.	289001		
Scale	1:1000 @ A3		
Cad file	C700-SERVICES.DWG		
Drawing no.	C700-5	Rev	E

DATE: 11/11/25 FILEPATH: F:\MAVEN\HAMILTON\6 PROJECTS\289001 - STATION ROAD\7 DRAWING\11 ASHBORNE RESIDENTIAL\700-SERVICES.DWG

RESOURCE CONSENT



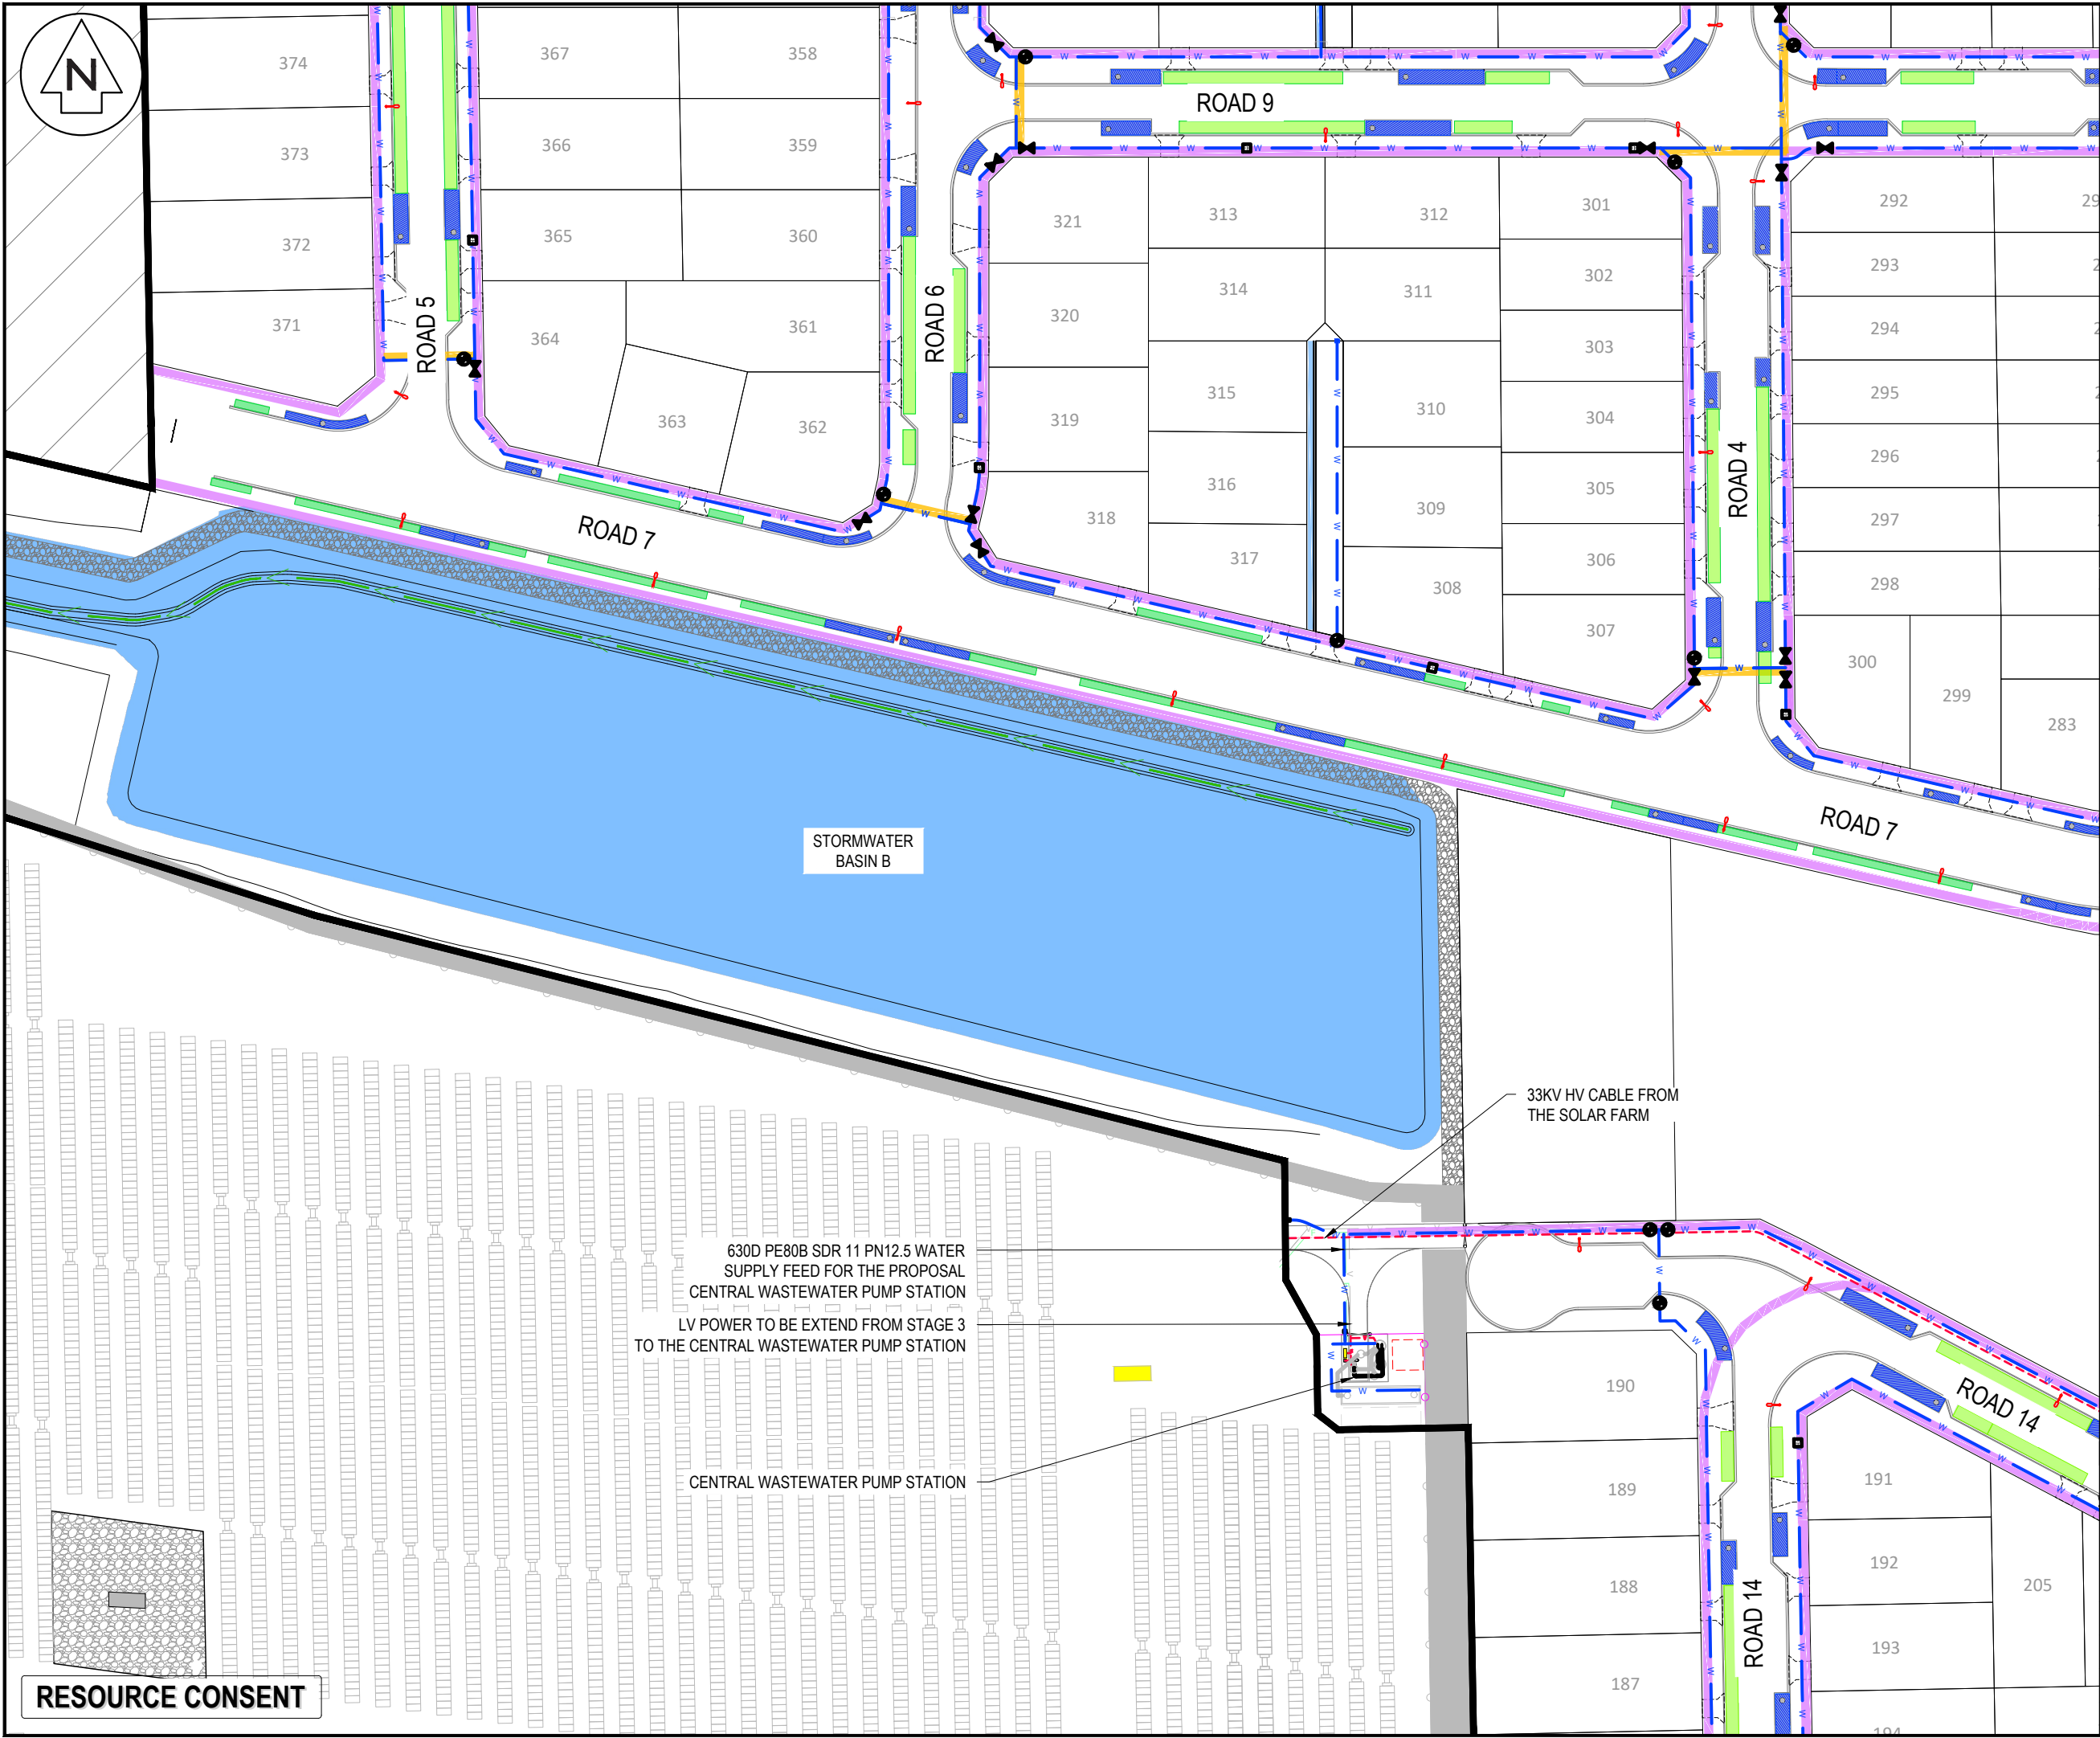

Notes

1. All works to be in accordance with Regional Infrastructure Technical Specification (RITS).
2. Co-ordinates in terms of NZ Geodetic Datum Mount Eden 2000.
3. Levels in terms of the New Zealand Vertical Datum 2016.
4. All ducts to be 100mm unless specified otherwise. Streetlight ducts to 50mm.
5. All road crossings to have 1.2m cover below finished levels unless specified otherwise.

Legend

---	EX BOUNDARY
---	EX BOUNDARY
---	EX FIBRE
---	EX WATER SUPPLY
---	EX TELECOM
---	PR INDICATIVE DRAFT HOUSE LAYOUT
---	PR LOT & ROAD BDY
---	PR BOUNDARY
---	PR WATER SUPPLY
---	PR TRENCH CROSSING
---	PR BERM TRENCH TYPE 1
---	PR BERM TRENCH TYPE 2
---	FIRE HYDRANT
---	EX/PR SLUICE VALVE
---	EX/PR PEET VALVE
---	PROP STREET LIGHT

E	FAST TRACK APP	MKS	11/2025
D	FAST TRACK APP	MKS	06/2025
C	FAST TRACK APP	MKS	05/2025
B	FAST TRACK APP	NDL	04/2025
Rev	Description	By	Date
		By	Date
Survey	MAVEN		05/2024
Design	WPJ		11/2024
Drawn	WPJ		11/2024
Checked	DJM		06/2025

**Maven Waikato**  
07 242 0601  
info@maven.co.nz  
www.maven.co.nz  
Level 1 286 Victoria Street, Hamilton  
New Zealand

Project

**ASHBOURNE  
RESIDENTIAL  
FOR  
MATAMATA  
DEVELOPMENTS LTD**

Title

**PROPOSED  
SERVICES  
PLAN SHEET 6 OF 10**

Project no.	289001		
Scale	1:1000 @ A3		
Cad file	C700-SERVICES.DWG		
Drawing no.	C700-6	Rev	E

DATE: 11/11/25 FILE PATH: F:\MAVEN\HAMILTON\6 PROJECTS\289001 - STATION ROAD\ DRAWING\11 ASHBOURNE RESIDENTIAL\700 SERVICES.DWG

RESOURCE CONSENT


630D PE80B SDR 11 PN12.5 WATER  
SUPPLY FEED FOR THE PROPOSAL  
CENTRAL WASTEWATER PUMP STATION

LV POWER TO BE EXTEND FROM STAGE 3  
TO THE CENTRAL WASTEWATER PUMP STATION

CENTRAL WASTEWATER PUMP STATION

33KV HV CABLE FROM  
THE SOLAR FARM



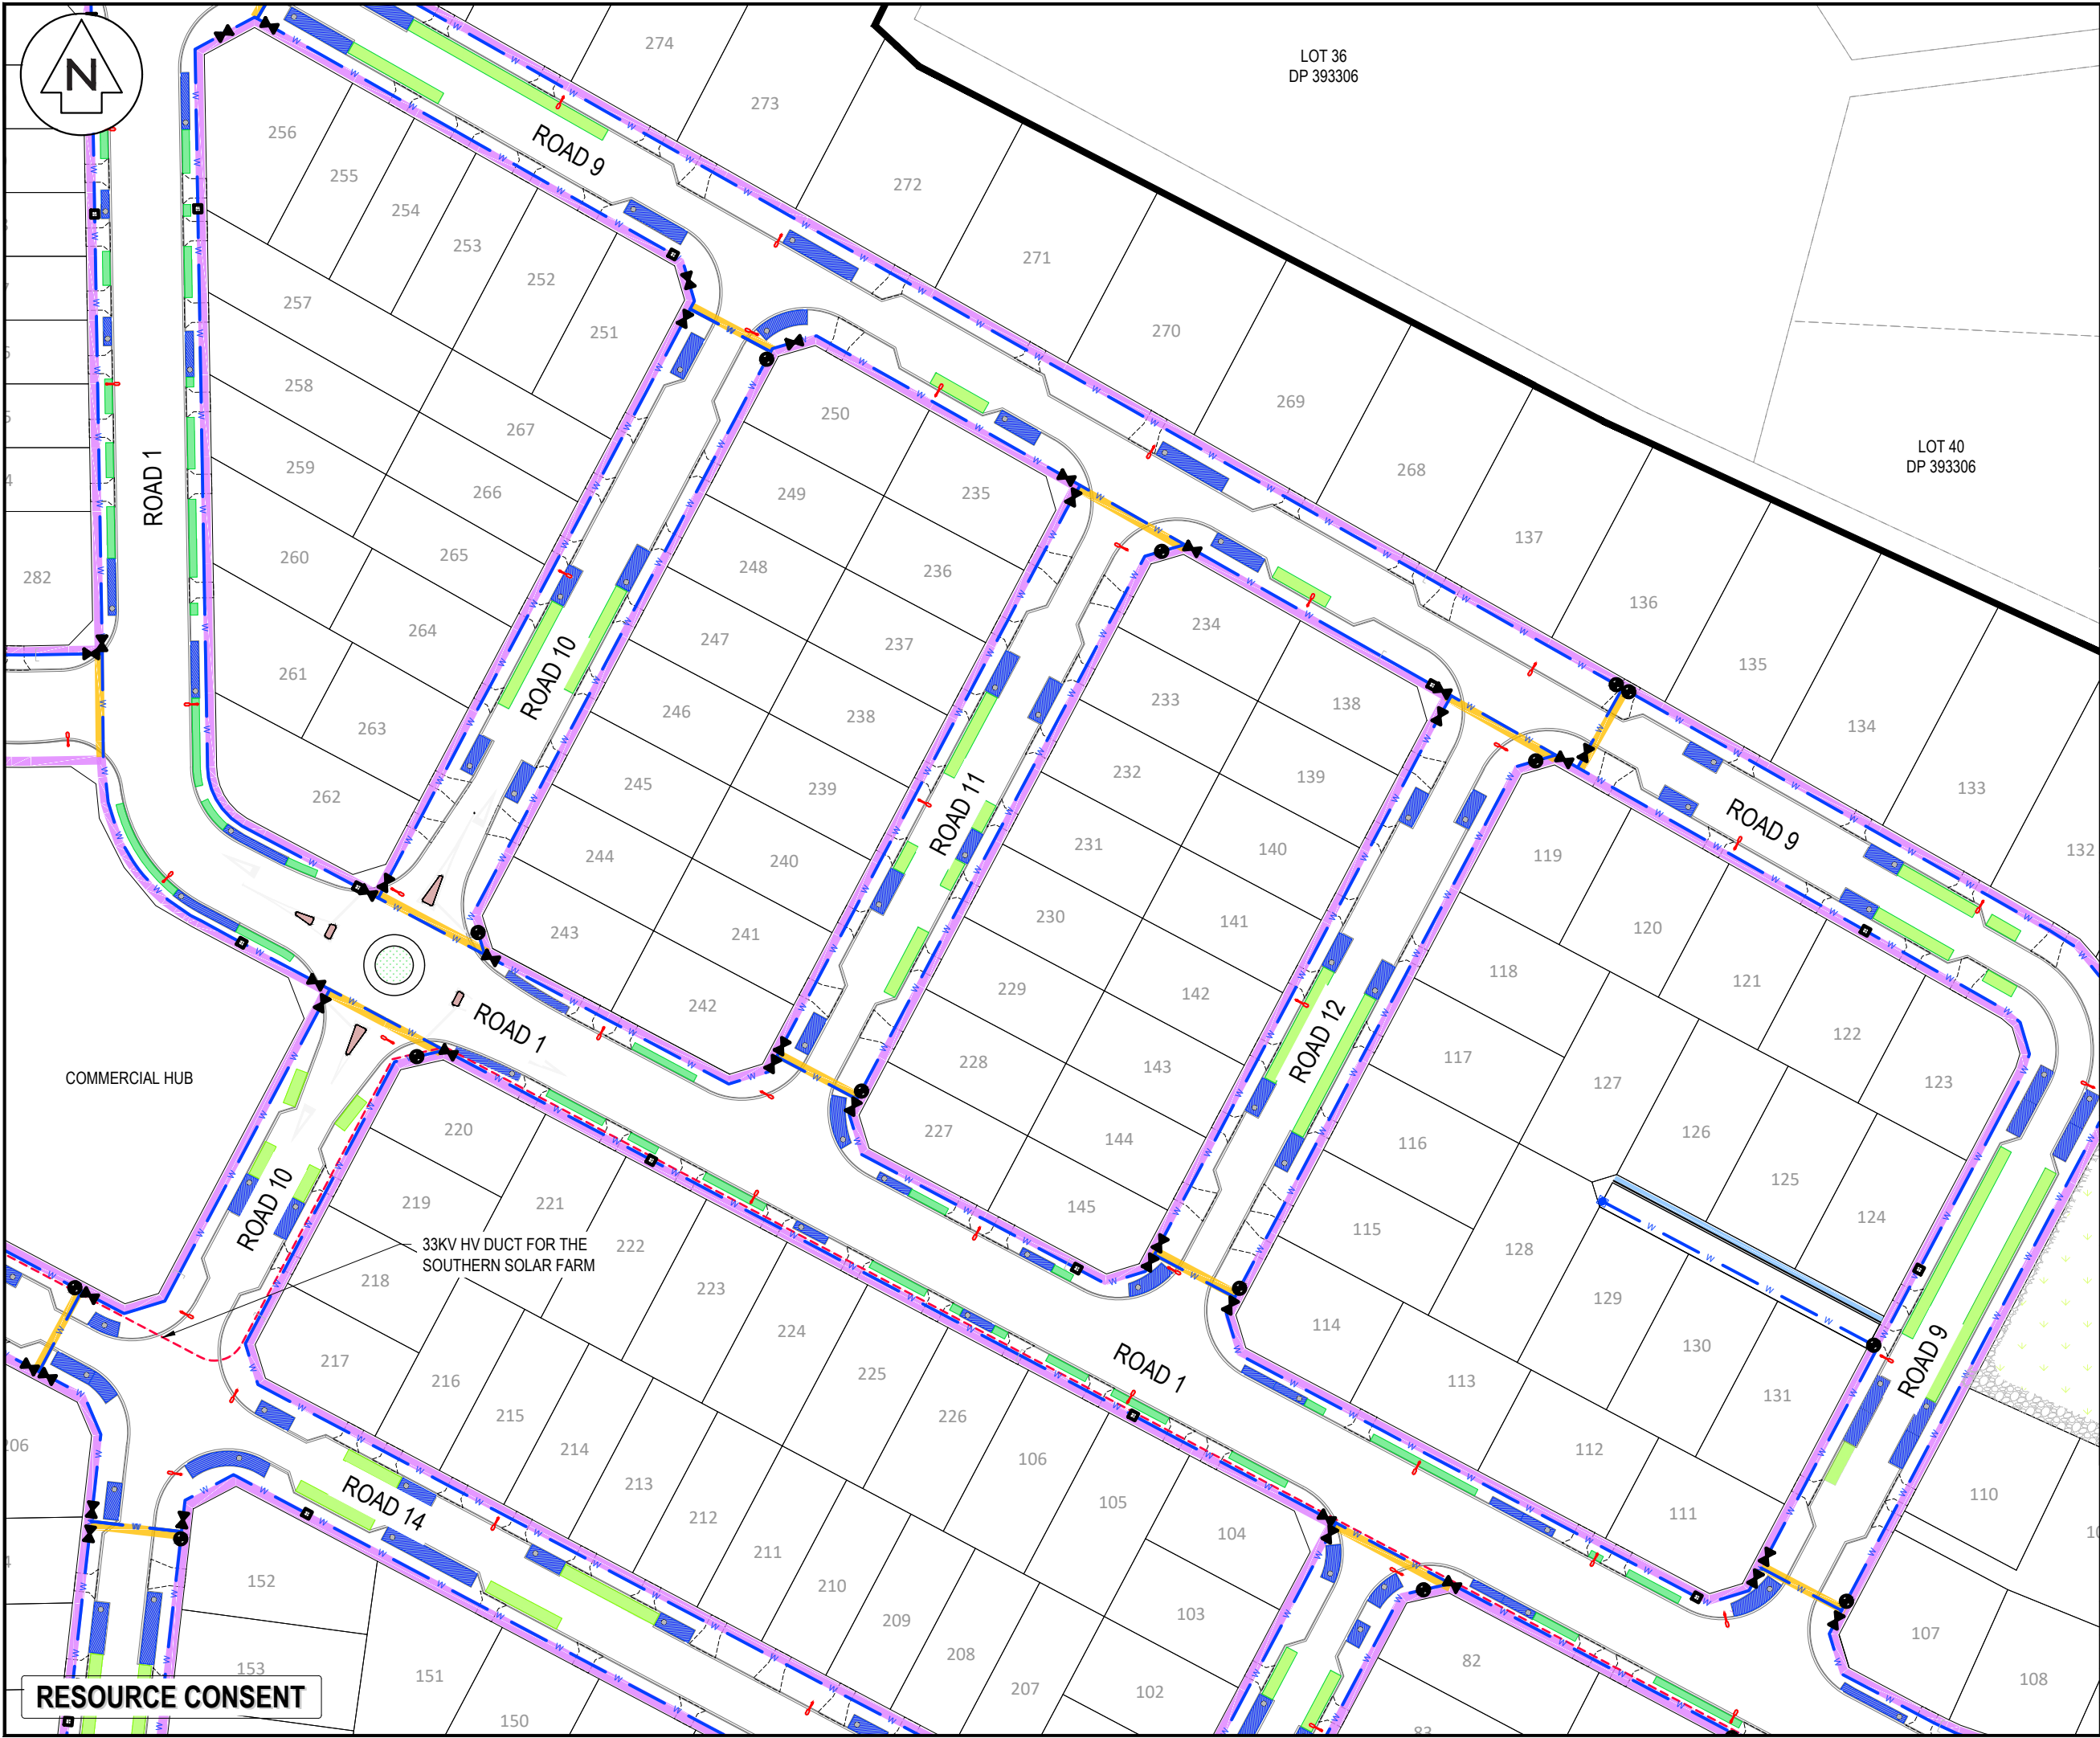

Notes

1. All works to be in accordance with Regional Infrastructure Technical Specification (RITS).
2. Co-ordinates in terms of NZ Geodetic Datum Mount Eden 2000.
3. Levels in terms of the New Zealand Vertical Datum 2016.
4. All ducts to be 100mm unless specified otherwise. Streetlight ducts to 50mm.
5. All road crossings to have 1.2m cover below finished levels unless specified otherwise.

Legend

—	EX BOUNDARY
—	EX BOUNDARY
— F —	EX FIBRE
— W —	EX WATER SUPPLY
— T —	EX TELECOM
---	PR INDICITIVE DRAFT HOUSE LAYOUT
---	PR LOT & ROAD BDY
---	PR BOUNDARY
— W —	PR WATER SUPPLY
—	PR TRENCH CROSSING
—	PR BERM TRENCH TYPE 1
—	PR BERM TRENCH TYPE 2
⊕	FIRE HYDRANT
⊗	EX/PR SLUICE VALVE
⊗	EX/PR PEET VALVE
⊗	PROP STREET LIGHT

E	FAST TRACK APP	GNT	11/2025
D	FAST TRACK APP	MKS	06/2025
C	FAST TRACK APP	MKS	05/2025
B	FAST TRACK APP	NDL	04/2025
Rev	Description	By	Date
		By	Date
Survey	MAVEN		05/2024
Design	WPJ		11/2024
Drawn	WPJ		11/2024
Checked	DJM		06/2025

**Maven Waikato**  
07 242 0601  
info@maven.co.nz  
www.maven.co.nz  
Level 1 286 Victoria Street, Hamilton  
New Zealand

Project


**ASHBOURNE  
RESIDENTIAL  
FOR  
MATAMATA  
DEVELOPMENTS LTD**

Title

**PROPOSED  
SERVICES  
PLAN SHEET 7 OF 10**

Project no.	289001		
Scale	1:1000 @ A3		
Cad file	C700-SERVICES.DWG		
Drawing no.	C700-7	Rev	E

DATE: 11/11/25 FILEPATH: F:\Maven\Hamilton\6 PROJECTS\289001 - STATION ROAD\DRAWING\11 ASHBOURNE RESIDENTIAL\700SERVICES.DWG

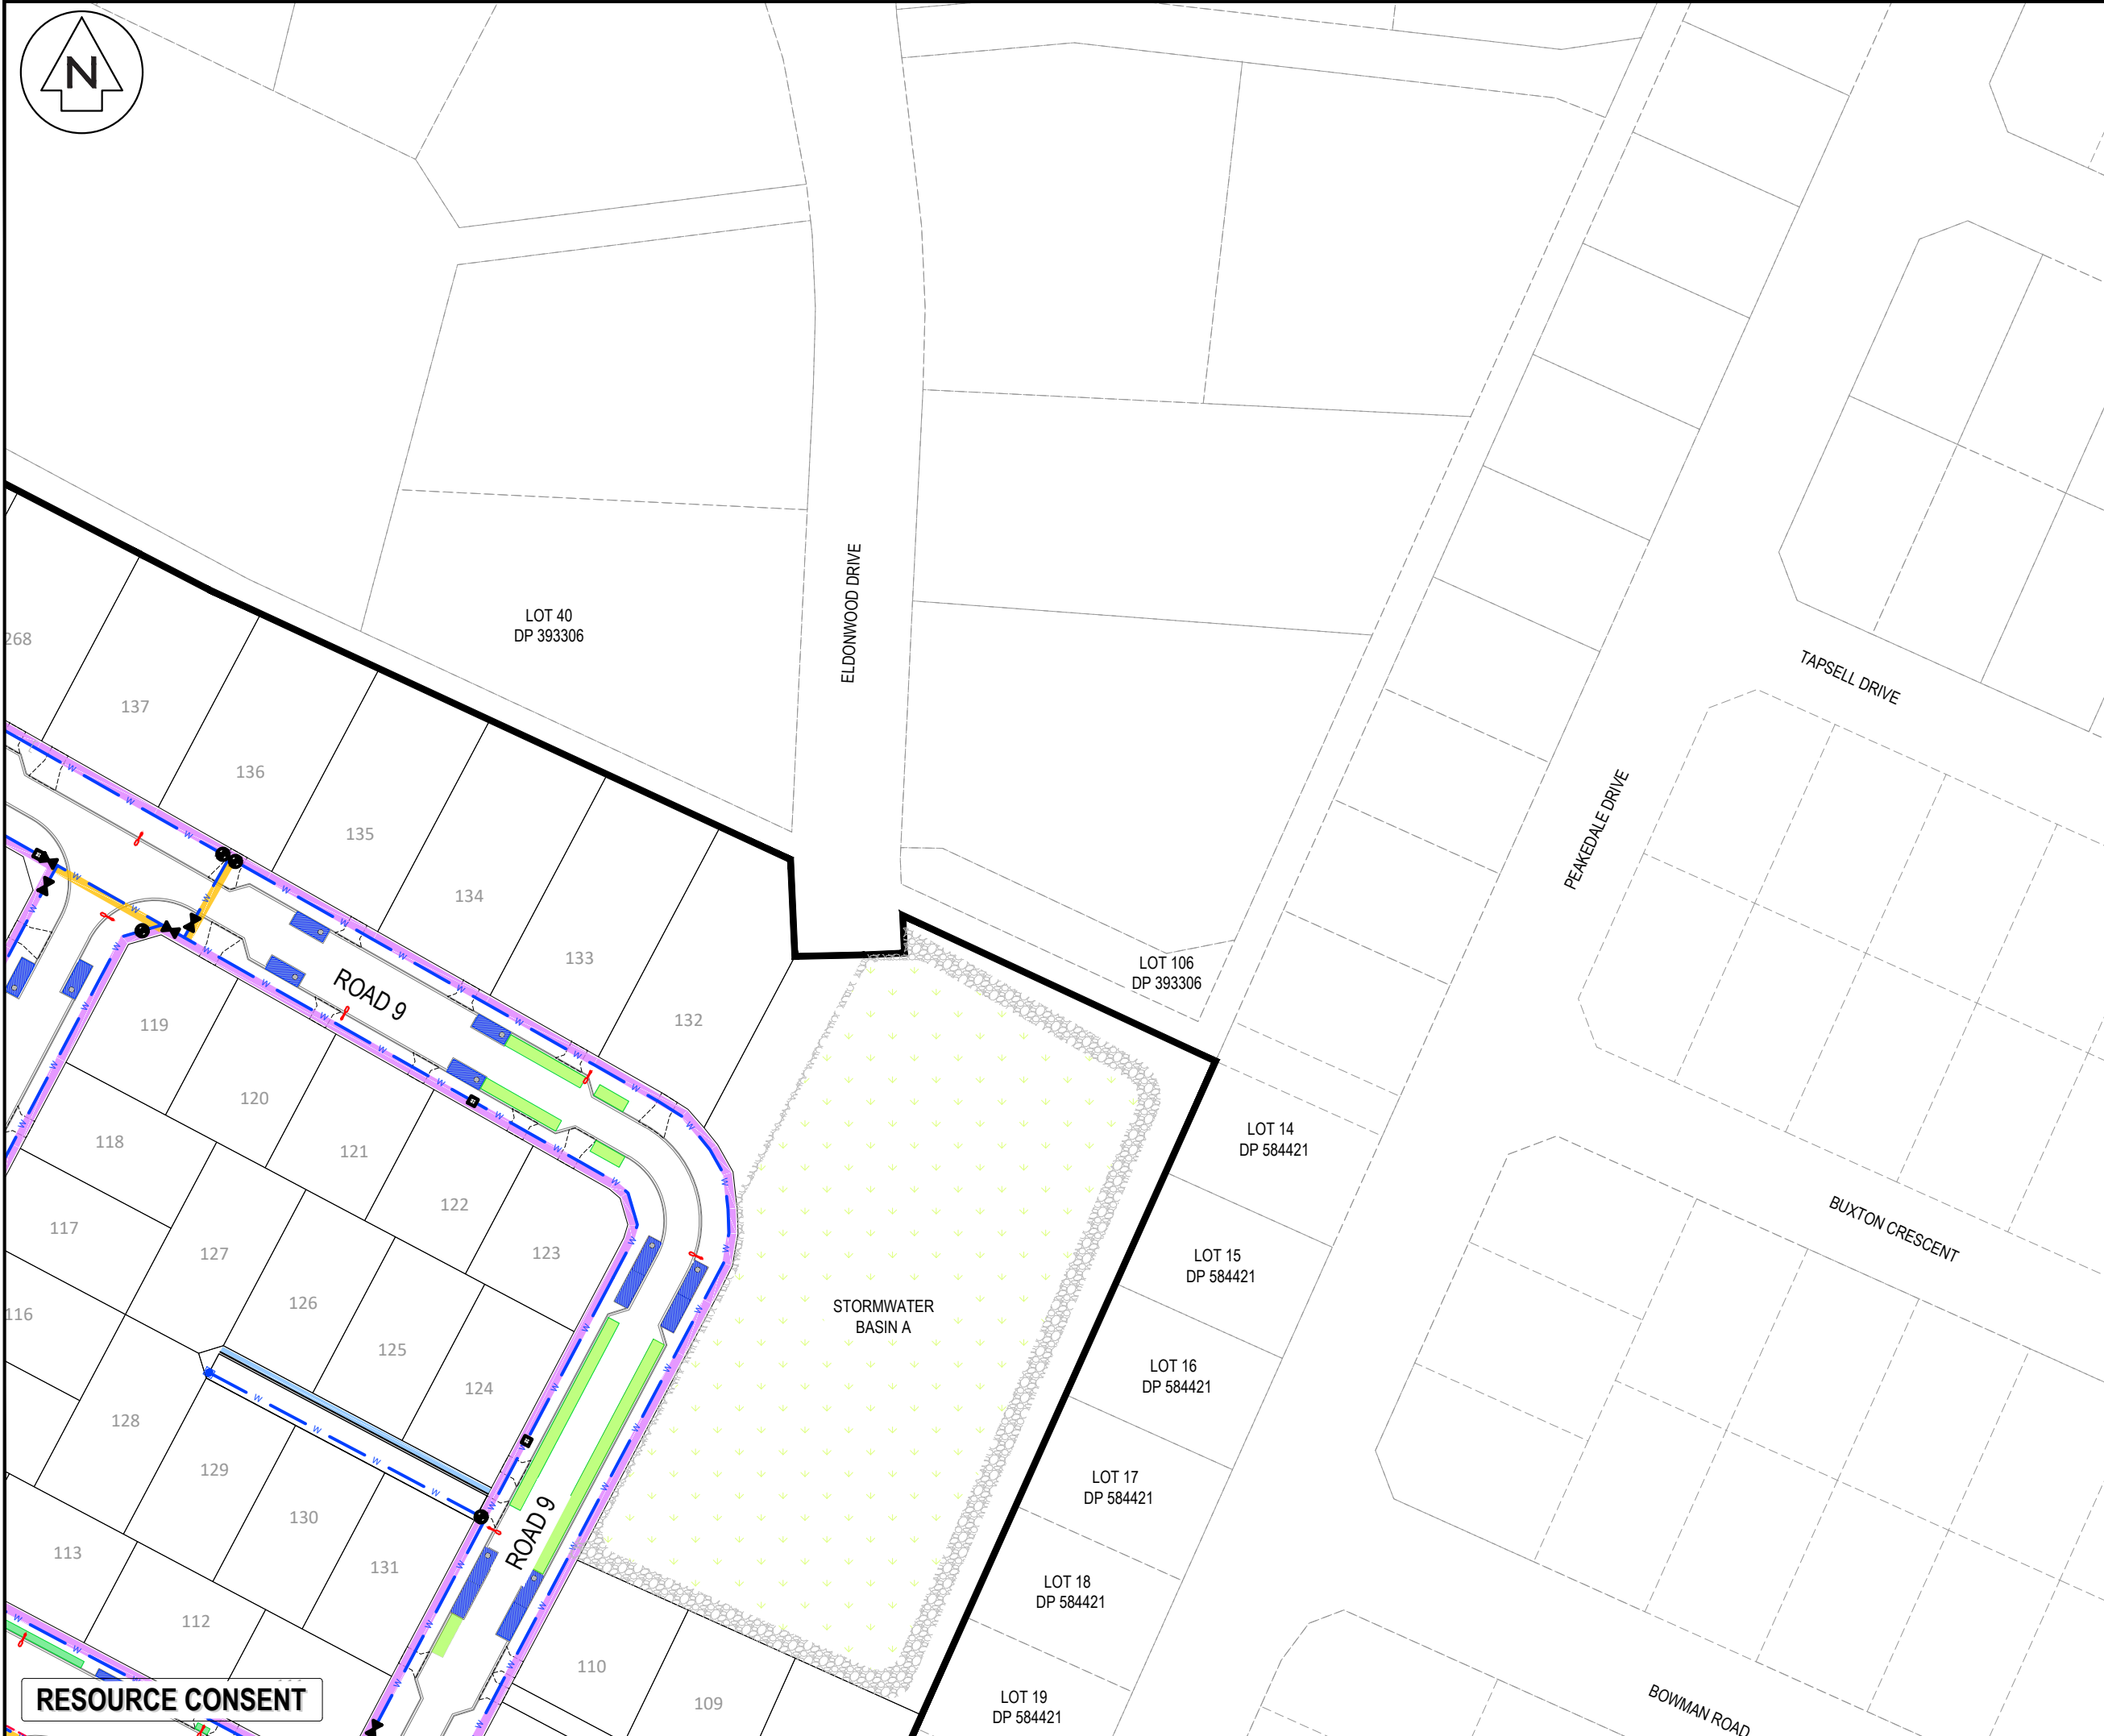

Notes

1. All works to be in accordance with Regional Infrastructure Technical Specification (RITS).
2. Co-ordinates in terms of NZ Geodetic Datum Mount Eden 2000.
3. Levels in terms of the New Zealand Vertical Datum 2016.
4. All ducts to be 100mm unless specified otherwise. Streetlight ducts to 50mm.
5. All road crossings to have 1.2m cover below finished levels unless specified otherwise.

Legend

---	---	---	---	---	---
---	---	---	---	---	---
F	F	F	F	F	F
W	W	W	W	W	W
T	T	T	T	T	T

PR INDICITIVE DRAFT HOUSE LAYOUT

PR LOT & ROAD BDY

PR BOUNDARY

PR WATER SUPPLY

PR TRENCH CROSSING

PR BERM TRENCH TYPE 1

PR BERM TRENCH TYPE 2

FIRE HYDRANT

EX/PR SLUICE VALVE

EX/PR PEET VALVE

PROP STREET LIGHT

E	FAST TRACK APP	GNT	11/2025
D	FAST TRACK APP	MKS	06/2025
C	FAST TRACK APP	MKS	05/2025
B	FAST TRACK APP	NDL	04/2025
Rev	Description	By	Date
		By	Date
Survey	MAVEN		05/2024
Design	WPJ		11/2024
Drawn	WPJ		11/2024
Checked	DJM		06/2025

**Maven Waikato**  
07 242 0601  
info@maven.co.nz  
www.maven.co.nz  
Level 1 286 Victoria Street, Hamilton  
New Zealand

Project

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RESIDENTIAL  
FOR  
MATAMATA  
DEVELOPMENTS LTD**


Title

**PROPOSED  
SERVICES  
PLAN SHEET 8 OF 10**

Project no.	289001		
Scale	1:1000 @ A3		
Cad file	C700-SERVICES.DWG		
Drawing no.	C700-8	Rev	E

DATE: 11/11/25 FILEPATH: F:\MAVEN\HAMILTON6 PROJECTS\289001 - STATION ROAD\ DRAWING\11. ASHBORNE RESIDENTIAL\0700SERVICES.DWG



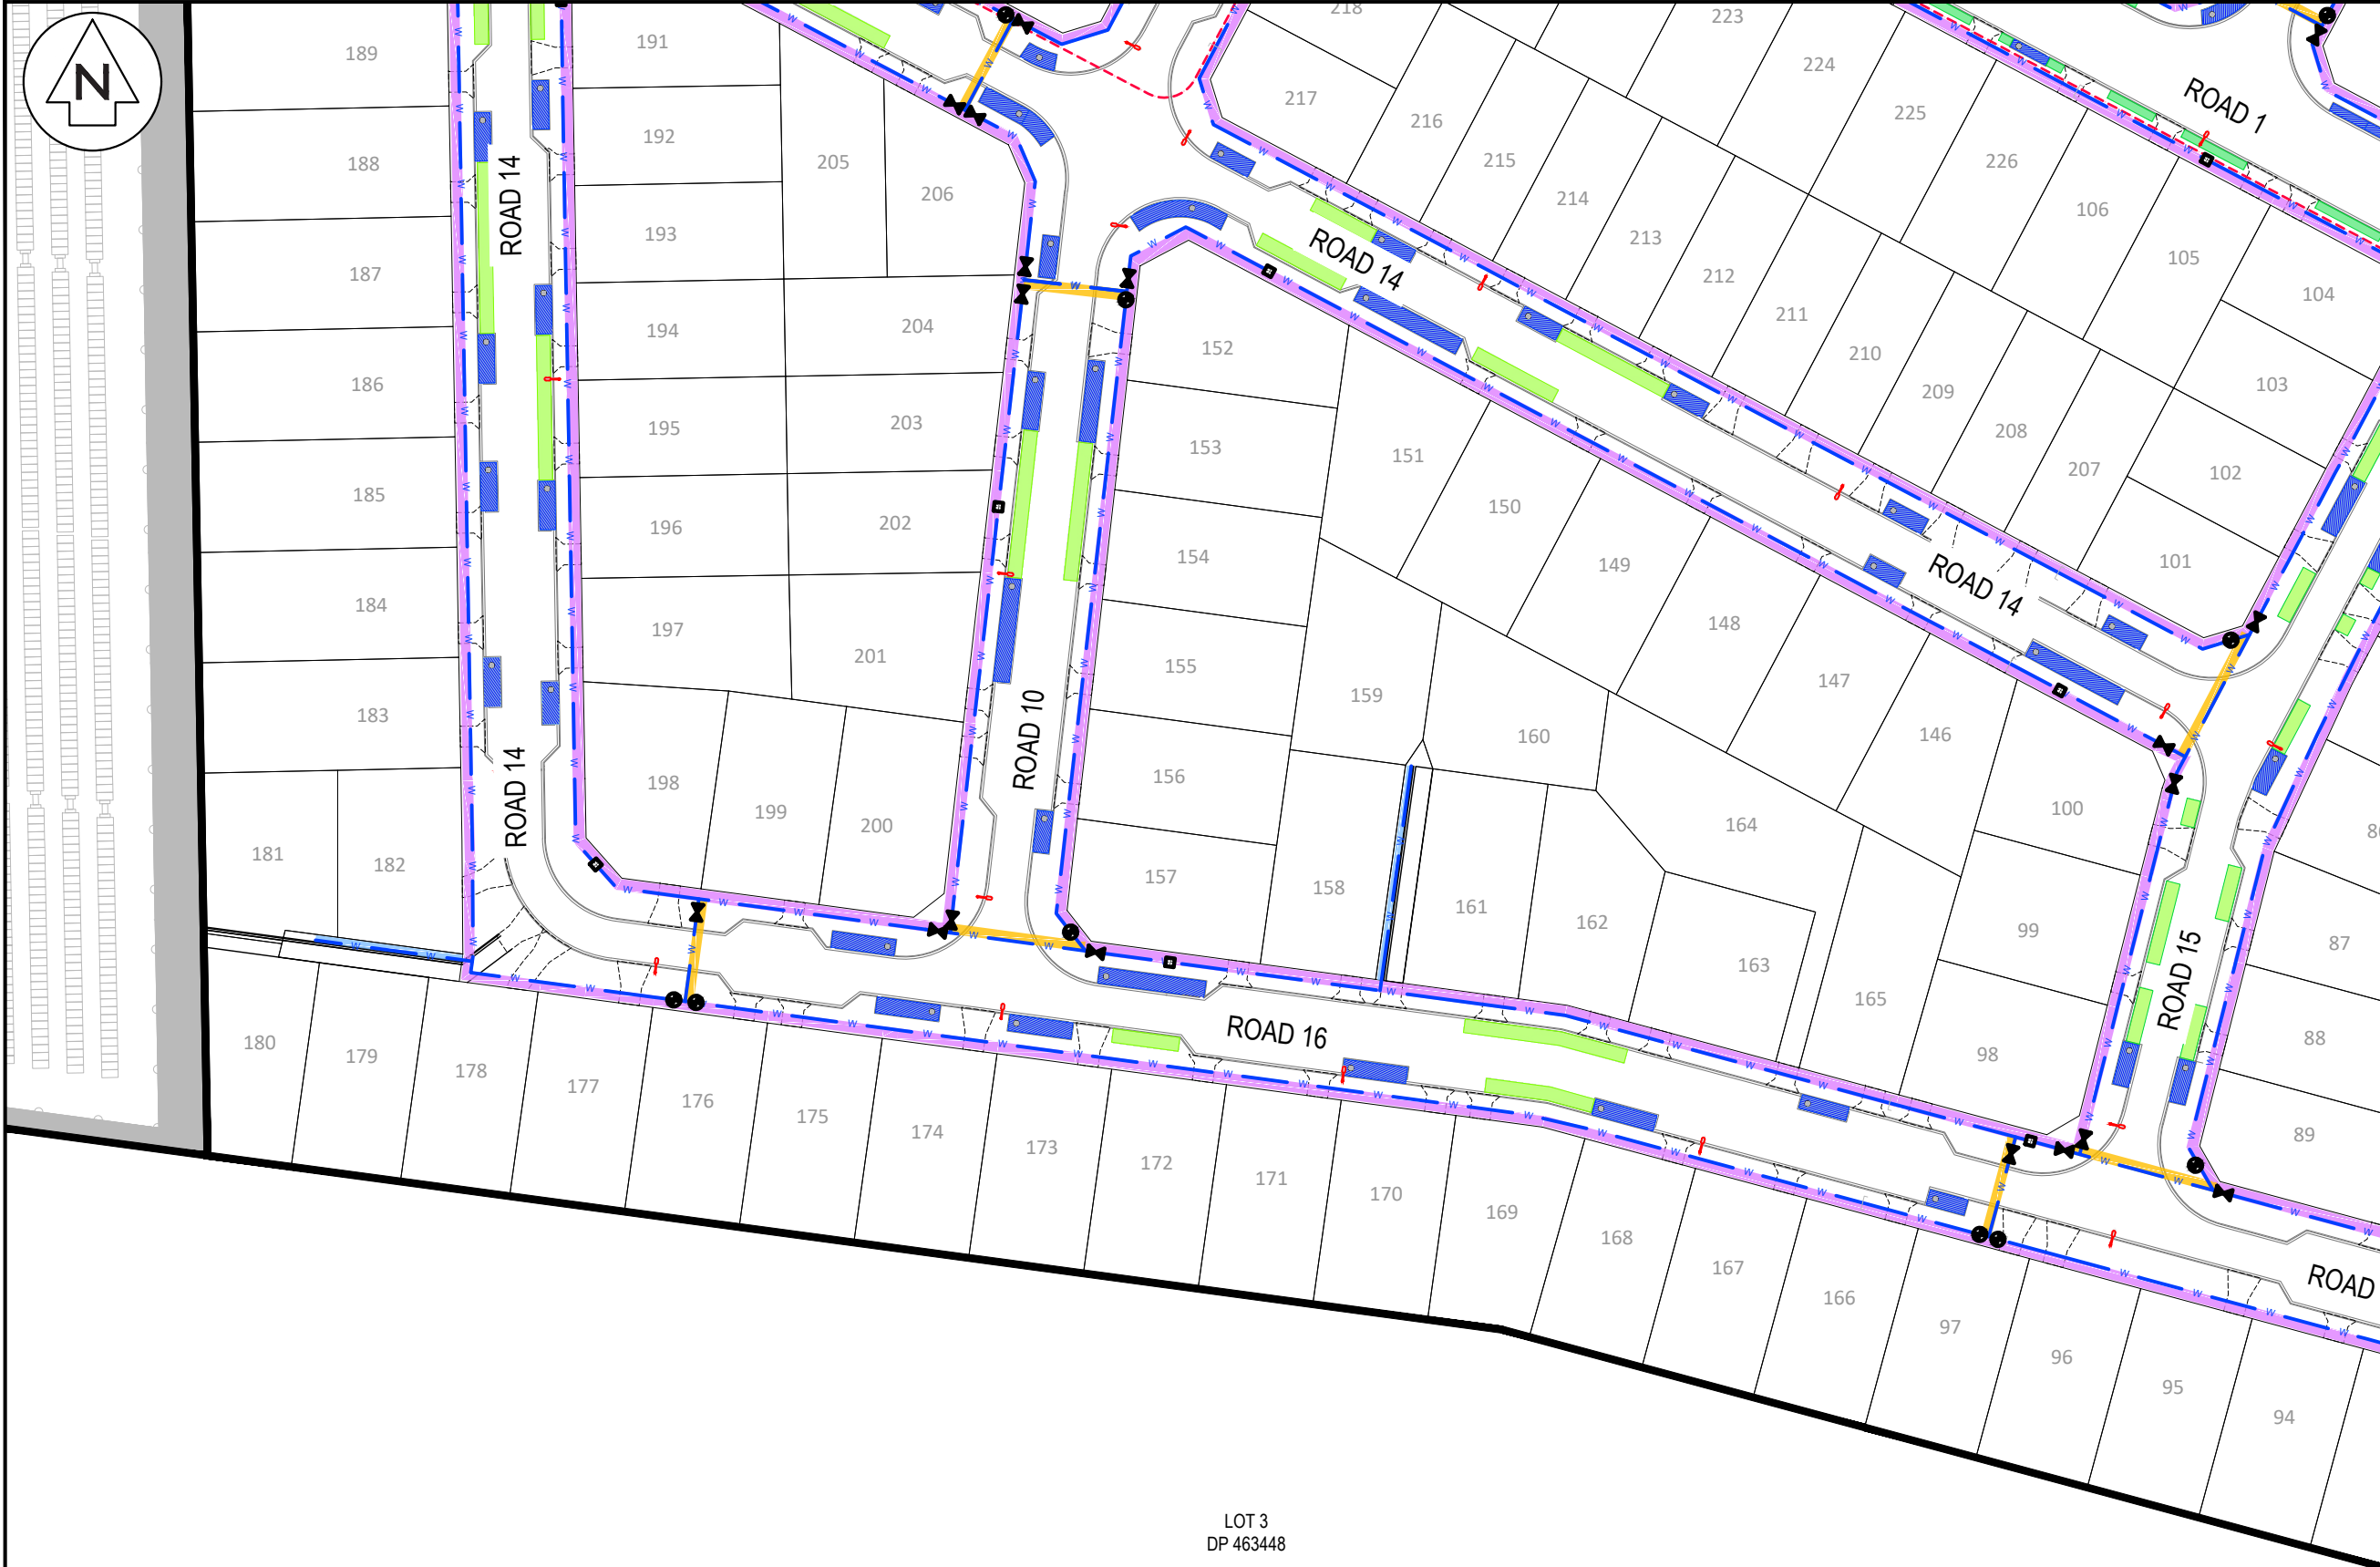

LOT 3  
DP 463448

Notes

1. All works to be in accordance with Regional Infrastructure Technical Specification (RITS).
2. Co-ordinates in terms of NZ Geodetic Datum Mount Eden 2000.
3. Levels in terms of the New Zealand Vertical Datum 2016.
4. All ducts to be 100mm unless specified otherwise. Streetlight ducts to 50mm.
5. All road crossings to have 1.2m cover below finished levels unless specified otherwise.

Legend

- EX BOUNDARY
- EX BOUNDARY
- EX FIBRE
- EX WATER SUPPLY
- EX TELECOM
- PR INDICATIVE DRAFT HOUSE LAYOUT
- PR LOT & ROAD BDY
- PR BOUNDARY
- PR WATER SUPPLY
- PR TRENCH CROSSING
- PR BERM TRENCH TYPE 1
- PR BERM TRENCH TYPE 2
- FIRE HYDRANT
- EX/PR SLUICE VALVE
- EX/PR PEET VALVE
- PROP STREET LIGHT

E	FAST TRACK APP	MKS	11/2025
D	FAST TRACK APP	MKS	06/2025
C	FAST TRACK APP	MKS	05/2025
B	FAST TRACK APP	NDL	04/2025
Rev	Description	By	Date
		By	Date
Survey	MAVEN		05/2024
Design	WPJ		11/2024
Drawn	WPJ		11/2024
Checked	DJM		06/2025

**Maven Waikato**  
07 242 0601  
info@maven.co.nz  
www.maven.co.nz  
Level 1 286 Victoria Street, Hamilton  
New Zealand

Project


**ASHBOURNE  
RESIDENTIAL  
FOR  
MATAMATA  
DEVELOPMENTS LTD**

Title

**PROPOSED  
SERVICES  
PLAN SHEET 9 OF 10**

Project no.	289001		
Scale	1:1000 @ A3		
Cad file	C700-SERVICES.DWG		
Drawing no.	C700-9	Rev	E

RESOURCE CONSENT

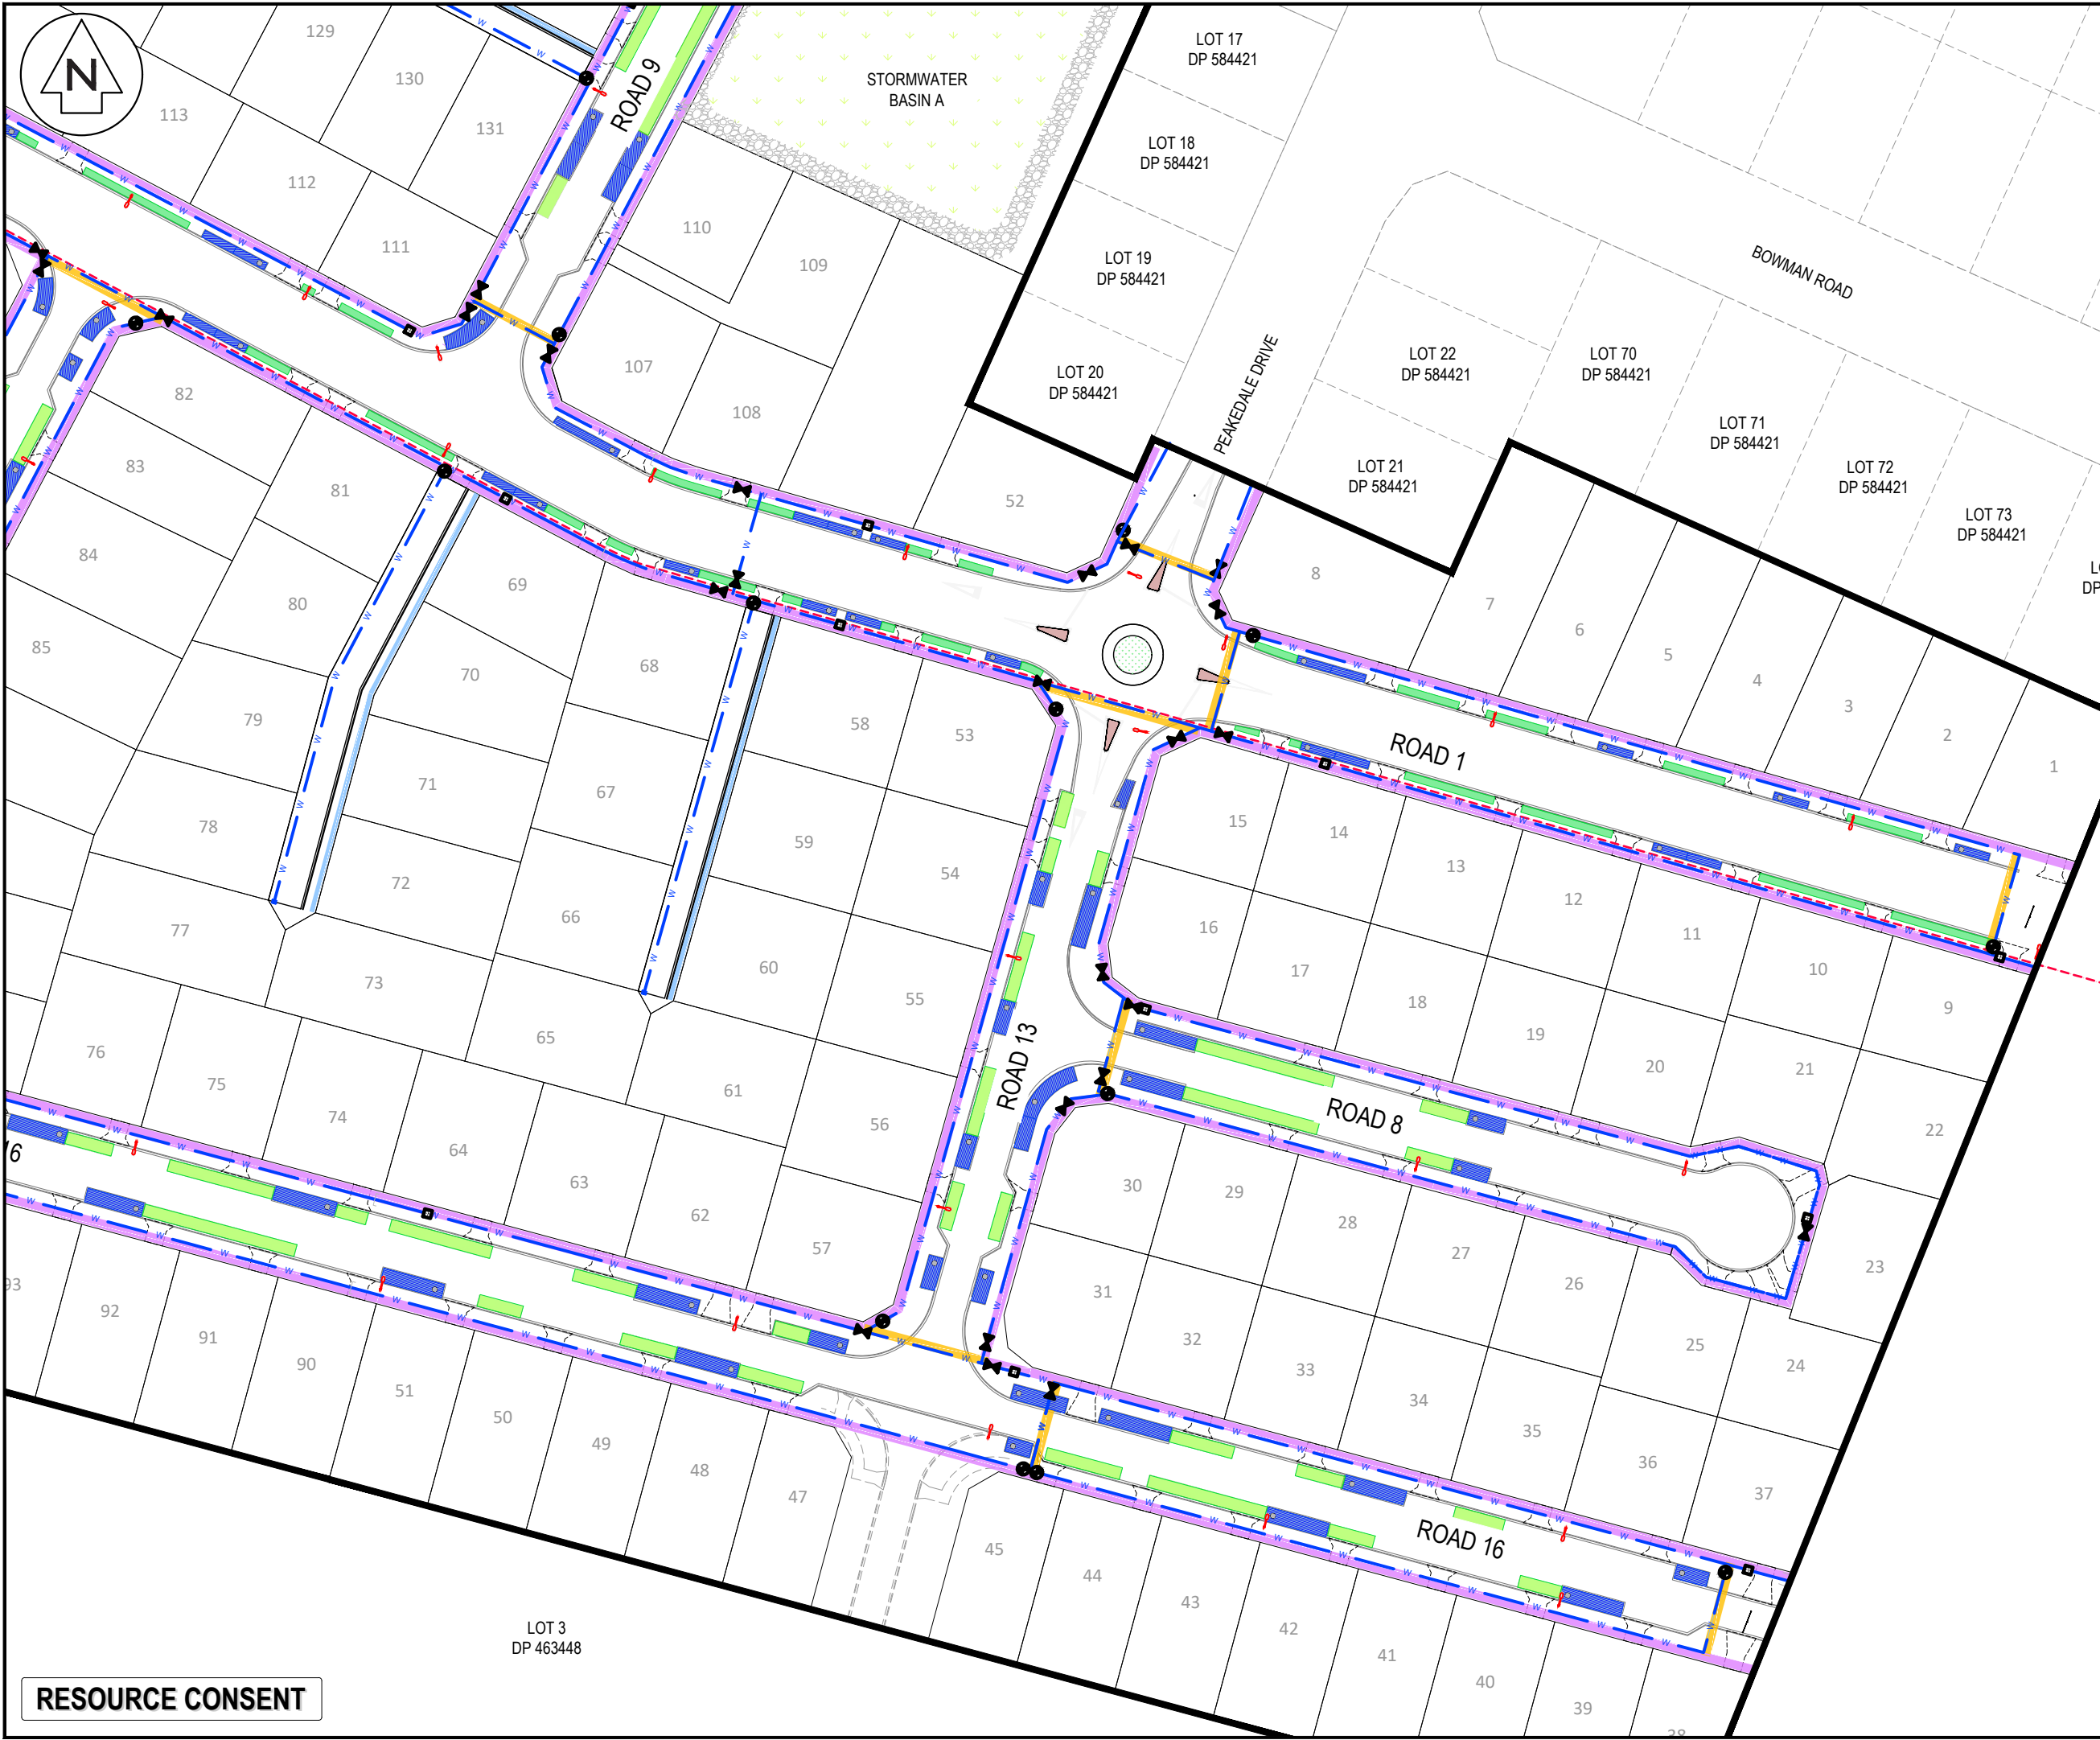

Notes

- All works to be in accordance with Regional Infrastructure Technical Specification (RITS).
- Co-ordinates in terms of NZ Geodetic Datum Mount Eden 2000.
- Levels in terms of the New Zealand Vertical Datum 2016.
- All ducts to be 100mm unless specified otherwise. Streetlight ducts to 50mm.
- All road crossings to have 1.2m cover below finished levels unless specified otherwise.

Legend

—

EX BOUNDARY

—

EX BOUNDARY

— F

EX FIBRE

— W

EX WATER SUPPLY

— T

EX TELECOM

---

PR INDICATIVE DRAFT HOUSE LAYOUT

---

PR LOT & ROAD BDY

---

PR BOUNDARY

— W

PR WATER SUPPLY

—

PR TRENCH CROSSING

—

PR BERM TRENCH TYPE 1

—

PR BERM TRENCH TYPE 2

⊕

FIRE HYDRANT

⊗

EX/PR SLUICE VALVE

⊗

EX/PR PEET VALVE

⊗

PROP STREET LIGHT

E	FAST TRACK APP	MKS	11/2025
D	FAST TRACK APP	MKS	06/2025
C	FAST TRACK APP	MKS	05/2025
B	FAST TRACK APP	NDL	04/2025
Rev	Description	By	Date
Survey	MAVEN		05/2024
Design	WPJ		11/2024
Drawn	WPJ		11/2024
Checked	DJM		06/2025

M

MAVEN

Maven Waikato

07 242 0601

info@maven.co.nz

www.maven.co.nz

Level 1 286 Victoria Street, Hamilton New Zealand

Project

**ASHBOURNE  
RESIDENTIAL  
FOR  
MATAMATA  
DEVELOPMENTS LTD**

Title


**PROPOSED  
SERVICES  
PLAN SHEET 10 OF 10**

Project no.	289001		
Scale	1:1000 @ A3		
Cad file	C700-SERVICES.DWG		
Drawing no.	C700-10	Rev	E

DATE: 11/11/25 FILEPATH: F:\MAVEN\HAMILTON\6 PROJECTS\289001 - STATION ROAD\ DRAWING\11 ASHBORNE RESIDENTIAL\700SERVICES.DWG

RESOURCE CONSENT



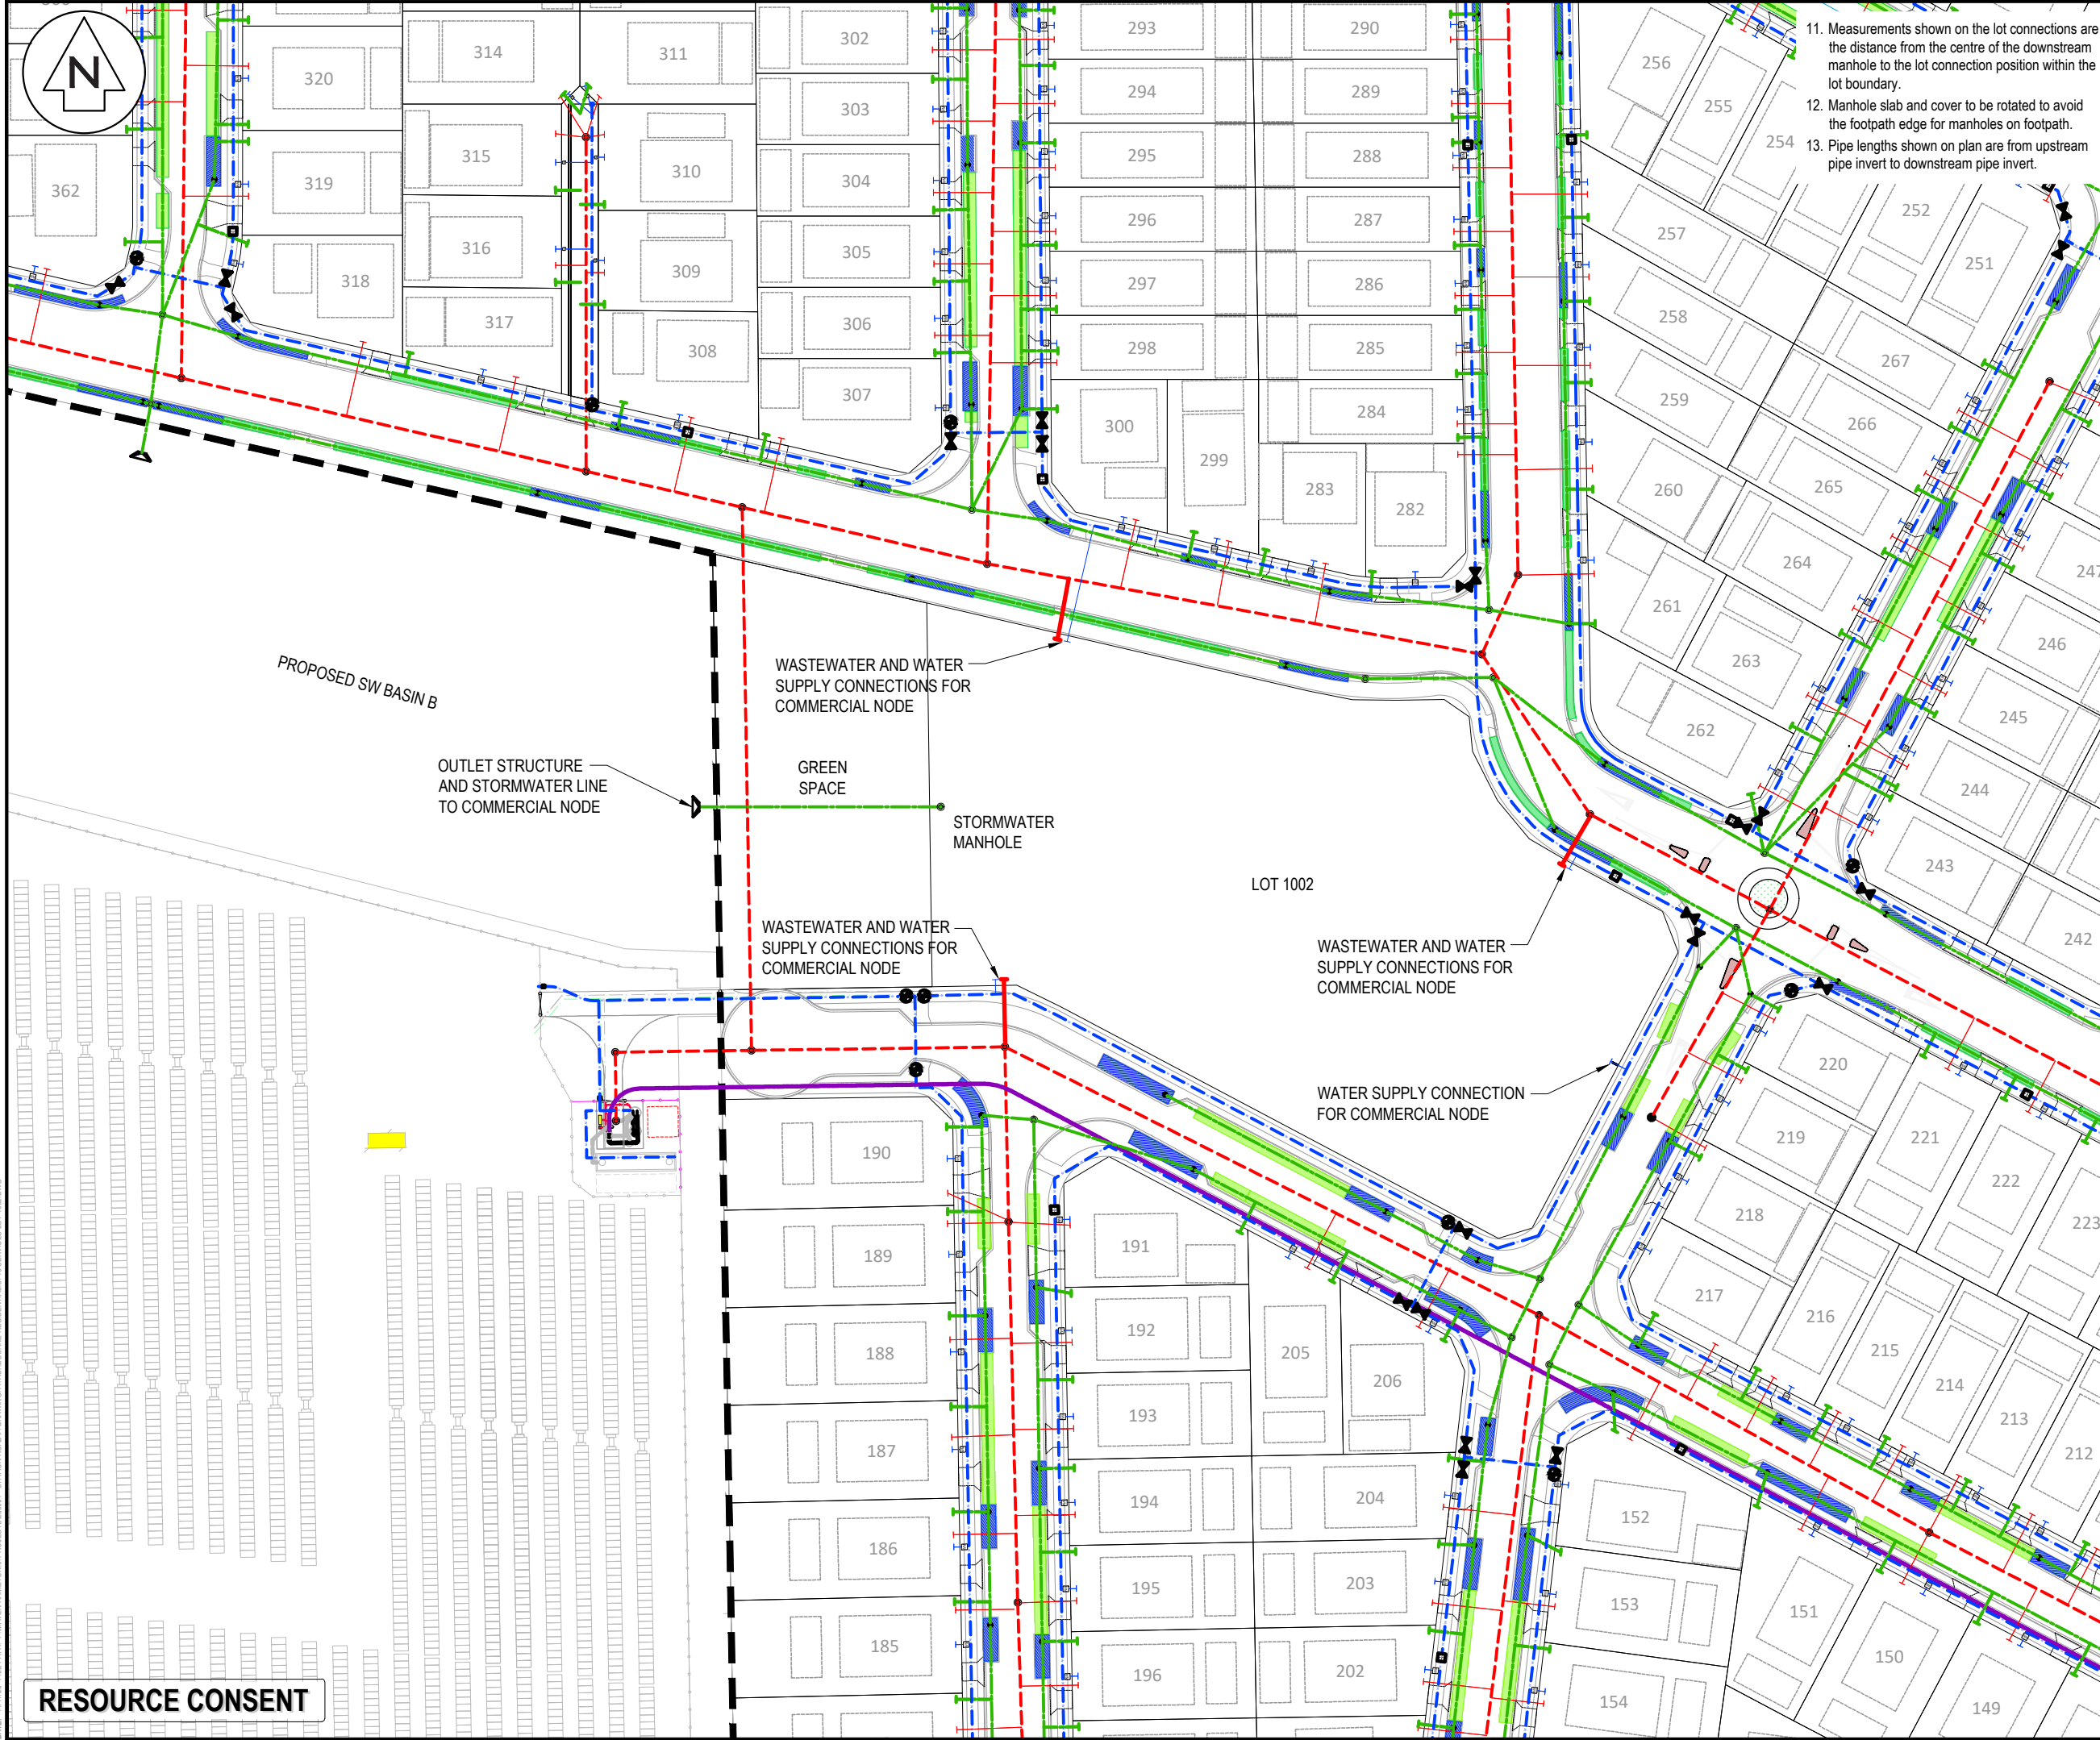

- 11. Measurements shown on the lot connections are the distance from the centre of the downstream manhole to the lot connection position within the lot boundary.
- 12. Manhole slab and cover to be rotated to avoid the footpath edge for manholes on footpath.
- 13. Pipe lengths shown on plan are from upstream pipe invert to downstream pipe invert.

- Notes
- 1. All works to be in accordance with Waikato Regional Infrastructure Technical Specifications.
  - 2. Co-ordinates in terms of NZ Geodetic Datum Mount Eden 2000.
  - 3. Levels in terms of the New Zealand Vertical Datum 2016.
  - 4. It is the Contractors responsibility to locate all services that may be affected by his operations.
  - 5. Approved hardfill is to be used in backfilling of all road crossings to council standards.
  - 6. Heavy duty manhole lids and frames to be used in trafficked areas, all manholes shall have stainless grates installed.
  - 7. All lines are to be 150mmØ PVC Class SN16 unless shown otherwise.
  - 8. All lot connections are to be 100mmØ PVC unless shown otherwise.
  - 9. 150mmØ pipes that do not terminate in a manhole must be terminated with a 100mmØ on a 150mmØ london junction and blank cap.
  - 10. Manhole diameters shown on structure label are internal diameter.

Legend

- EX BOUNDARY
- PR LOT BOUNDARY
- PR SWMH 1050mmØ
- PR SCRUFFY DOME
- SOAKAGE TRENCH - 1.2m WIDE
- SOAKAGE TRENCH - 2m WIDE
- RAINGARDEN - 1.2m / 2.3m WIDE
- PR WASTEWATER
- WW RISING MAIN
- EX/PROP WWMH
- WW LOT CONNECTION
- PR WATERMAIN
- PR LOT CONNECTION
- PR FLUSHING VALVE
- PR STORMWATER
- PR WASTEWATER

B	FAST TRACK APP	MKS	11/2025
A	FAST TRACK APP	RJM	04/2025
Rev	Description	By	Date
Survey	MAVEN		05/2024
Design	RJM		04/2025
Drawn	RJM		04/2025
Checked	DJM		04/2025

**M** **MAVEN** Associates  
09 571 0050  
info@maven.co.nz  
www.maven.co.nz  
5 Owens Road, Epsom  
Auckland 1023

Project  
**ASHBOURNE  
RESIDENTIAL  
FOR  
MATAMATA  
DEVELOPMENTS LTD**

Title  
**LOT 1002  
SERVICES PLAN  
OPTION 1A**

Project no.	289001		
Scale	1:1000 @ A3		
Cad file	C710-SERVICES LOT 1002.DWG		
Drawing no.	C710-1	Rev	B

**RESOURCE CONSENT**

DATE: 11/1/25 FILEPATH: F:\MAVEN\HAMITON6 PROJECTS\88001 - STATION ROAD\DRAWING\11 ASHBORNE RESIDENTIAL\LOT 1002.DWG