




CROSS SECTION


STANDARD DETAIL FOR SILT FENCE

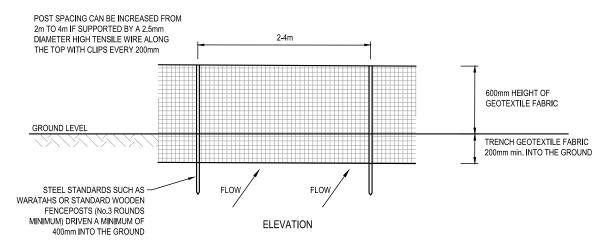

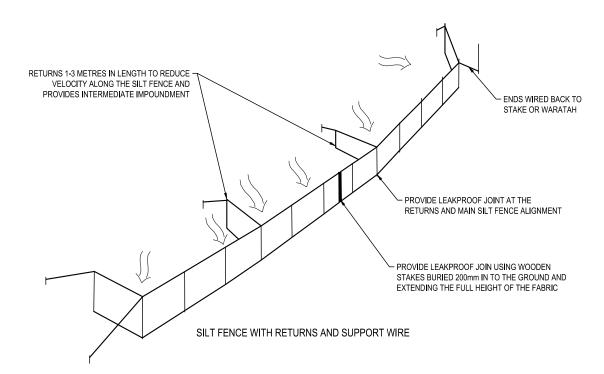

SUPER SILT FENCE DETAIL

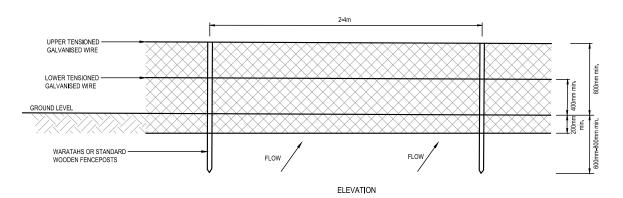

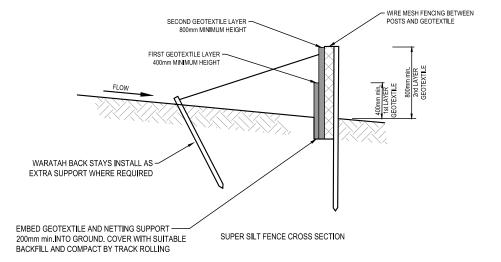

NOTES

- ALL WORKS TO BE IN ACCORDANCE WITH AUCKLAND COUNCIL STANDARDS.
- IT IS THE CONTRACTORS RESPONSIBILITY TO LOCATE ALL SERVICES THAT MAY BE AFFECTED BY THEIR OPERATIONS.
- THE CONTRACTOR SHALL COMPLY WITH ALL RELEVANT HEALTH AND SAFETY REQUIREMENTS.
- THE CONTRACTOR SHALL OBTAIN ALL NECESSARY APPROVAL FROM UTILITY OPERATORS BEFORE COMMENCING WORK UNDER OR NEAR THEIR SERVICES
- SEDIMENT CONTROL SHALL BE INSTALLED AND OPERATIONAL BEFORE EARTHWORKS START ONSIT IN ACCORDANCE WITH COUNCIL STANDARDS.
- CONTRACTOR SHALL PROVIDE ASBUILT OF WORKING SEDIMENT CONTROL DEVICES AND CONFIRMATION OF POND/DECENT VOLUMES TO ENGINEER.
- SEDIMENT CONTROL TO COMPLY WITH GD05 STANDARDS.

Α	RES	OURCE CONSEN	T		MA	02/2025	
Rev	Desc	ription			Ву	Date	
		Ву		Date			
Surve	у	-		/	-/		
Desig	n	-		-			
Drawr	1	MA		02/20	25		
Check	ed	RW/KH		03/20	25		



M A


DEVELOPMENT OF
RIVERHEAD FOREST
FOR RANGITOOPUNI
DEVELOPMENTS LIMITED
PARTNERSHIP


Title

PROPOSED SEDIMENT EROSION CONTROL DETAILS: SHEET 1

Project no.	147007				
Scale	N.T.S				
Cad file	147007-M-C240 ESC STD DETAILS.DWG				
Drawing no.	C240	Rev	Α		


RESOURCE CONSENT

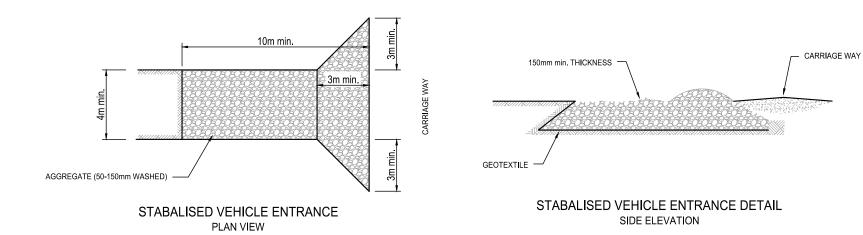

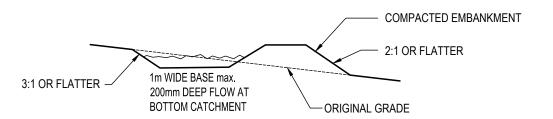

TYPICAL CROSS SECTION OF A RUNOFF DIVERSION

TYPICAL DIMENSIONS UNLESS OTHERWISE NOTED

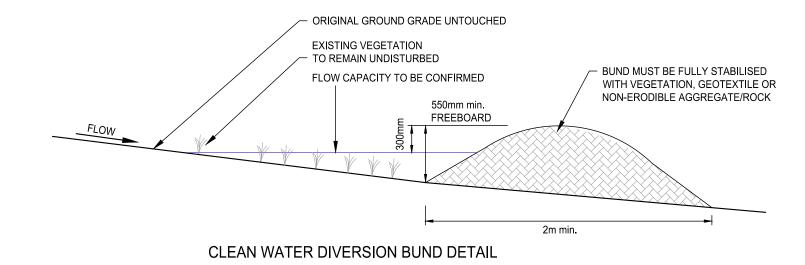

RESOURCE CONSENT

- . ALL WORKS TO BE IN ACCORDANCE WITH AUCKLAND COUNCIL STANDARDS.
- IT IS THE CONTRACTORS RESPONSIBILITY TO LOCATE ALL SERVICES THAT MAY BE AFFECTED BY THEIR OPERATIONS.
- THE CONTRACTOR SHALL COMPLY WITH ALL RELEVANT HEALTH AND SAFETY REQUIREMENTS.
- THE CONTRACTOR SHALL OBTAIN ALL NECESSARY APPROVAL FROM UTILITY OPERATORS BEFORE COMMENCING WORK UNDER OR NEAR THEIR SERVICES.
- SEDIMENT CONTROL SHALL BE INSTALLED AND OPERATIONAL BEFORE EARTHWORKS START ONSIT IN ACCORDANCE WITH COUNCIL STANDARDS.
- CONTRACTOR SHALL PROVIDE ASBUILT OF WORKING SEDIMENT CONTROL DEVICES AND CONFIRMATION OF POND/DECENT VOLUMES TO ENGINEER.
- SEDIMENT CONTROL TO COMPLY WITH GD05

STANDARDS.


Α	RESOURCE CONSENT			MA	02/2025
Rev	Desc	Description		Ву	Date
	Ву		Date		
Surve	Survey/		/		
Design -		-	-		
Drawn	1	MA	02/2025		
Checked		RW/KH	03/2025		



DEVELOPMENT OF **RIVERHEAD FOREST** FOR RANGITOOPUNI **DEVELOPMENTS LIMITED PARTNERSHIP**

PROPOSED SEDIMENT **EROSION CONTROL DETAILS: SHEET 2**

Project no.	147007		
Scale	N.T.S		
Cad file	147007-M-C240 ESC STD DETAIL	LS.DWG	
Drawing no.	C241	Rev	Α

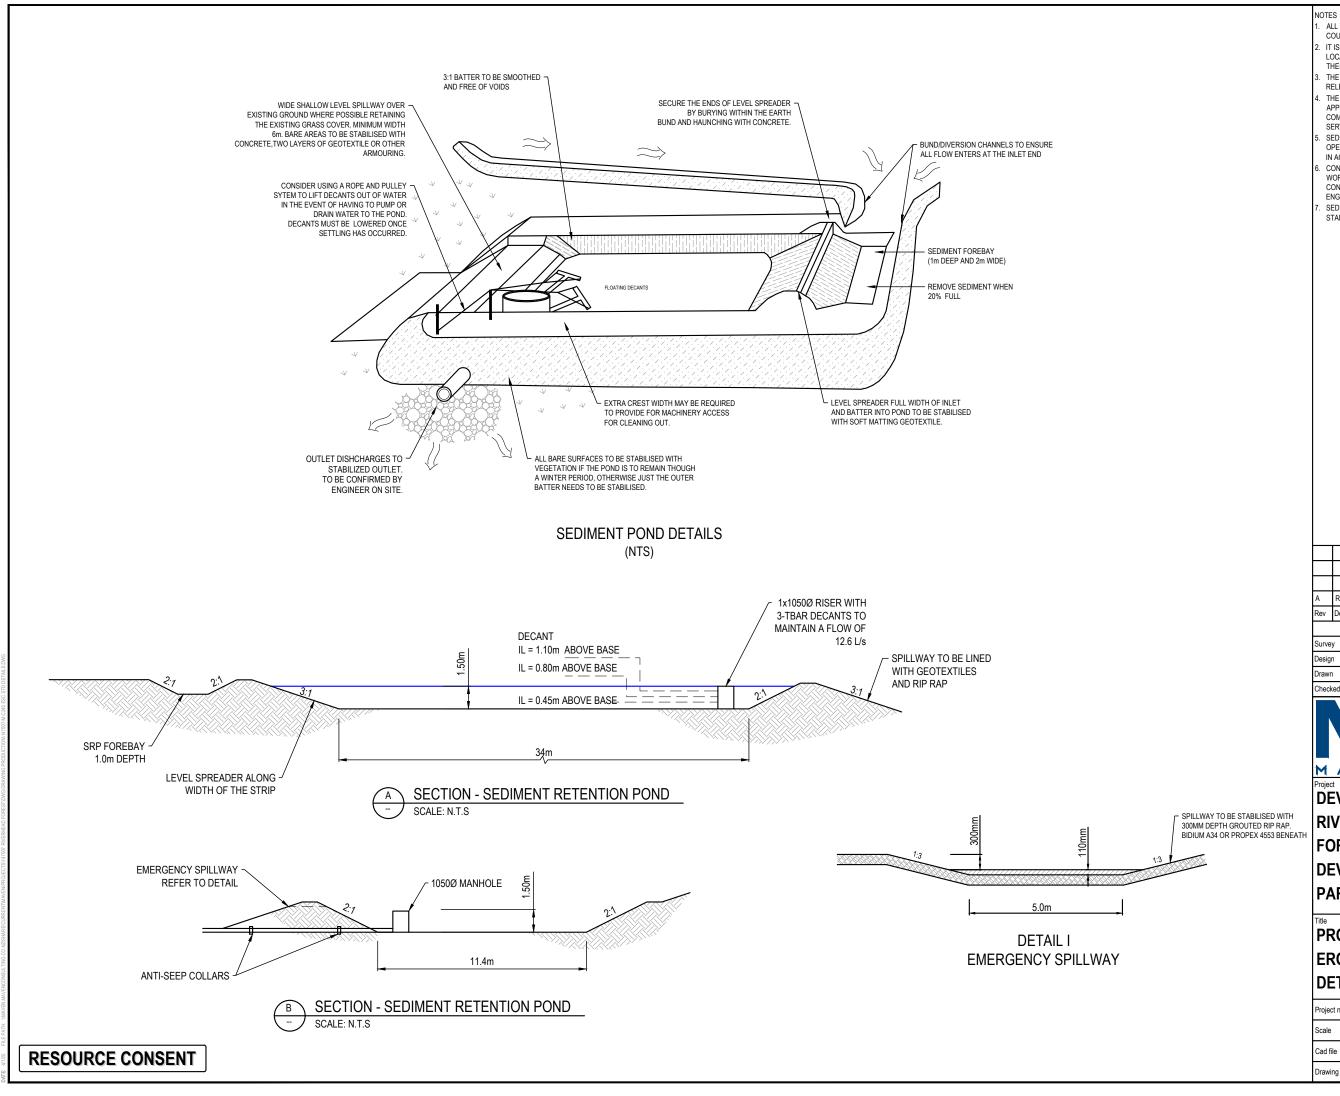

- ALL WORKS TO BE IN ACCORDANCE WITH AUCKLAND COUNCIL STANDARDS.
- IT IS THE CONTRACTORS RESPONSIBILITY TO LOCATE ALL SERVICES THAT MAY BE AFFECTED BY THEIR OPERATIONS.
- 3. THE CONTRACTOR SHALL COMPLY WITH ALL RELEVANT HEALTH AND SAFETY REQUIREMENTS.
- THE CONTRACTOR SHALL OBTAIN ALL NECESSARY APPROVAL FROM UTILITY OPERATORS BEFORE COMMENCING WORK UNDER OR NEAR THEIR SERVICES
- SEDIMENT CONTROL SHALL BE INSTALLED AND OPERATIONAL BEFORE EARTHWORKS START ONSIT IN ACCORDANCE WITH COUNCIL STANDARDS.
- CONTRACTOR SHALL PROVIDE ASBUILT OF WORKING SEDIMENT CONTROL DEVICES AND CONFIRMATION OF POND/DECENT VOLUMES TO ENGINEER.
- 7. SEDIMENT CONTROL TO COMPLY WITH GD05 STANDARDS.

A RESOURCE CONSENT MA 02/2025

Rev Description By Date

Survey -- ----Design -- Drawn MA 02/2025


Checked RW/KH 03/2025




Project
DEVELOPMENT OF
RIVERHEAD FOREST
FOR RANGITOOPUNI
DEVELOPMENTS LIMITED
PARTNERSHIP


PROPOSED SEDIMENT
EROSION CONTROL
DETAILS: SHEET 3

Project no.	147007		
Scale	N.T.S		
Cad file	147007-M-C240 ESC STD DETAIL	LS.DWG	
Drawing no.	C242	Rev	Α

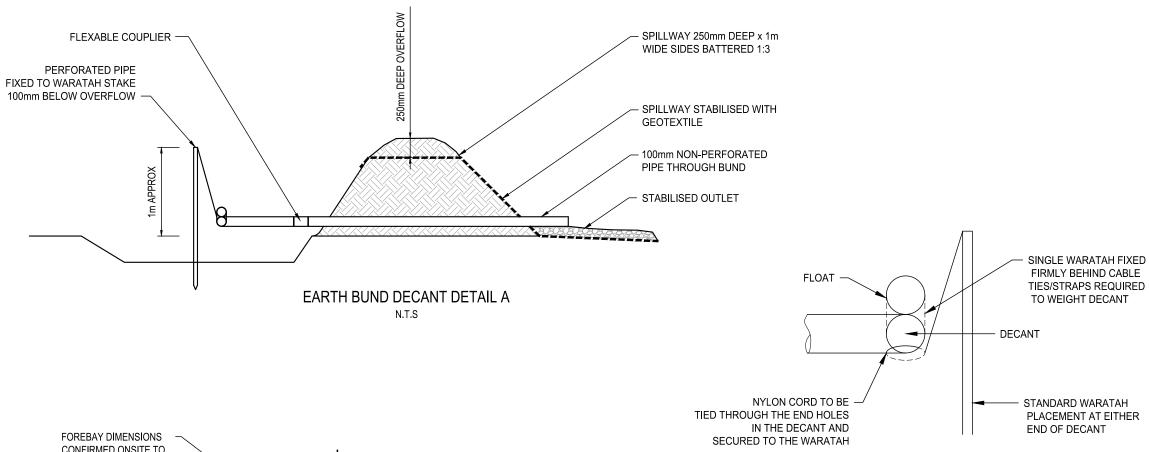

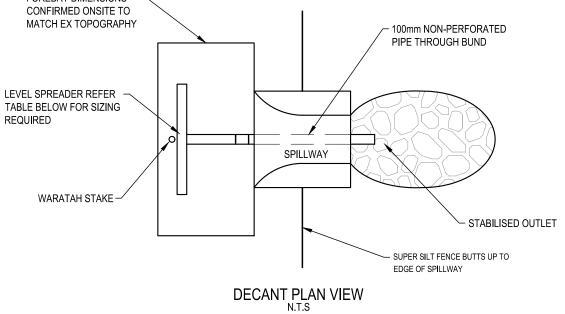

LEVEL SPREADER DESIGN CRITERIA (20 YEAR STORM EVENT)						
DESIGN FLOW (m³/sec)	INLET WIDTH (m)	DEPTH (m)	END WIDTH (m)	LENGTH (mm)		
0-0.3	3	150	1	3		
0.3-0.6	5	180	1	7		
0.6-0.9	7	220	1	10		

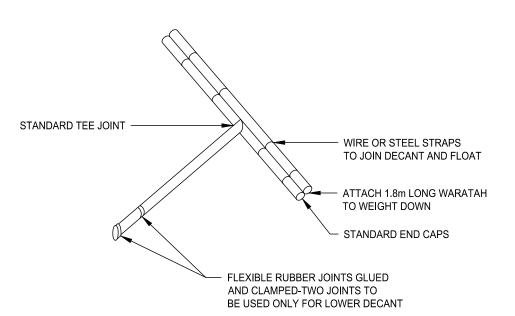

NOTES

- ALL WORKS TO BE IN ACCORDANCE WITH AUCKLAND COUNCIL STANDARDS.
- IT IS THE CONTRACTORS RESPONSIBILITY TO LOCATE ALL SERVICES THAT MAY BE AFFECTED BY THEIR OPERATIONS.
- THE CONTRACTOR SHALL COMPLY WITH ALL RELEVANT HEALTH AND SAFETY REQUIREMENTS.
- THE CONTRACTOR SHALL OBTAIN ALL NECESSARY APPROVAL FROM UTILITY OPERATORS BEFORE COMMENCING WORK UNDER OR NEAR THEIR SERVICES.
- SEDIMENT CONTROL SHALL BE INSTALLED AND OPERATIONAL BEFORE EARTHWORKS START ONSIT IN ACCORDANCE WITH COUNCIL STANDARDS.
- CONTRACTOR SHALL PROVIDE ASBUILT OF WORKING SEDIMENT CONTROL DEVICES AND CONFIRMATION OF POND/DECENT VOLUMES TO ENGINEER.
- 7. SEDIMENT CONTROL TO COMPLY WITH GD05 STANDARDS.

Α	RES	OURCE CONSENT		MA	02/2025
Rev	Description			Ву	Date
Ву		Ву	Date		
Survey			/		·
Desigr	1	-	-		
Drawn	1	MA	02/2025		
Checked		RW/KH	03/20	25	




Project

DEVELOPMENT OF
RIVERHEAD FOREST
FOR RANGITOOPUNI
DEVELOPMENTS LIMITED
PARTNERSHIP


PROPOSED SEDIMENT EROSION CONTROL DETAILS: SHEET 4


Project no. Scale	147007 N.T.S			
Cad file	147007-M-C240 ESC STD DETAILS.DWG			
Drawing no.	C243	Rev	Α	

RESOURCE CONSENT

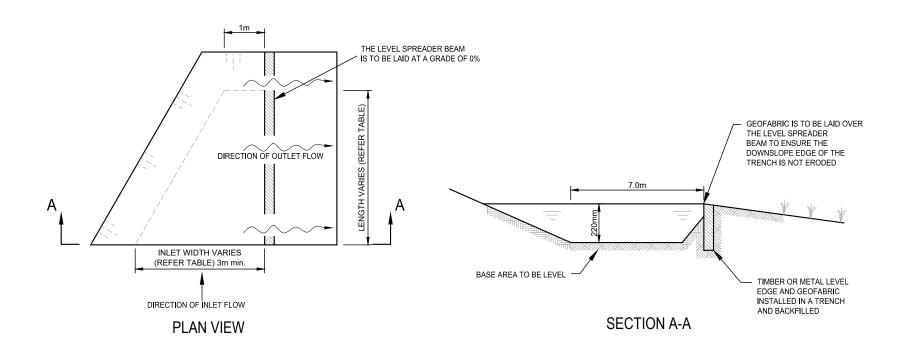

LEV	EL SPREADER DES	SIGN CRITERIA (20	YEAR STORM EV	ENT)
DESIGN FLOW (m³/sec)	INLET WIDTH (m)	DEPTH (m)	END WIDTH (m)	LENGTH (mm)
0-0.3	3	150	1	3
0.3-0.6	5	180	1	7
0.6-0.9	7	220	1	10

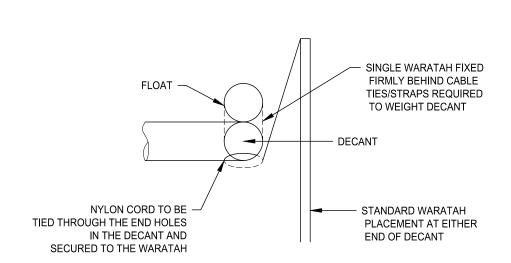

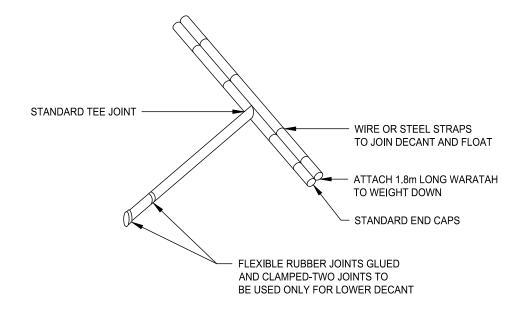

NOTES

- ALL WORKS TO BE IN ACCORDANCE WITH AUCKLAND COUNCIL STANDARDS.
- IT IS THE CONTRACTORS RESPONSIBILITY TO LOCATE ALL SERVICES THAT MAY BE AFFECTED BY THEIR OPERATIONS.
- THE CONTRACTOR SHALL COMPLY WITH ALL RELEVANT HEALTH AND SAFETY REQUIREMENTS.
- THE CONTRACTOR SHALL OBTAIN ALL NECESSARY APPROVAL FROM UTILITY OPERATORS BEFORE COMMENCING WORK UNDER OR NEAR THEIR SERVICES.
- S. SEDIMENT CONTROL SHALL BE INSTALLED AND OPERATIONAL BEFORE EARTHWORKS START ONSIT IN ACCORDANCE WITH COUNCIL STANDARDS.
- CONTRACTOR SHALL PROVIDE ASBUILT OF WORKING SEDIMENT CONTROL DEVICES AND CONFIRMATION OF POND/DECENT VOLUMES TO ENGINEER.
- 7. SEDIMENT CONTROL TO COMPLY WITH GD05 STANDARDS.

Α	RES	OURCE CONSENT		MA	02/2025
Rev	/ Description			Ву	Date
	Ву		Date		
Survey			/		
Design		-	-		
Drawn	1	MA	02/2025		
Checked		RW/KH	03/202	25	



Project

DEVELOPMENT OF
RIVERHEAD FOREST
FOR RANGITOOPUNI
DEVELOPMENTS LIMITED
PARTNERSHIP

Title

PROPOSED SEDIMENT EROSION CONTROL DETAILS: SHEET 5

111001 111 02:10 200 013 32:1	,				
Cad file 147007-M-C240 ESC STD DET	147007-M-C240 ESC STD DETAILS.DWG				
Scale N.T.S	N.T.S				
Project no. 147007	147007				

RESOURCE CONSENT

