





ARATAKI DEVELOPMENT -HAVELOCK NORTH

BUILDING B, LEVEL 1 8 NUGENT ST, GRAFTON, AUCKLAND 1023 +64 9 308 9229

DRAWINGS ISSUED FOR CONSENT

HASTINGS DISTRICT COUNCIL

ARATAKI DEVELOPMENT DRAWINGS FOR CONSENT

DRAWINGS INDEX

| DRAWING | REV | DRAWING TITLE |
|--|-----|--|
| NUMBER P24-244-00-000 | 2 | COVER PAGE |
| P24-244-00-000 P24-244-00-0000-GE | 2 | DRAWING INDEX |
| P24-244-00-0001-SC | 2 | SCHEME PLAN |
| P24-244-00-0002-SC | 2 | SCHEME PLAN |
| P24-244-00-0003-SC | 2 | SCHEME PLAN |
| P24-244-00-0010-GE | 2 | SITE LOCATION PLAN |
| P24-244-00-0011-GE | 2 | EXISTING TITLES PLAN |
| P24-244-00-0020-GE | 2 | EXISTING FEATURES PLAN |
| P24-244-00-0030-GE | 2 | SITE CLEARING PLAN |
| P24-244-00-0100-GE | 2 | DEVELOPMENT CONTROL PLAN |
| P24-244-00-1000-EW | 2 | EXISTING CONTOUR PLAN |
| P24-244-00-1001-EW | 2 | EXISTING CONTOUR PLAN - SHEET 1 |
| P24-244-00-1002-EW | 2 | EXISTING CONTOUR PLAN - SHEET 2 |
| P24-244-00-1003-EW | 2 | EXISTING CONTOUR PLAN - SHEET 3 |
| P24-244-00-1100-EW | 2 | DESIGN CONTOUR PLAN |
| P24-244-00-1101-EW | 2 | DESIGN CONTOUR PLAN - SHEET 1 |
| P24-244-00-1102-EW | 2 | DESIGN CONTOUR PLAN - SHEET 2 |
| P24-244-00-1103-EW | 2 | DESIGN CONTOUR PLAN - SHEET 3 |
| P24-244-00-1200-EW | 2 | CUT FILL PLAN |
| P24-244-00-1201-EW | 2 | CUT FILL PLAN - SHEET 1 |
| P24-244-00-1202-EW | 2 | CUT FILL PLAN - SHEET 2 |
| P24-244-00-1203-EW | 2 | CUT FILL PLAN - SHEET 3 |
| P24-244-00-1210-EW | 2 | STORMWATER OUTLET EARTHWORKS PLAN |
| P24-244-00-1300-RD | 2 | EARTHWORKS SECTIONS PLAN |
| P24-244-00-1301-RD | 2 | EARTHWORKS SECTIONS - SHEET 1 |
| P24-244-00-1302-RD | 2 | EARTHWORKS SECTIONS - SHEET 2 |
| P24-244-00-1303-RD | 2 | EARTHWORKS SECTIONS - SHEET 3 |
| P24-244-00-1304-RD | 2 | EARTHWORKS SECTIONS - SHEET 4 |
| P24-244-00-1305-RD | 2 | EARTHWORKS SECTIONS - SHEET 5 |
| P24-244-00-1400-EW | 2 | RETAINING WALL LAYOUT |
| P24-244-00-1800-EW | 2 | SEDIMENT AND EROSION CONTROL PLAN OVERALL |
| P24-244-00-1801-EW | 2 | SEDIMENT AND EROSION CONTROL PLAN - SHEET 1 |
| P24-244-00-1802-EW | 2 | SEDIMENT AND EROSION CONTROL PLAN - SHEET 2 |
| P24-244-00-1803-EW | 2 | SEDIMENT AND EROSION CONTROL PLAN - SHEET 3 |
| P24-244-00-1805-EW | 2 | SEDIMENT AND EROSION CONTROL PLAN - DRY BASIN |
| P24-244-00-1810-EW | 2 | SEDIMENT AND EROSION CONTROL - STANDARD DETAILS SHEET 1 |
| P24-244-00-1811-EW | 2 | SEDIMENT AND EROSION CONTROL - STANDARD DETAILS SHEET 2 |
| P24-244-00-1812-EW | 2 | SEDIMENT AND EROSION CONTROL - STANDARD DETAILS SHEET 3 |
| P24-244-00-1813-EW | 2 | SEDIMENT AND EROSION CONTROL - STANDARD DETAILS SHEET 4 |
| P24-244-00-1814-EW | 2 | SEDIMENT AND EROSION CONTROL - STANDARD DETAILS SHEET 5 |
| P24-244-00-2000-RD | 2 | ROAD PLAN |
| P24-244-00-2001-RD | 2 | ROAD PLAN - SHEET 1 |
| P24-244-00-2002-RD | 2 | ROAD PLAN - SHEET 2 |
| P24-244-00-2003-RD | 2 | ROAD PLAN - SHEET 3 |
| P24-244-00-2200-RD | 2 | ROAD TYPOLOGY PLAN |
| P24-244-00-2201-RD | 2 | TYPICAL CROSS SECTIONS - ARATAKI ROAD |
| P24-244-00-2202-RD | 2 | TYPICAL CROSS SECTIONS - ACCESS ROAD TYPE 1 & TYPE 2 |
| P24-244-00-2203-RD | 2 | TYPICAL CROSS SECTIONS - ACCESSWAY, JOAL TYPE 2 & TYPE 3 |
| P24-244-00-2204-RD | 2 | TYPICAL CROSS SECTIONS - JOAL TYPE 4 |
| P24-244-00-2205-RD | 2 | TYPICAL CROSS SECTIONS - JOAL TYPE 5 |
| P24-244-00-2206-RD | 2 | TYPICAL CROSS SECTIONS - TYPICAL BERM ARRANGEMENT |
| P24-244-00-2500-RD | 2 | ROAD CENTRELINE PLAN |
| P24-244-00-2501-RD | 2 | ROAD LONGSECTIONS - SHEET 1 |
| P24-244-00-2502-RD | 2 | ROAD LONGSECTIONS - SHEET 2 |
| P24-244-00-2503-RD | 2 | ROAD LONGSECTIONS - SHEET 3 |
| P24-244-00-2504-RD | 2 | ROAD LONGSECTIONS - SHEET 4 |
| P24-244-00-2505-RD | | ROAD LONGSECTIONS - SHEET 5 |
| | 2 | ROAD LONGSECTIONS - SHEET 5 |
| P24-244-00-2700-RD | 2 | VEHICLE PATHS - RUBBISH TRUCKS THROUGH JOALS |
| P24-244-00-2700-RD P24-244-00-2751-RD | | |
| | 2 | VEHICLE PATHS - RUBBISH TRUCKS THROUGH JOALS |

| | | 10 (17 11 105 11 10 12) (|
|--|-----|--|
| DRAWING | REV | DRAWING TITLE |
| NUMBER | # | ARREST CHARLES TO A NO. CHEFT A |
| P24-244-00-2754-RD | 2 | APPROACH SIGHT DISTANCE PLAN - SHEET 1 |
| P24-244-00-2755-RD | 2 | APPROACH SIGHT DISTANCE PLAN - SHEET 2 |
| P24-244-00-2756-RD | 2 | APPROACH SIGHT DISTANCE PLAN - SHEET 3 |
| P24-244-00-2757-RD | 2 | CROSSING SIGHT DISTANCE PLAN - SHEET 1 |
| P24-244-00-2758-RD | 2 | CROSSING SIGHT DISTANCE PLAN - SHEET 2 |
| P24-244-00-2759-RD | 2 | CROSSING SIGHT DISTANCE PLAN - SHEET 3 |
| P24-244-00-2800-RD | 2 | ROAD DETAILS - HDC ENG COP - C19 & C19A |
| P24-244-00-2801-RD | 2 | ROAD DETAILS - HDC ENG COP - WS 105 |
| P24-244-00-2802-RD | 2 | ROAD DETAILS - HDC ENG COP - WS 106 |
| P24-244-00-3000-DR P24-244-00-3001-DR | 2 | STORMWATER DRAINAGE LAYOUT PLAN STORMWATER DRAINAGE LAYOUT PLAN - SHEET 1 |
| P24-244-00-3001-DR | 2 | STORMWATER DRAINAGE LAYOUT PLAN - SHEET 1 |
| P24-244-00-3003-DR | 2 | STORMWATER DRAINAGE LAYOUT PLAN - SHEET 2 STORMWATER DRAINAGE LAYOUT PLAN - SHEET 3 |
| P24-244-00-3500-DR | 2 | STORMWATER LONGSECTIONS - SHEET 1 |
| | 2 | STORMWATER LONGSECTIONS - SHEET 1 STORMWATER LONGSECTIONS - SHEET 2 |
| P24-244-00-3501-DR P24-244-00-3502-DR | 2 | STORMWATER LONGSECTIONS - SHEET 2 STORMWATER LONGSECTIONS - SHEET 3 |
| | | |
| P24-244-00-3503-DR | 2 | STORMWATER LONGSECTIONS - SHEET 4 STORMWATER LONGSECTIONS - SHEET 5 |
| P24-244-00-3504-DR | 2 | |
| P24-244-00-3505-DR | 2 | STORMWATER LONGSECTIONS - SHEET 6 |
| P24-244-00-3506-DR | | STORMWATER LONGSECTIONS - SHEET 7 |
| P24-244-00-3507-DR | 2 | STORMWATER LONGSECTIONS - SHEET 8 |
| P24-244-00-3508-DR | 2 | STORMWATER LONGSECTIONS - SHEET 9 |
| P24-244-00-3509-DR | 2 | STORMWATER LONGSECTIONS - SHEET 10 |
| P24-244-00-3510-DR | 2 | STORMWATER LONGSECTIONS - SHEET 11 |
| P24-244-00-3600-DR | 2 | STORMWATER 10 YEAR CATCHMENT PLAN |
| P24-244-00-3800-DR | 2 | STORMWATER CREAM OUTLET DETAIL |
| P24-244-00-3810-DR | 2 | STORMWATER GPT DETAIL |
| P24-244-00-3850-DR | 2 | BASIN LAYOUT PLAN |
| P24-244-00-3851-DR | 2 | STORMWATER BASIN SECTIONS |
| P24-244-00-3852-DR | 2 | WINGWALL OUTLET 02/01 DETAILS |
| P24-244-00-3853-DR | 2 | STORMWATER BASIN OUTLET 01/05 DETAILS |
| P24-244-00-3900-DR | 2 | OVERLAND FLOW PATH - POST DEVELOPMENT PLAN |
| P24-244-00-3901-DR | 2 | OVERLAND FLOW SECTIONS |
| P24-244-00-3902-DR | 2 | OVERLAND FLOW SECTIONS |
| P24-244-00-3903-DR | 2 | OVERLAND FLOW SECTIONS |
| P24-244-00-3904-DR | 2 | OVERLAND FLOW SECTIONS |
| P24-244-00-3905-DR | 2 | OVERLAND FLOW SECTIONS |
| P24-244-00-3906-DR | 2 | OVERLAND FLOW SECTIONS |
| P24-244-00-3907-DR | 2 | OVERLAND FLOW SECTIONS |
| P24-244-00-3908-DR | 2 | OVERLAND FLOW SECTIONS |
| P24-244-00-3909-DR | 2 | OVERLAND FLOW SECTIONS |
| P24-244-00-3950-DR | 2 | TYPICAL RAINGARDEN DETAILS - PLAN AND LONGSECTION |
| P24-244-00-3951-DR | 2 | TYPICAL RAINGARDEN DETAILS - CROSS SECTIONS |
| P24-244-00-4000-DR | 2 | WASTEWATER DRAINAGE LAYOUT PLAN |
| P24-244-00-4001-DR | 2 | WASTEWATER DRAINAGE LAYOUT PLAN - SHEET 1 |
| P24-244-00-4002-DR | 2 | WASTEWATER DRAINAGE LAYOUT PLAN - SHEET 2 |
| P24-244-00-4003-DR | 2 | WASTEWATER DRAINAGE LAYOUT PLAN - SHEET 3 |
| P24-244-00-4500-DR | 2 | WASTEWATER LONGSECTION - SHEET 1 |
| P24-244-00-4501-DR | 2 | WASTEWATER LONGSECTION - SHEET 2 |
| P24-244-00-4502-DR | 2 | WASTEWATER LONGSECTION - SHEET 3 |
| P24-244-00-4503-DR | 2 | WASTEWATER LONGSECTION - SHEET 4 |
| P24-244-00-4504-DR | 2 | WASTEWATER LONGSECTION - SHEET 5 |
| P24-244-00-4505-DR | 2 | WASTEWATER LONGSECTION - SHEET 6 |
| P24-244-00-4506-DR | 2 | WASTEWATER LONGSECTION - SHEET 7 |
| P24-244-00-4507-DR | 2 | WASTEWATER LONGSECTION - SHEET 8 |
| P24-244-00-4600-DR | 2 | WASTEWATER CATCHMENT PLAN |
| P24-244-00-5000-WR | 2 | WATER RETICULATION LAYOUT PLAN |
| P24-244-00-5001-WR | 2 | WATER RETICULATION LAYOUT PLAN - SHEET 1 |
| P24-244-00-5002-WR | 2 | WATER RETICULATION LAYOUT PLAN - SHEET 2 |
| P24-244-00-5003-WR | 2 | WATER RETICULATION LAYOUT PLAN - SHEET 3 |
| P24-244-00-5500-WR | 2 | FIRE HYDRANT SPACING PLAN |

| | Egodente | dil | |
|--------|--------------------------------|--|--------------------------------|
| RAMARA | | | |
| | ARATAKI DEVELOPMENT AREA | | |
| | | | |
| | MES | Ma ROAD ZZ | ARATAKI IEVELOPMENT AREA |
| | | | |

| REVISION DETAILS | | INT | DATE | SURVEYED | WOODS |
|------------------|--------------------|-----|-----------|----------|-------|
| 2 | ISSUED FOR CONSENT | ТВ | JUNE 2025 | DESIGNED | ТВ |
| | | | | DRAWN | ТВ |
| | | | | CHECKED | BLO |
| | | | | APPROVED | BF |



BUILDING B, LEVEL 1 8 NUGENT ST, GRAFTON, AUCKLAND 1023 +64 9 308 9229



ARATAKI DEVELOPMENT - HAVELOCK NORTH

DRAWING INDEX


| | STATUS | ISSUED FOR CONSENT |
|------------------|---------|---------------------------|
| | SCALE | 1:5000 @ A3 |
| (\overline{N}) | COUNCIL | HASTINGS DISTRICT COUNCIL |
| | DWG NO | P24-244-00-0000-GE |

OODS Est.1970

Plot Date:

.VELOCK NORTH_21690\02 DRAWINGS\01 ENG\P24-244-00-0000-DRAWING IN

SHOWN AS BURDENED LAND PURPOSE CREATED BY RIGHT TO DRAIN ARFA A DP 11544178.6 SEWAGE RIGHT TO CONVEY AREA A DP 11791202.6 LOT 2 DP 546439 LOT 1 DP 546439 AREA B DP RIGHT TO DRAIN SEWAGE 11791202.6 546439 EXISTING CONSENT NOTICES TO BE CANCELLED 11544178.5 AND 11791202.5

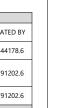

WOODS

AMALGAMATION CONDITIONS LOT 2000 (LEGAL ACCESS) IS TO BE HELD AS 2 UNDIVIDED HALF SHARES BY THE OWNERS OF LOTS 121-122 HEREON AS TENANTS IN COMMON IN THE SAID SHARES AND THAT NDIVIDUAL RECORDS OF TITLE BE ISSUED IN ACCORDANCE

LOT 2001 (LEGAL ACCESS) IS TO BE HELD AS 2 UNDIVIDED HALF SHARES BY THE OWNERS OF LOTS 19-20 HEREON AS TENANTS IN COMMON IN THE SAID SHARES AND THAT INDIVIDUAL RECORDS OF TITLE BE ISSUED IN ACCORDANCE THEREWITH.

LOT 2002 (LEGAL ACCESS) IS TO BE HELD AS 2 UNDIVIDED HALF SHARES BY THE OWNERS OF LOTS 125-126 HEREON AS TENANTS IN COMMON IN THE SAID SHARES AND THAT INDIVIDUAL RECORDS OF TITLE BE ISSUED IN ACCORDANCE THEREWITH

LOT 2003 (LEGAL ACCESS) IS TO BE HELD AS 2 UNDIVIDED HALF SHARES BY THE OWNERS OF LOTS 127-128 HEREON AS TENANTS IN COMMON IN THE SAID SHARES AND THAT INDIVIDUAL RECORDS OF TITLE BE ISSUED IN ACCORDANCE THEREWITH.

LOT 2004 (LEGAL ACCESS) IS TO BE HELD AS 2 UNDIVIDED HALF SHARES BY THE OWNERS OF LOTS 140-141 HEREON AS TENANTS IN COMMON IN THE SAID SHARES AND THAT INDIVIDUAL RECORDS OF TITLE BE ISSUED IN ACCORDANCE THEREWITH.

LOT 2005 (LEGAL ACCESS) IS TO BE HELD AS 2 UNDIVIDED HALF SHARES BY THE OWNERS OF LOTS 142-143 HEREON AS TENANTS IN COMMON IN THE SAID SHARES AND THAT INDIVIDUAL RECORDS OF TITLE BE ISSUED IN ACCORDANCE THEREWITH

LOT 2006 (LEGAL ACCESS) IS TO BE HELD AS 2 UNDIVIDED HALF SHARES BY THE OWNERS OF LOTS 71-72 HEREON AS TENANTS IN COMMON IN THE SAID SHARES AND THAT INDIVIDUAL RECORDS OF TITLE BE ISSUED IN ACCORDANCE THEREWITH.

LOT 2007 (LEGAL ACCESS) IS TO BE HELD AS 2 UNDIVIDED HALF SHARES BY THE OWNERS OF LOTS 152-153 HEREON AS TENANTS IN COMMON IN THE SAID SHARES AND THAT INDIVIDUAL RECORDS OF TITLE BE ISSUED IN ACCORDANCE THEREWITH.

LOT 2008 (LEGAL ACCESS) IS TO BE HELD AS 9 UNDIVIDED ONE-NINTH SHARES BY THE OWNERS OF LOTS 34-37, 40 & 42-45 HEREON AS TENANTS IN COMMON IN THE SAID SHARES AND THAT INDIVIDUAL RECORDS OF TITLE BE ISSUED IN ACCORDANCE THEREWITH.

LOT 2009 (LEGAL ACCESS) IS TO BE HELD AS 6 UNDIVIDED ONE-SIXTH SHARES BY THE OWNERS OF LOTS 103-104, 109,111, 113 & 115 HEREON AS TENANTS IN COMMON IN THE SAID SHARES AND THAT INDIVIDUAL RECORDS OF TITLE BE ISSUED IN ACCORDANCE THEREWITH.

| Comprised In | RT | Area (ha) | |
|---------------------|----------|-----------|--|
| Appellation | | , | |
| LOT 2 DP 540945 | 908215 | 5.2339 | |
| SECTION 10S SO 1781 | HBM2/265 | 2.9390 | |
| LOT 2 DP 546439 | 930676 | 2.9838 | |

LEGEND

PROPOSED BOUNDARIES

PROPOSED COVENANT AREAS

- SCHEME PLANS SUBJECT TO COUNCIL APPROVAL LOT AREAS AND BOUNDARY DIMENSIONS ARE SUBJECT TO CONFIRMATION UPON FINAL LAND TRANSFER SURVEY.
- 3. ALL ROADS AND ACCESSWAYS ARE TO VEST IN COUNCIL.

DISCLAIMER:
THIS DRAWING IS INTENDED TO BE SOLELY USED AS THE BASE DATA
FOR THE PURPOSES OF THE CLIENT. WOODS ACCEPT NO
RESPONSIBILITY FOR ANY SUBSEQUENT CHANCES MADE TO THIS
DRAWING FILE. THAT ARE DIFFERENT TO THOSE ATTACHED IN THE POF
FORMATTED VERSION SHOWN IN OUR ELECTRONIC CORRESPONDENCE.

| · · · · · · · · · · · · · · · · · · · | |
|--|--------------|
| Stage 1 | Area (Ha) |
| Residential Lots | |
| Lots 1-13, 15-18, 21 & 121-126 | 1.0846 |
| Road to Vest | |
| Lot 3000, 3006 | 0.2418 |
| Jointly Owned Access Lots | |
| Lots 2000, 2002 | 0.0281 |
| Local Purpose (Drainage) Reserve | |
| Lot 1000 | 1.0197 |
| Stage Total | 2.3742 |
| Stage 2 | |
| Residential Lots | |
| Lots 14, 19-20, 22-45, 127-134 | 1.4611 |
| Road to Vest | 1.4011 |
| Lot 3001 | 0.3191 |
| Jointly Owned Access Lots | 0.3131 |
| Lots 2001, 2003 & 2008 | 0.1923 |
| | 0.1923 |
| Accessway to Vest | 0.0=00 |
| Lot 1001 | 0.0539 |
| Stage Total | 2.0264 |
| Stage 3 | |
| Residential Lots | |
| Lots 46-59 & 135-141 | 0.9486 |
| Road to Vest | |
| Lot 3002 | 0.3028 |
| Jointly Owned Access Lots | |
| Lot 2004 | 0.0205 |
| Stage Total | 1.2719 |
| Stage 4 | |
| Residential Lots | |
| Lots 60-89 & 142-151 | 1.8922 |
| Road to Vest | |
| Lot 3003 | 0.5180 |
| Jointly Owned Access Lots | |
| Lots 2005-2006 | 0.0269 |
| To Vest As Accessway | |
| Lot 1002 | 0.0610 |
| Total | 2.4981 |
| Stage 5 | |
| Residential Lots | |
| Lots 90-99, 107-108, 110, 112, 114, | 1.0750 |
| 116 & 152-159 | , 50 |
| Road to Vest | 0.2200 |
| Lot 3004 | 0.3290 |
| Jointly Owned Access Lots | |
| Lot 2007 | 0.0045 |
| Total | 1.4085 |
| Stage 6 | |
| Residential Lots | |
| Lots 100-106, 109, 111, 113, 115, 117-120 & 160-171 | 1.2281 |
| Road to Vest | |
| Lot 3005 | 0.2522 |
| Jointly Owned Access Lots | |
| | |

Lot 2009

0.0949 1.5752

| REVISION DETAILS | | INT | DATE | SURVEYED | WOODS | |
|------------------|---|--------------------|------|-----------|----------|-------|
| | 2 | ISSUED FOR CONSENT | KR | JUNE 2025 | DESIGNED | WOODS |
| | | | | | DRAWN | CC |
| | | | | | CHECKED | KR |
| | | | | | APPROVED | KR |



BUILDING B, LEVEL 1 8 NUGENT ST, GRAFTON AUCKLAND 1023 +64 9 308 9229 WOODS CO N7





ARATAKI DEVELOPMENT - HAVELOCK NORTH


SCHEME PLAN


| | S |
|-----|---|
| | S |
| N) | C |
| | [|


| <u> </u> | 30 00 | 130 |
|----------|---------------------------|-----|
| STATUS | ISSUED FOR CONSENT | REV |
| SCALE | 1:3000 @ A3 | 2 |
| COUNCIL | HASTINGS DISTRICT COUNCIL | 2 |
| DWG NO | P24-244-00-0001-SC | |

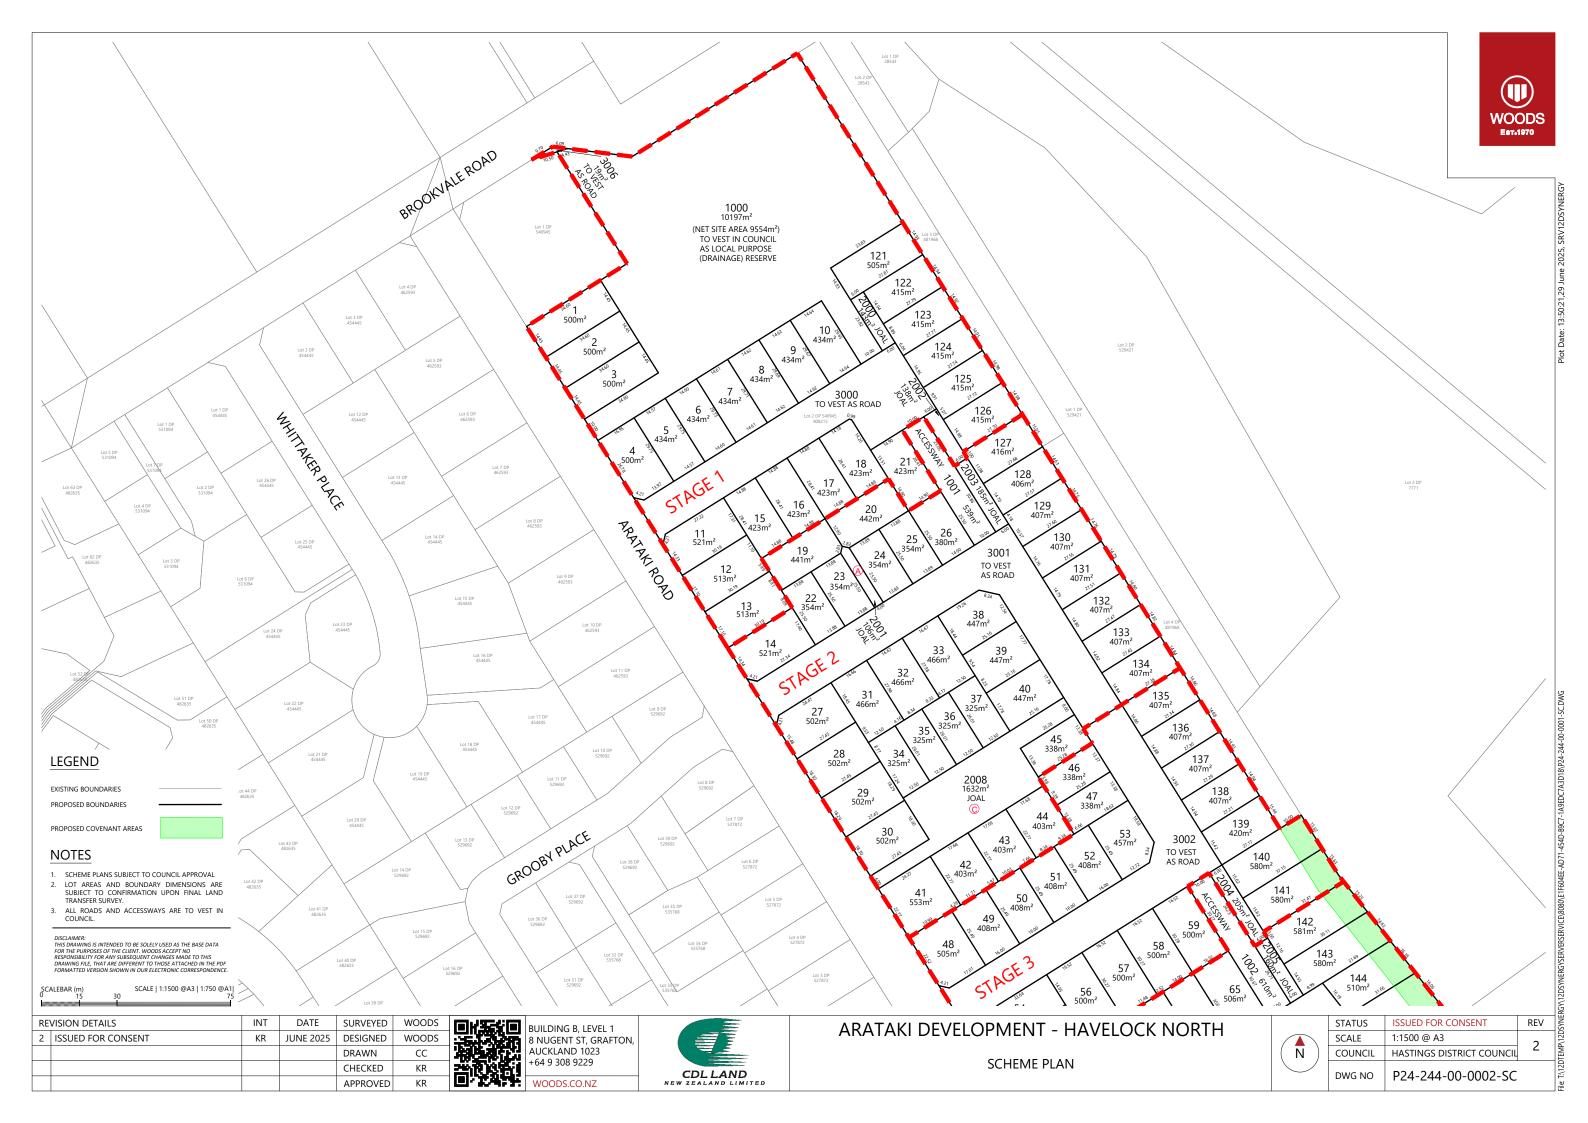

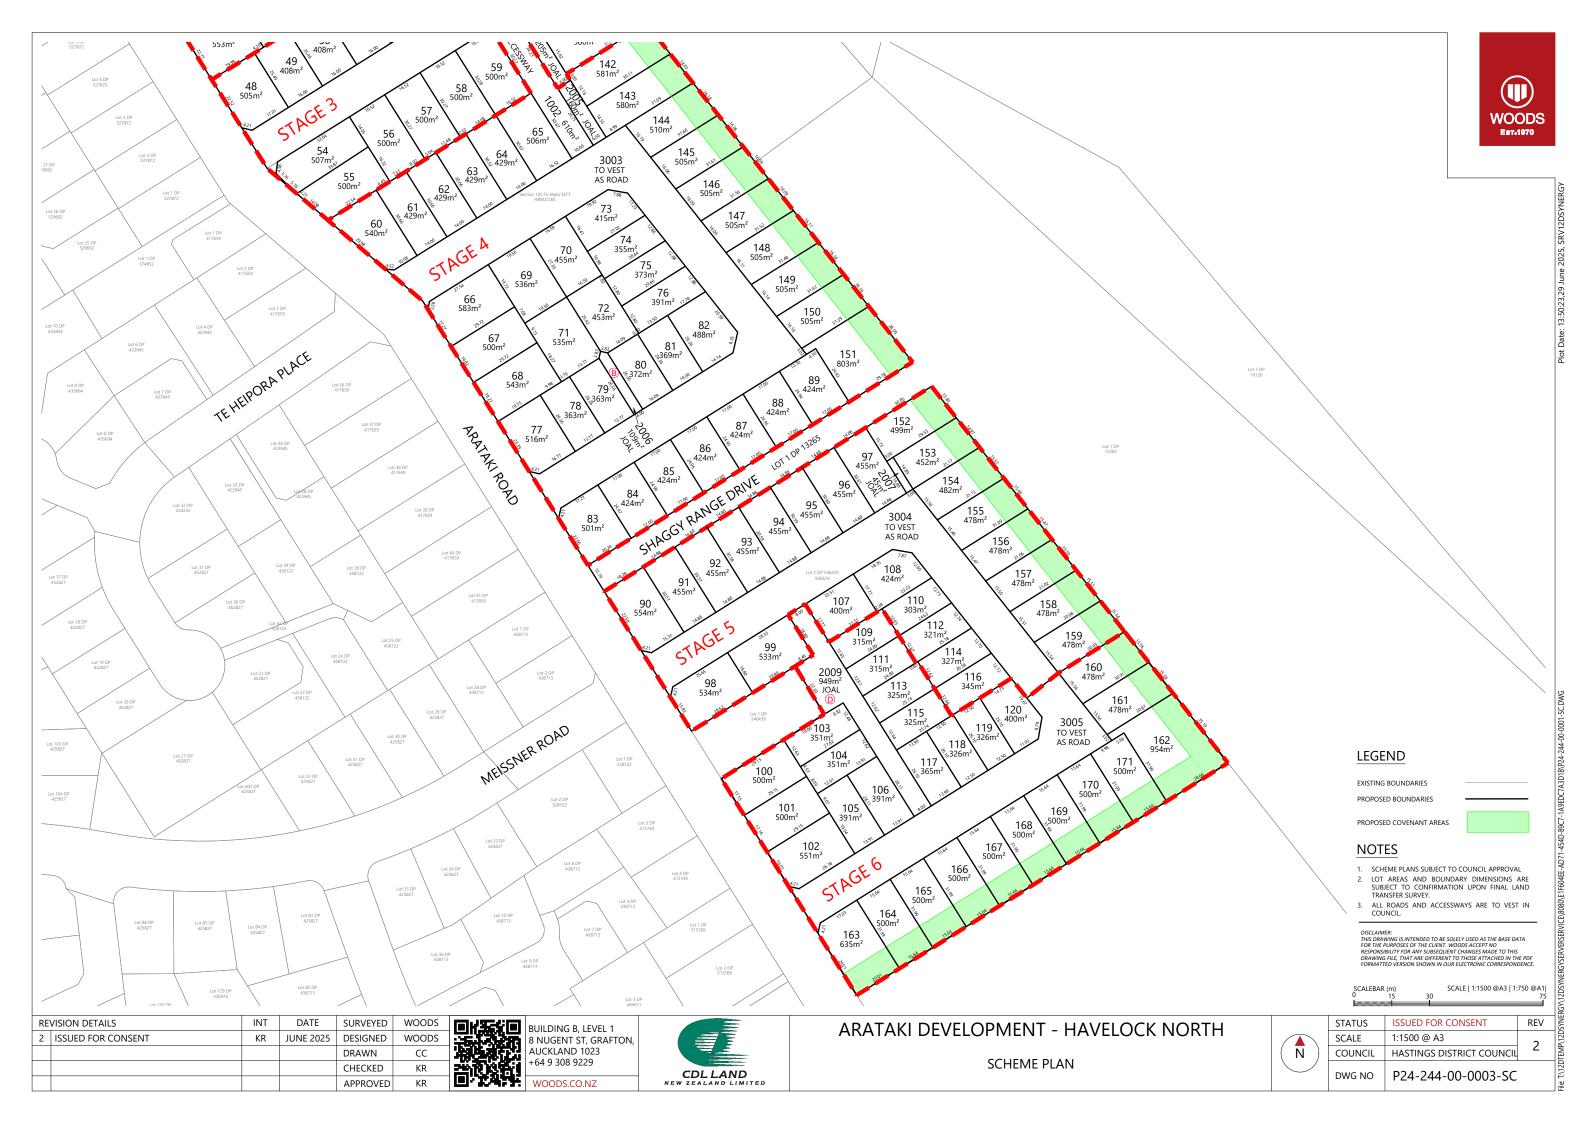


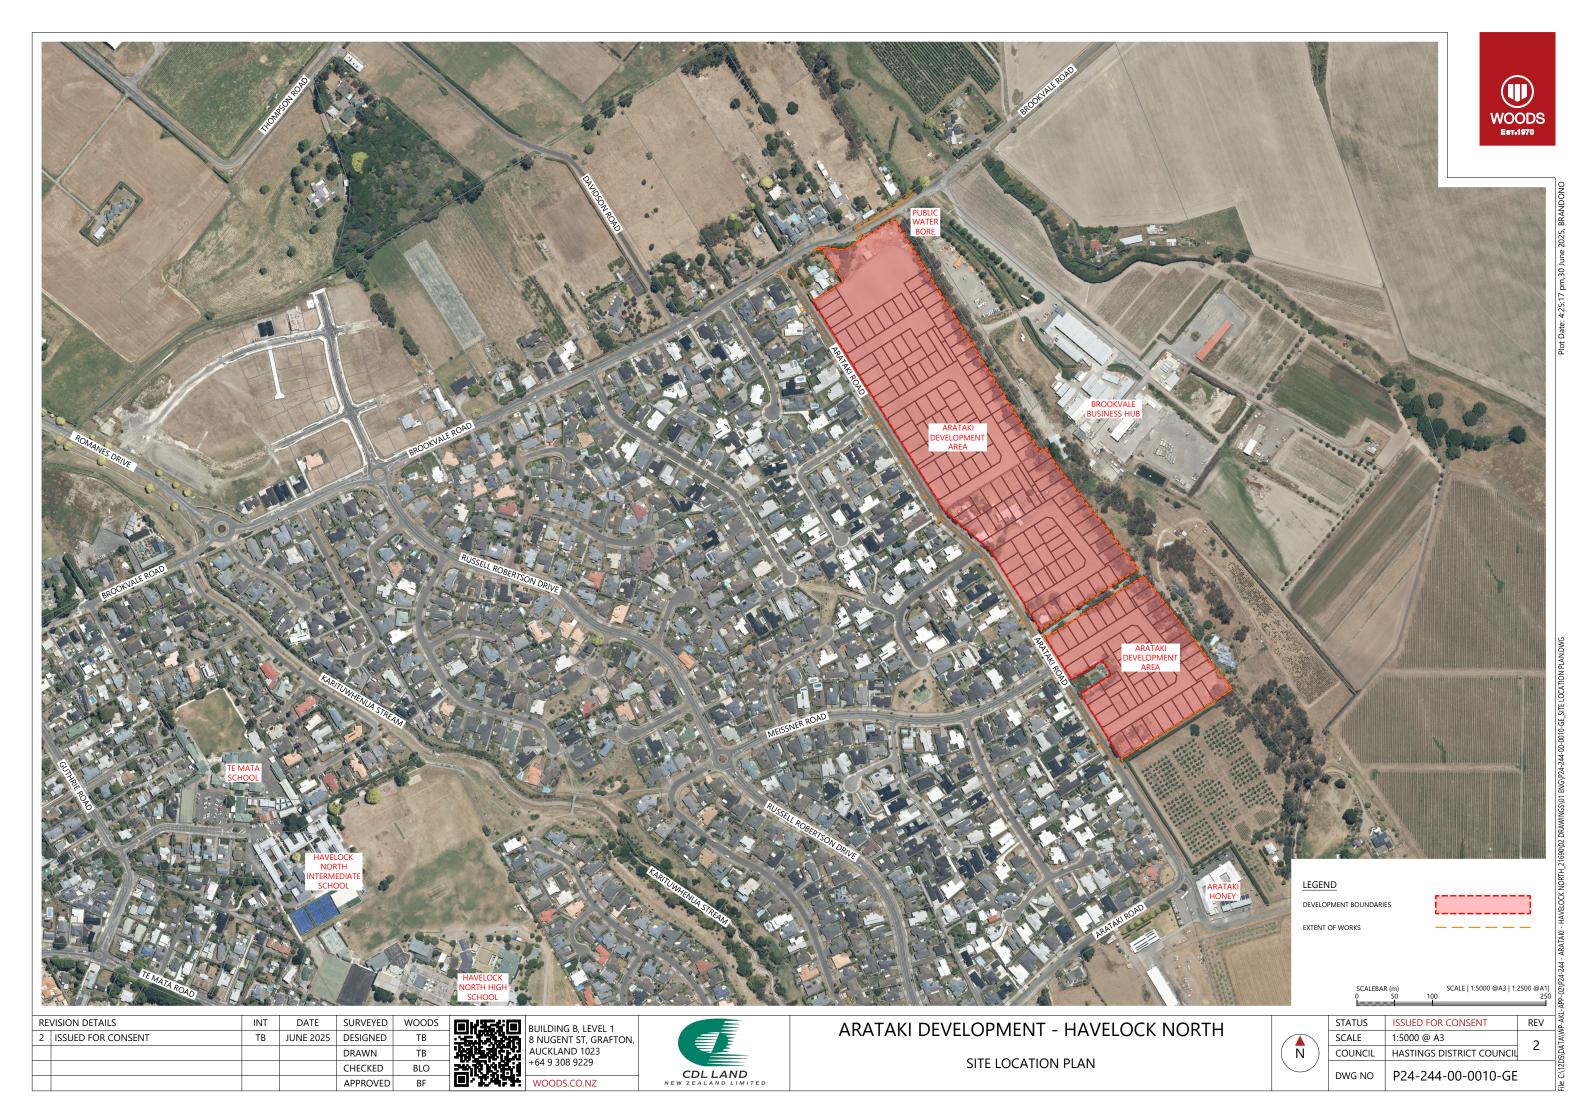


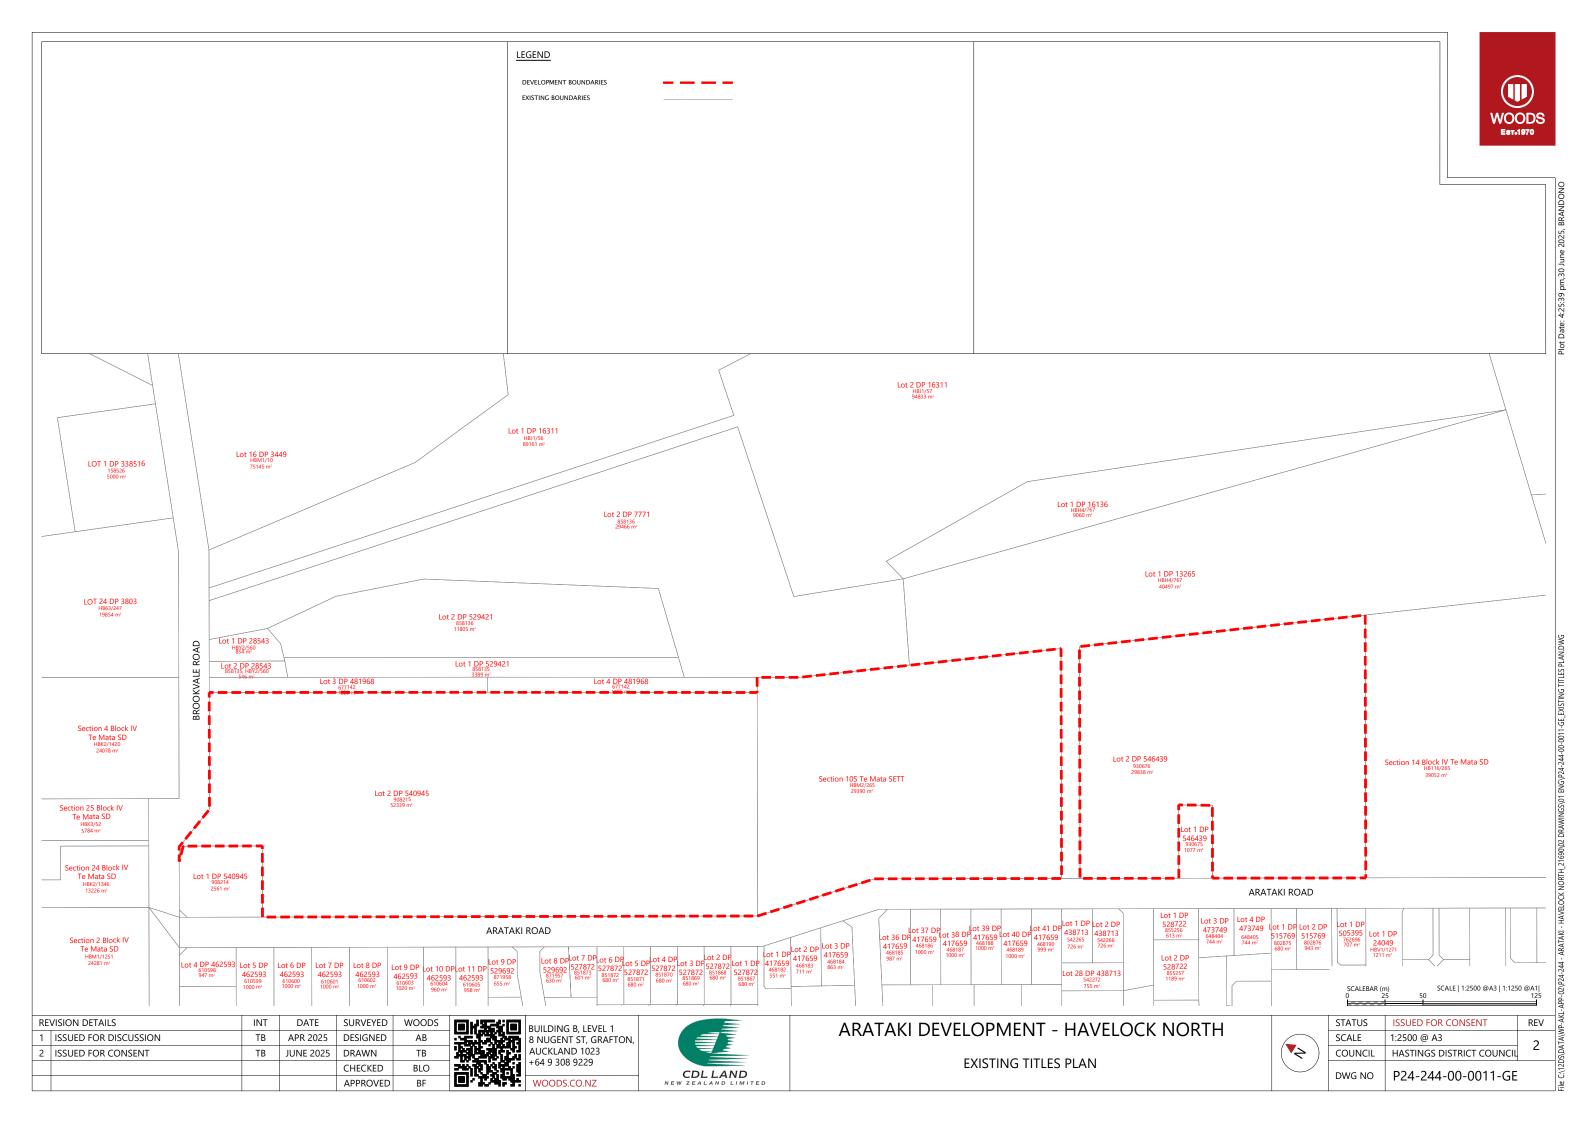

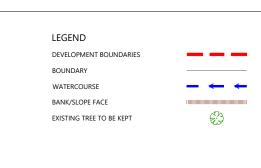




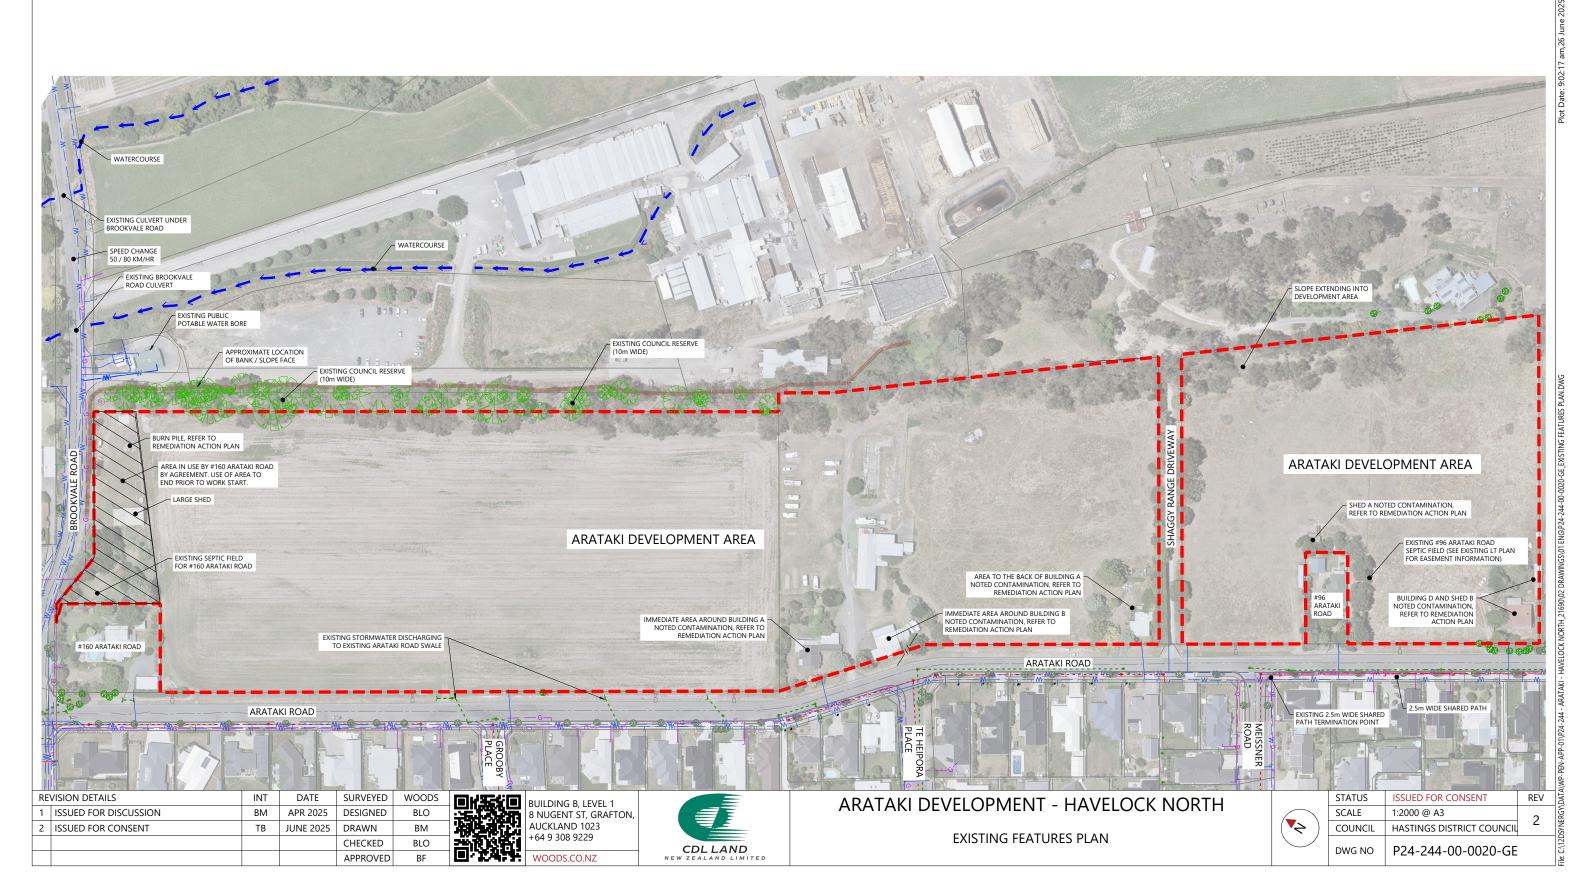


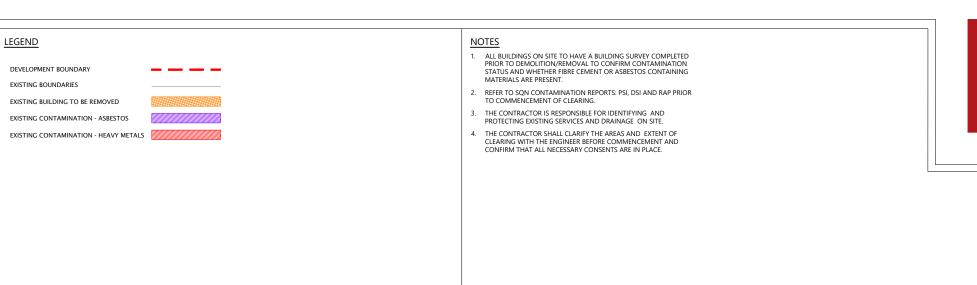



WOODS

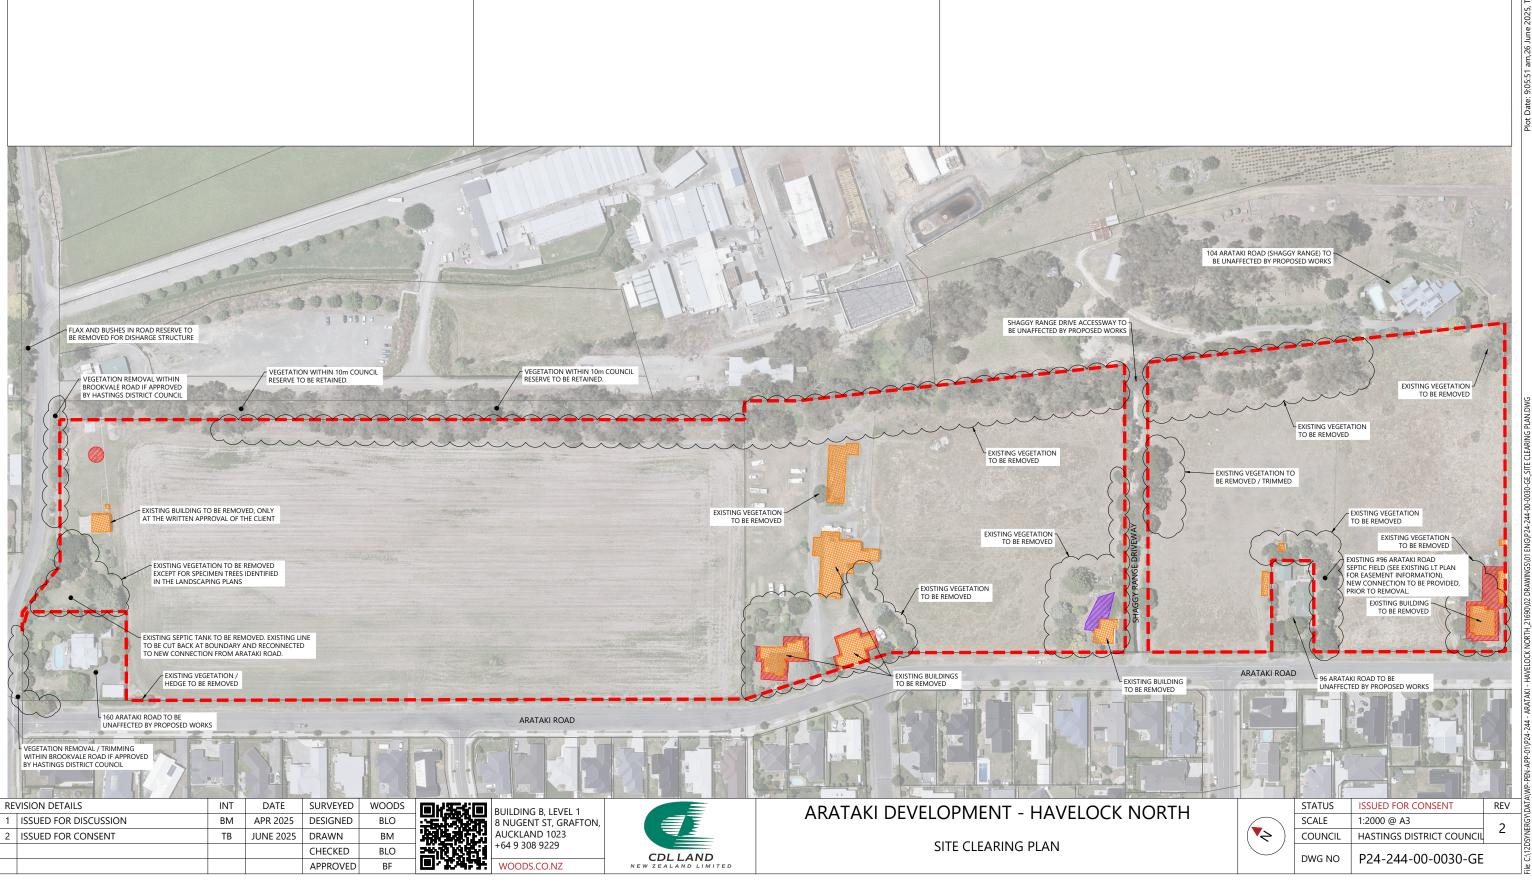



2 ISSUED FOR CONSENT

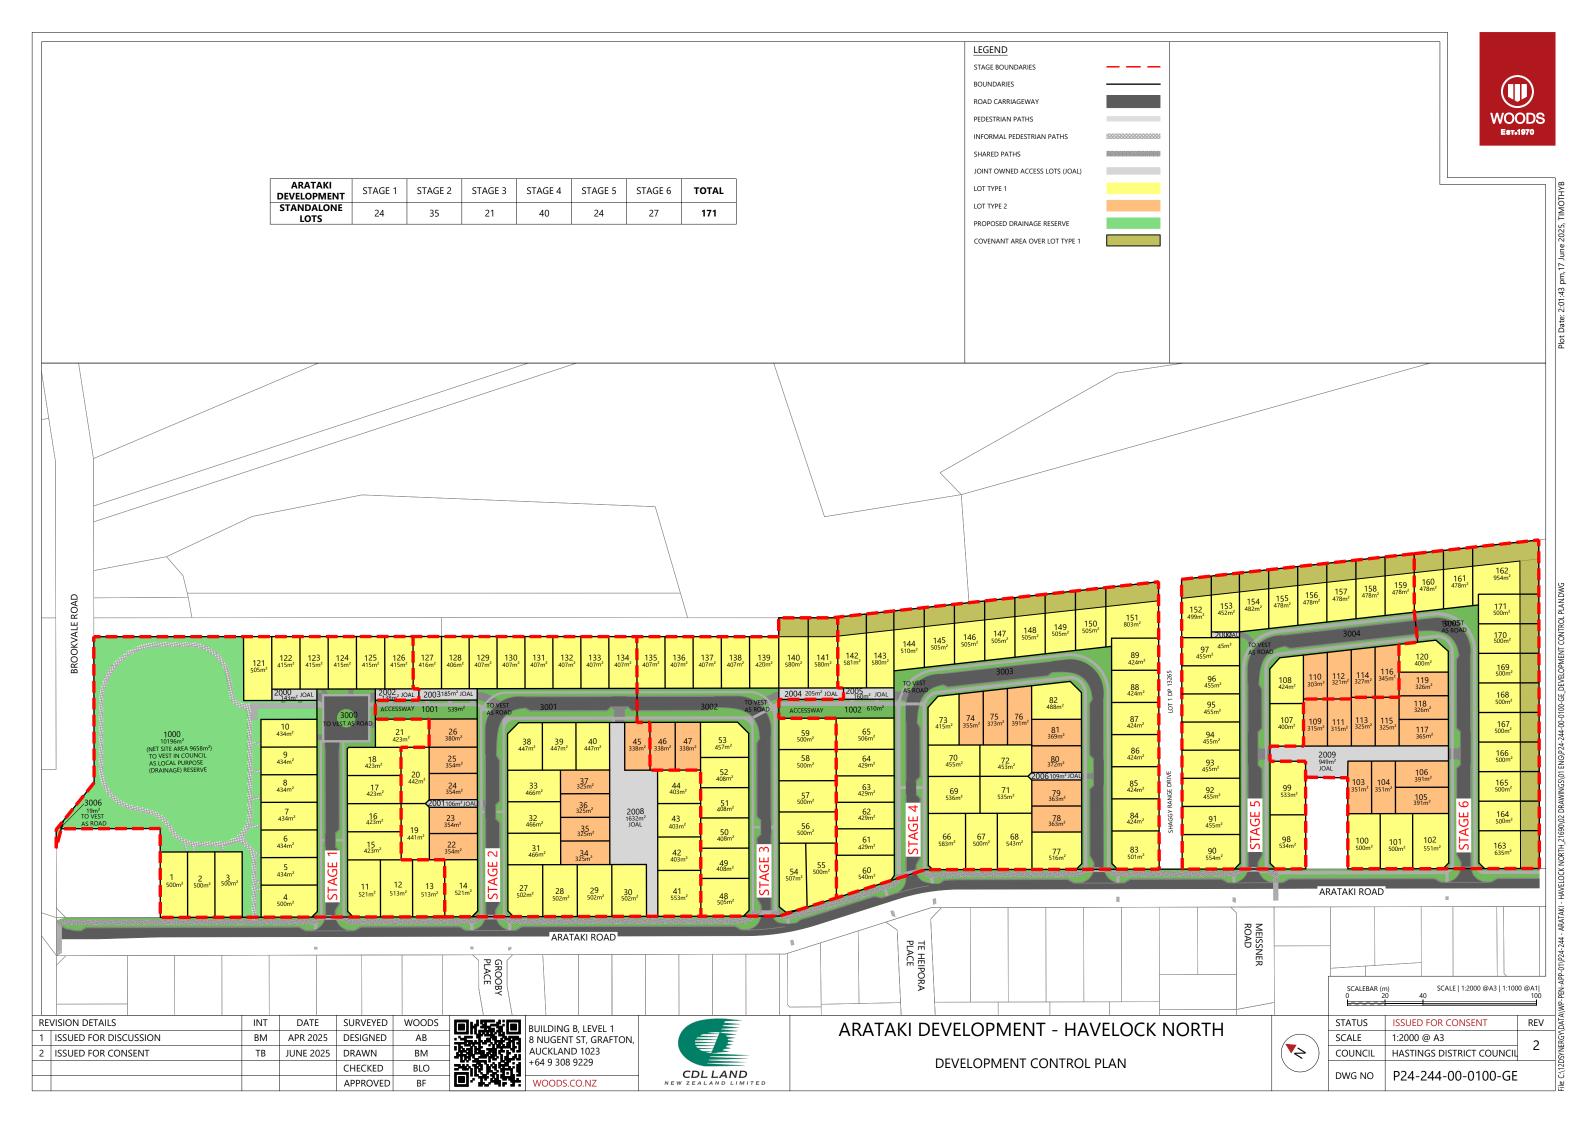


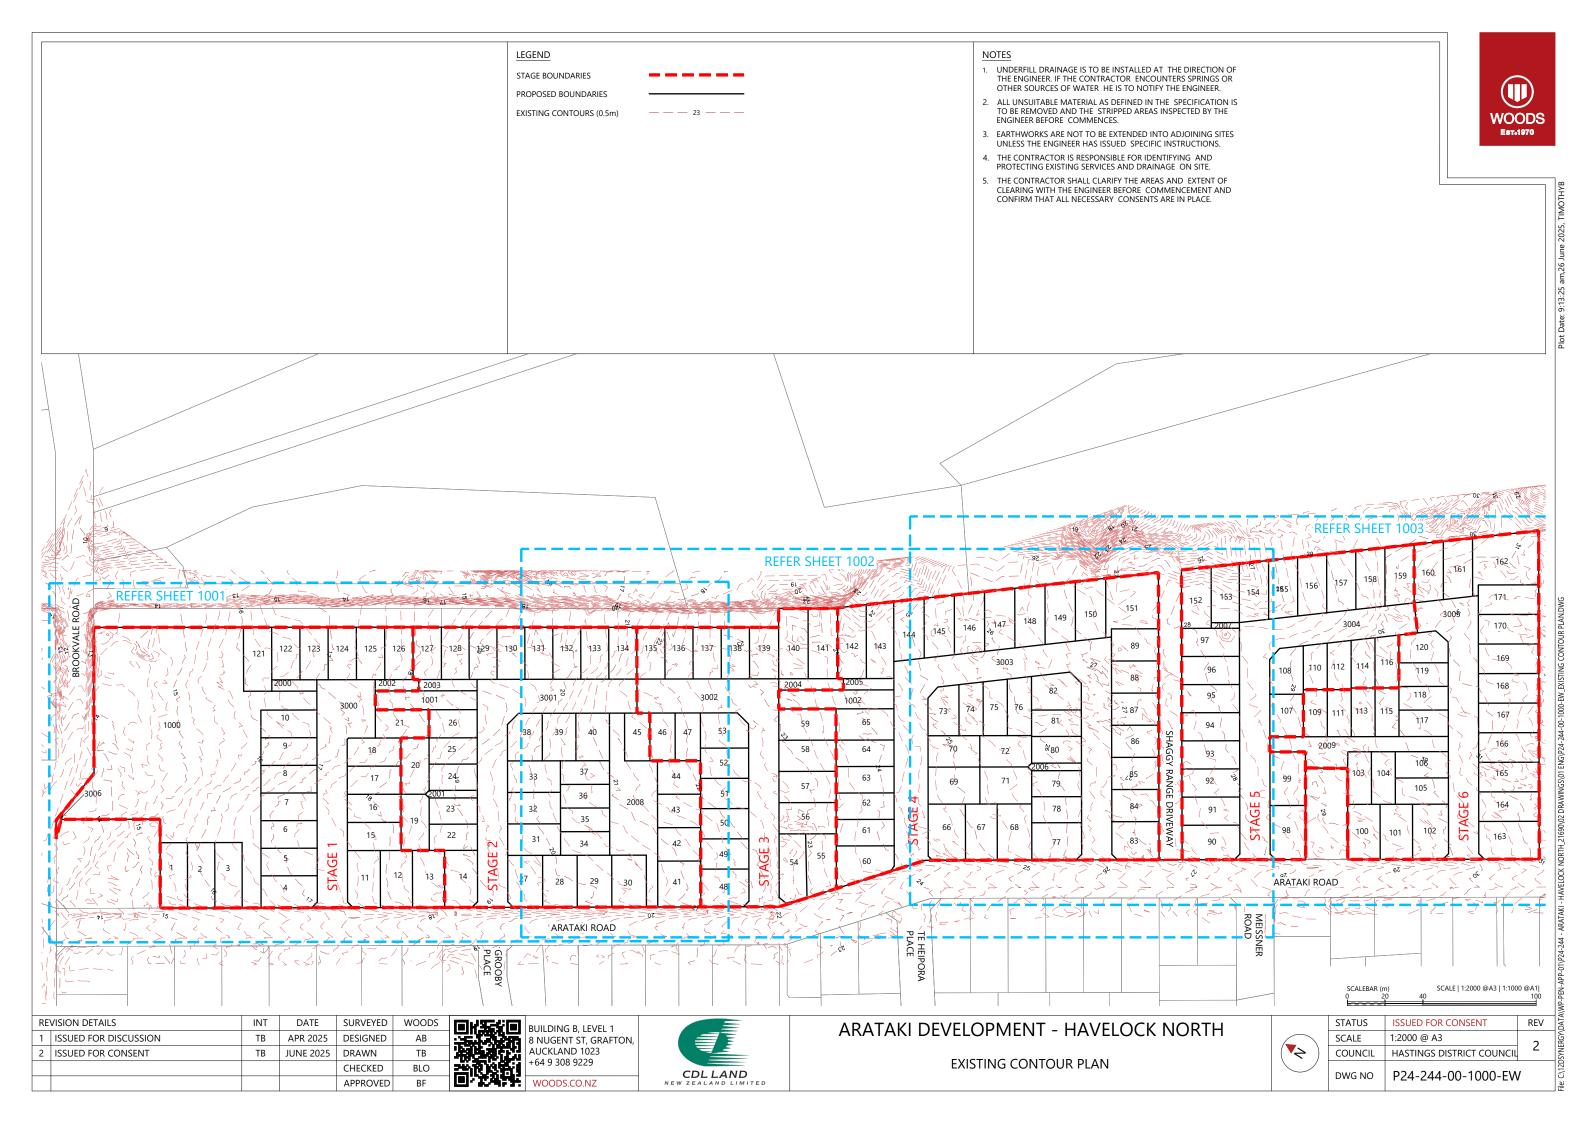


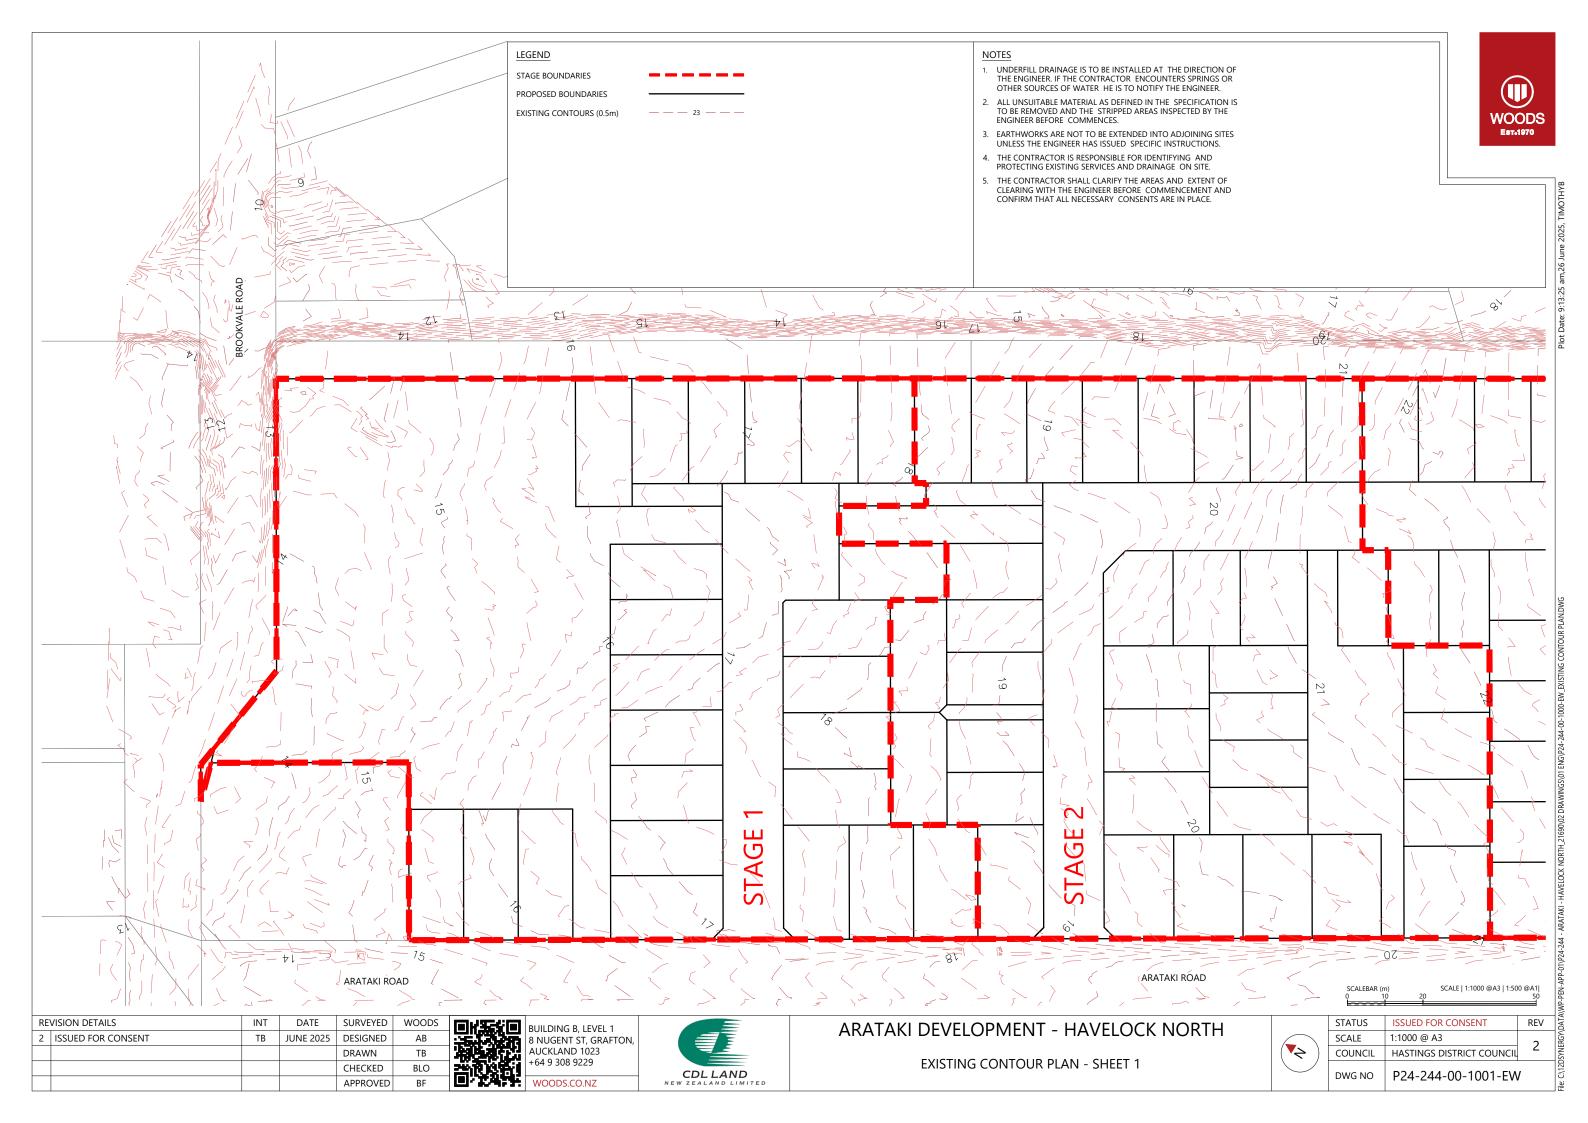


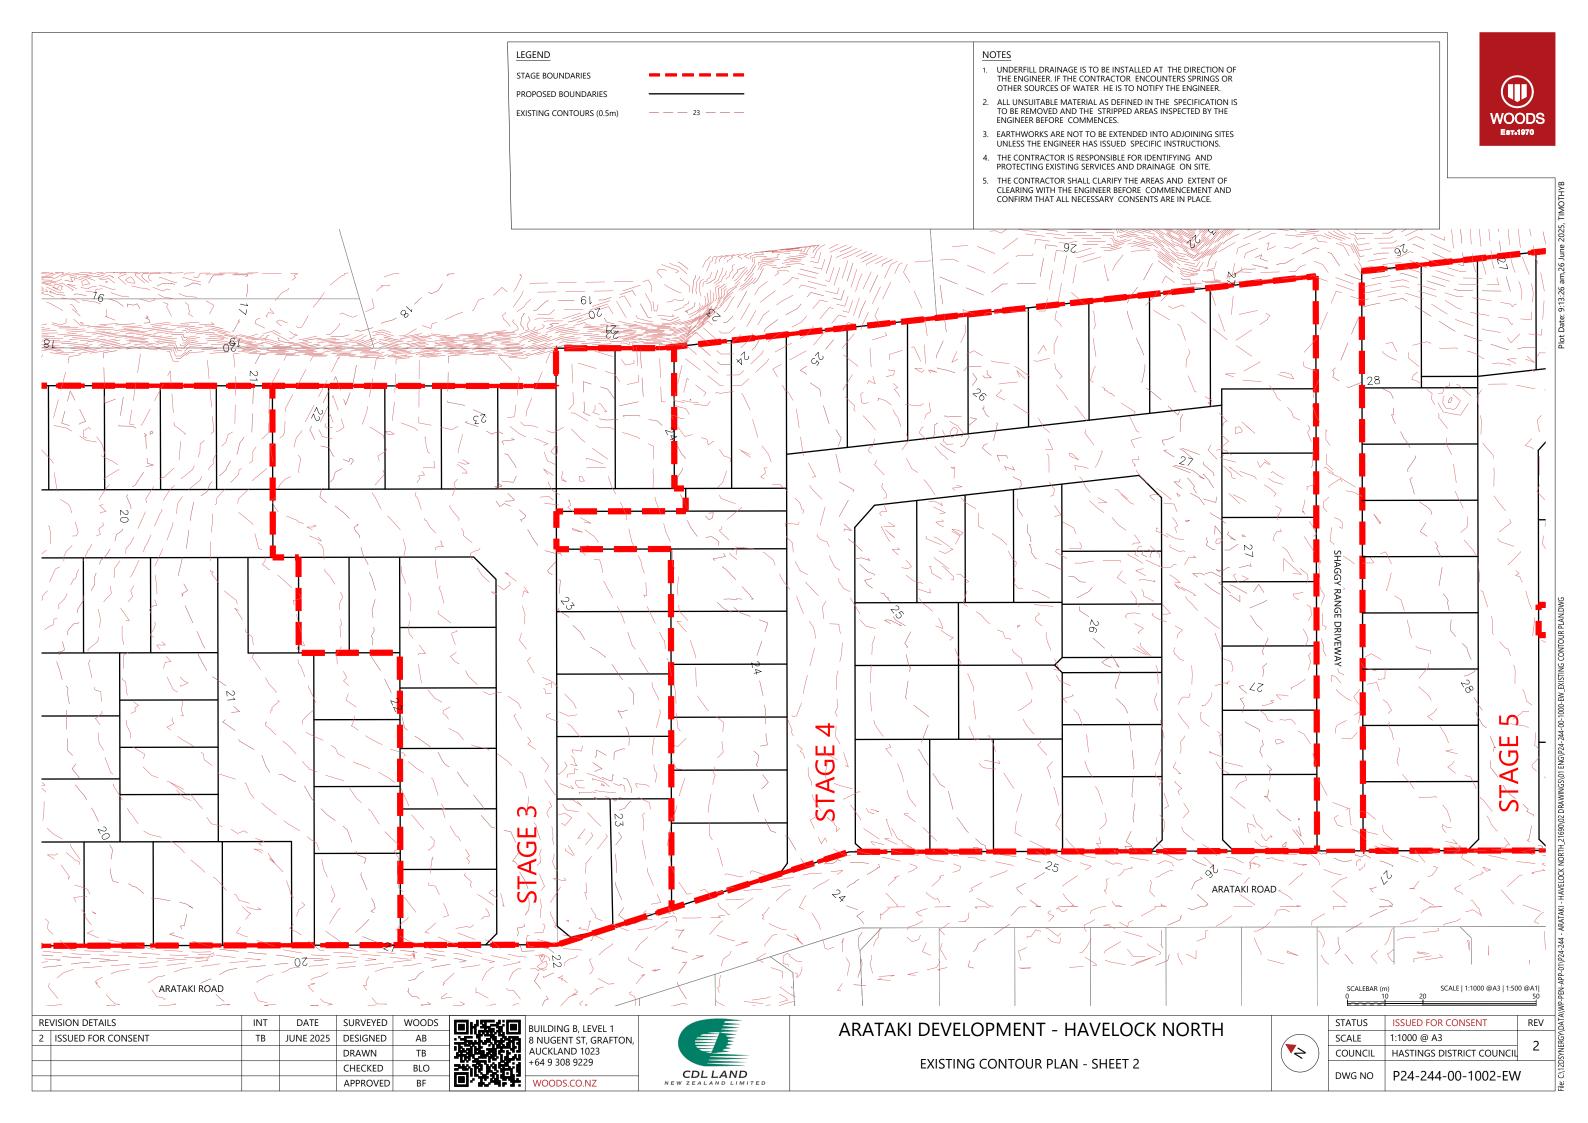


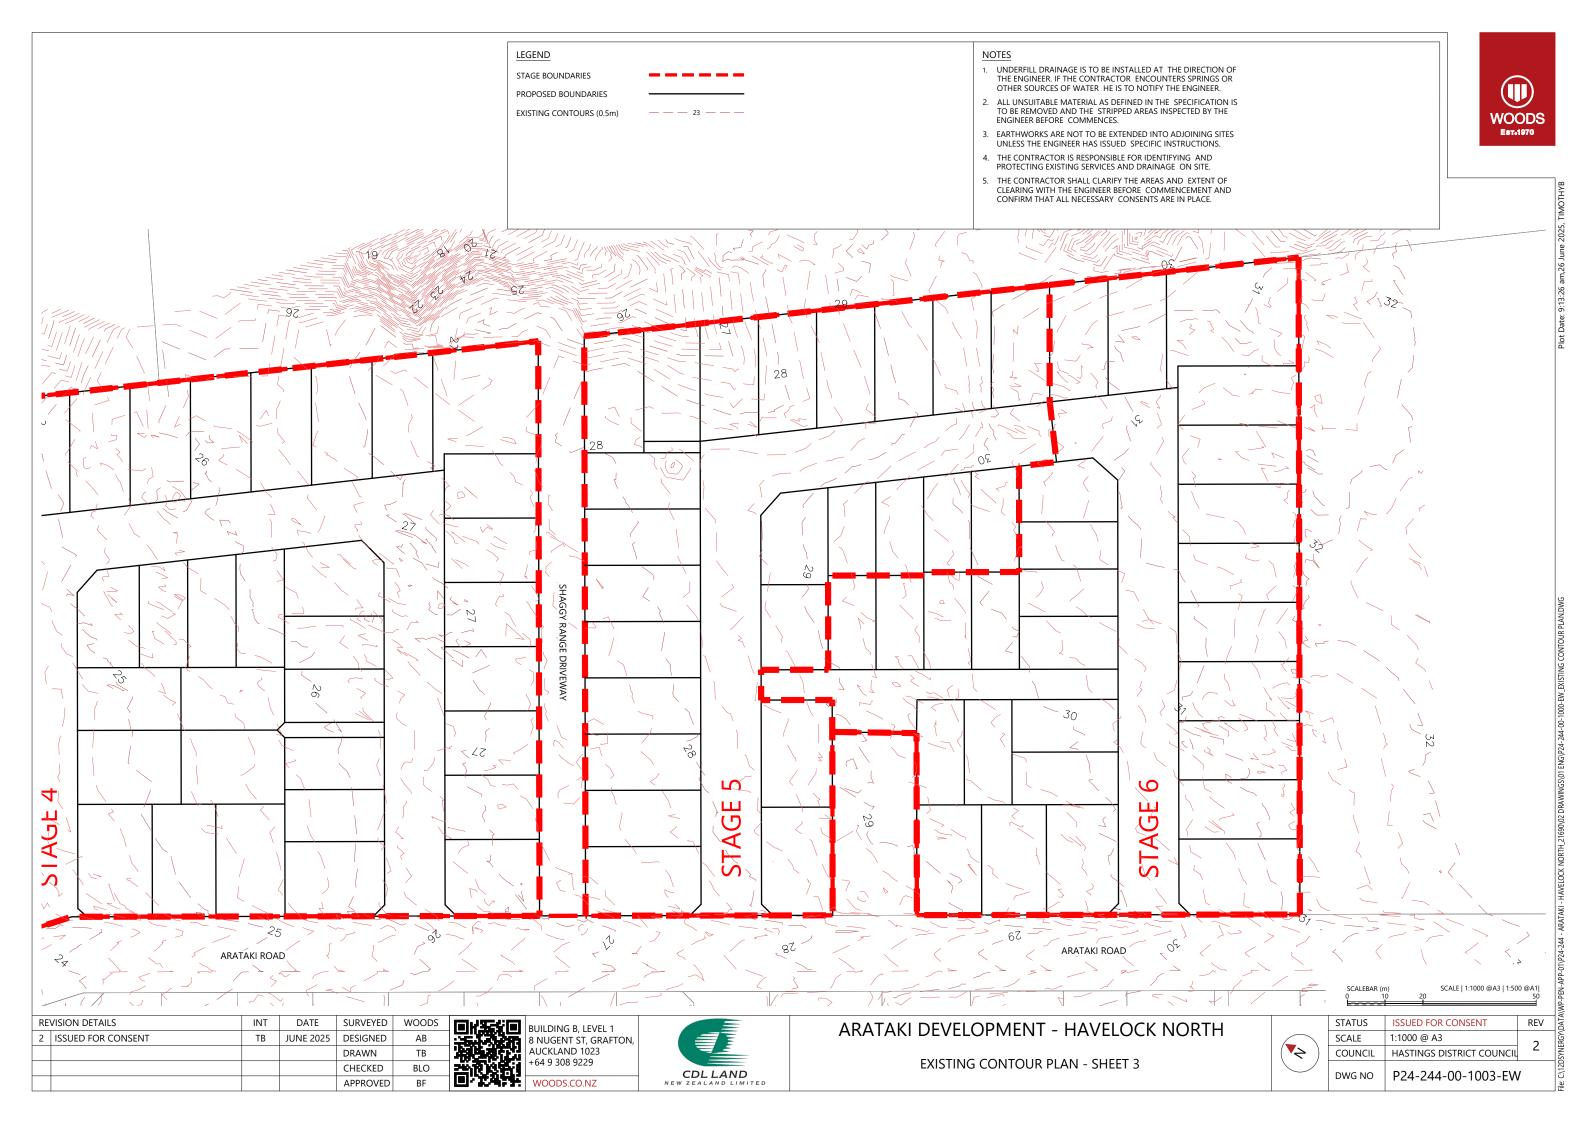


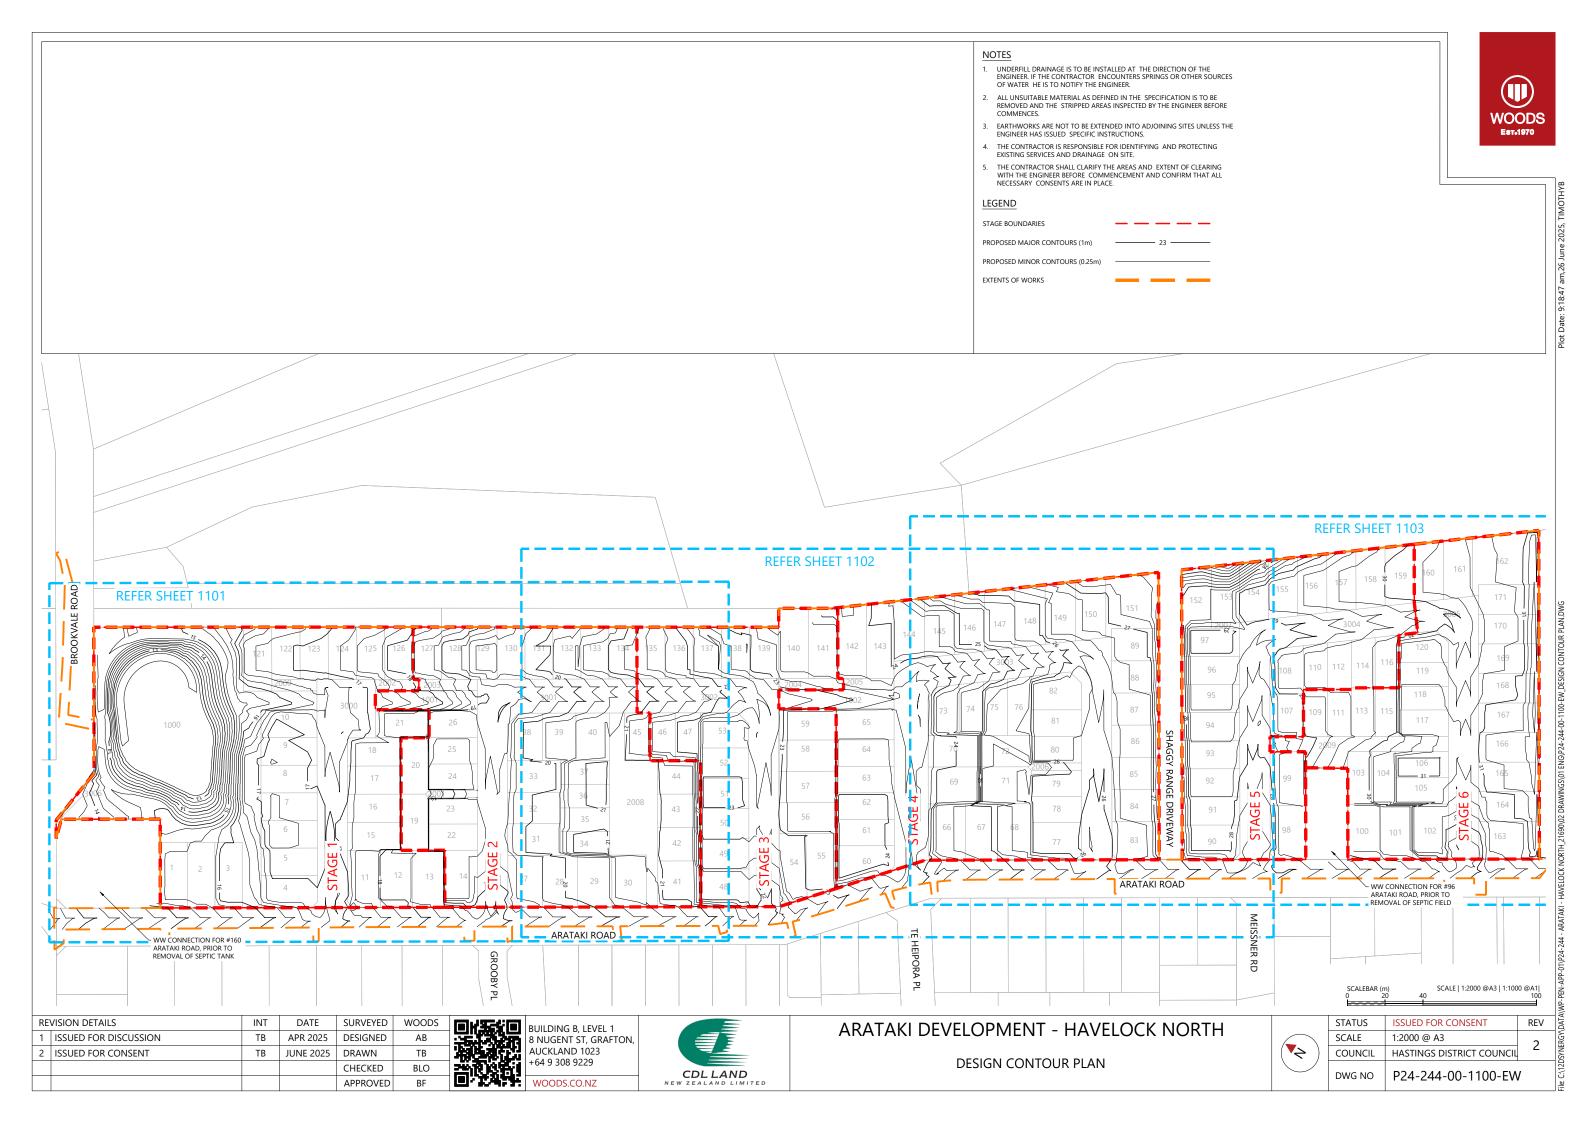


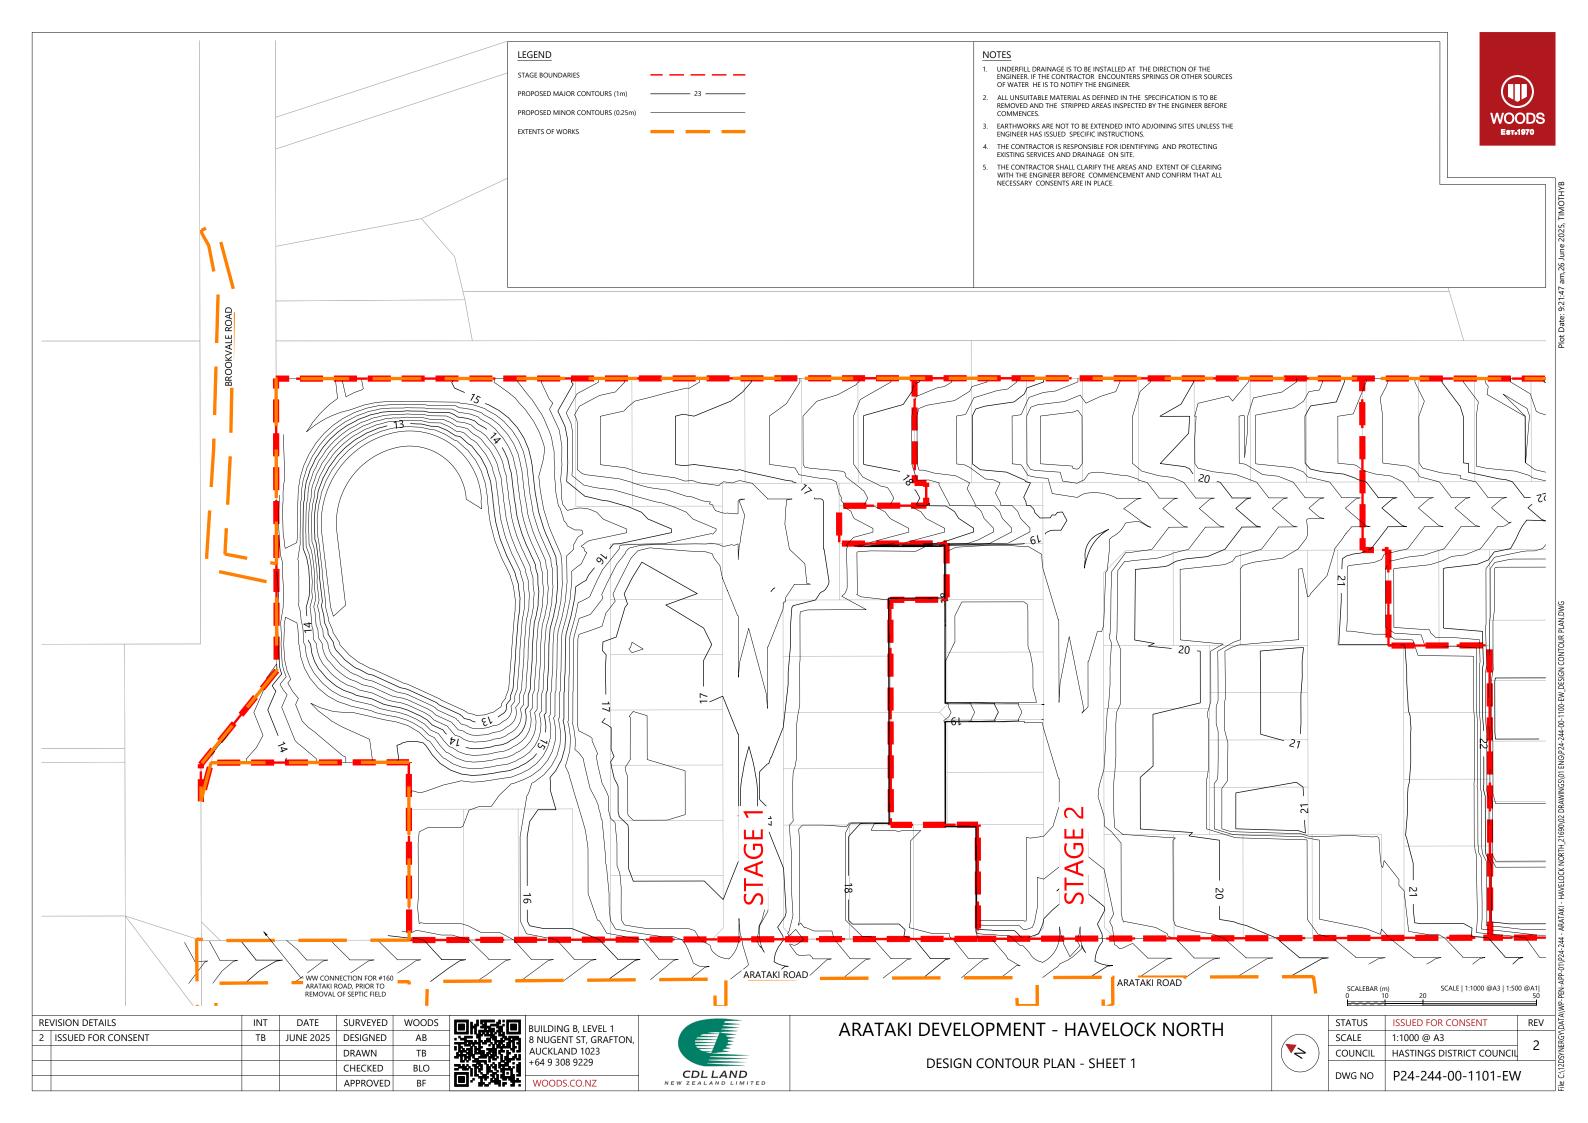


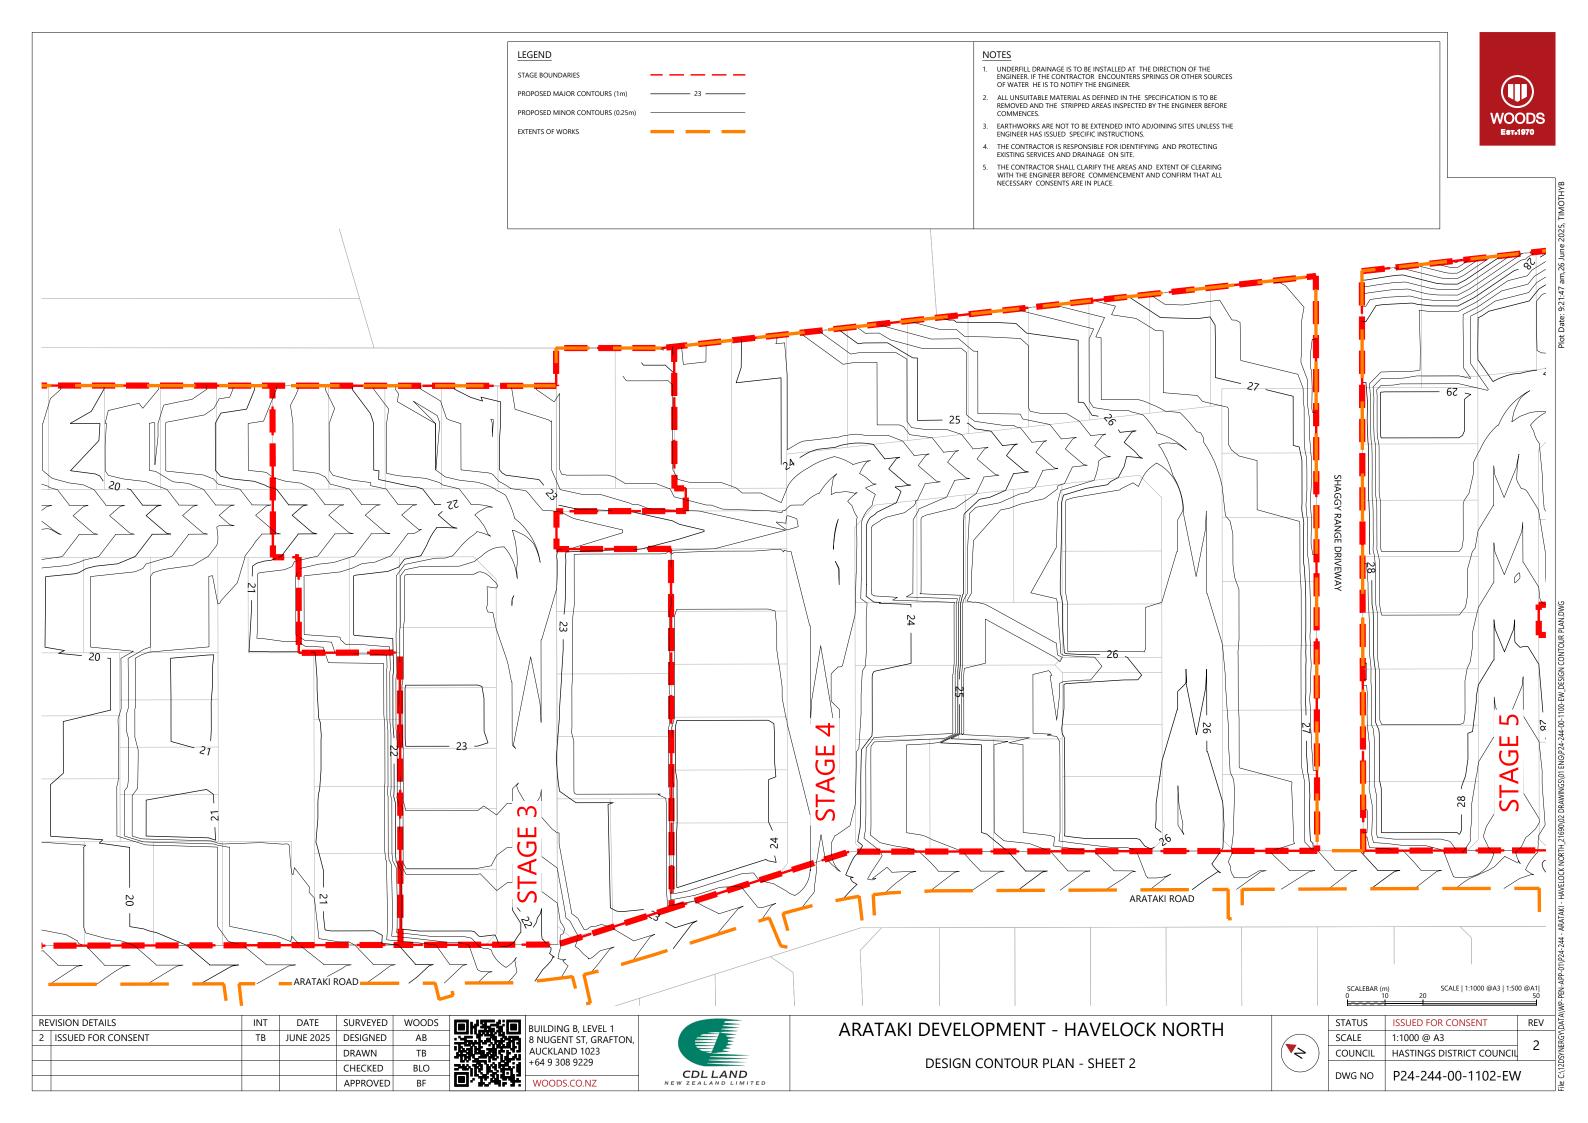


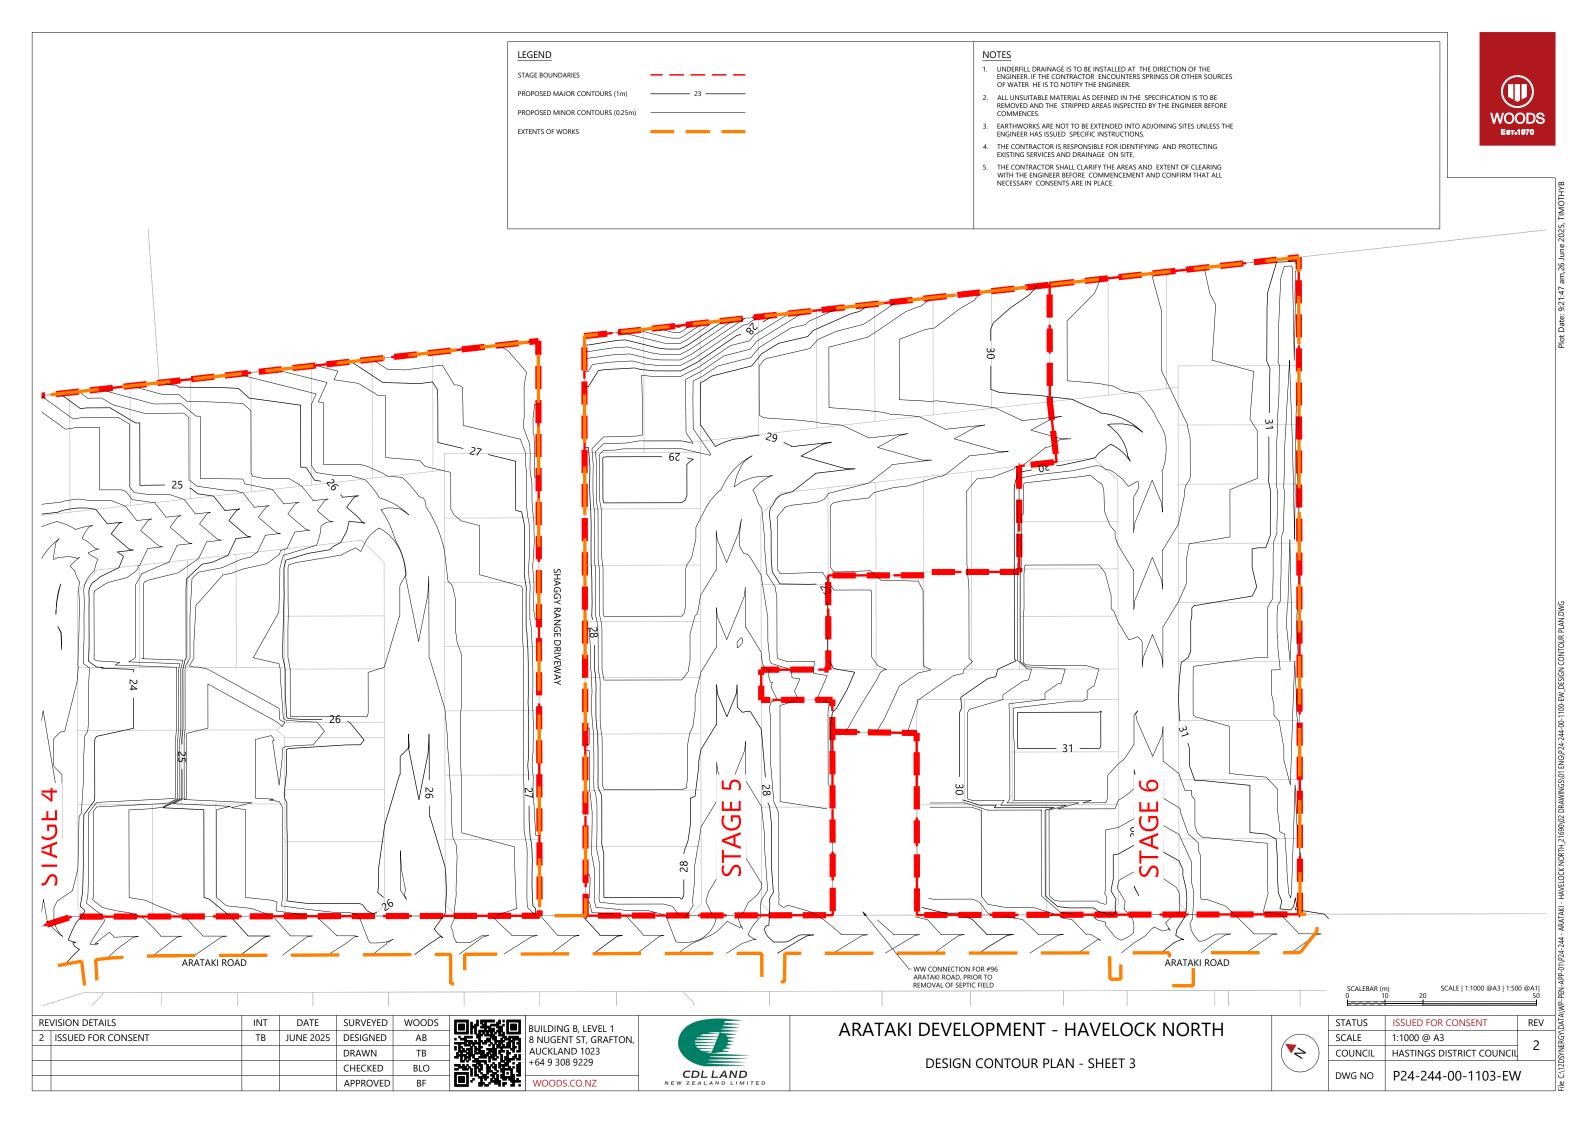


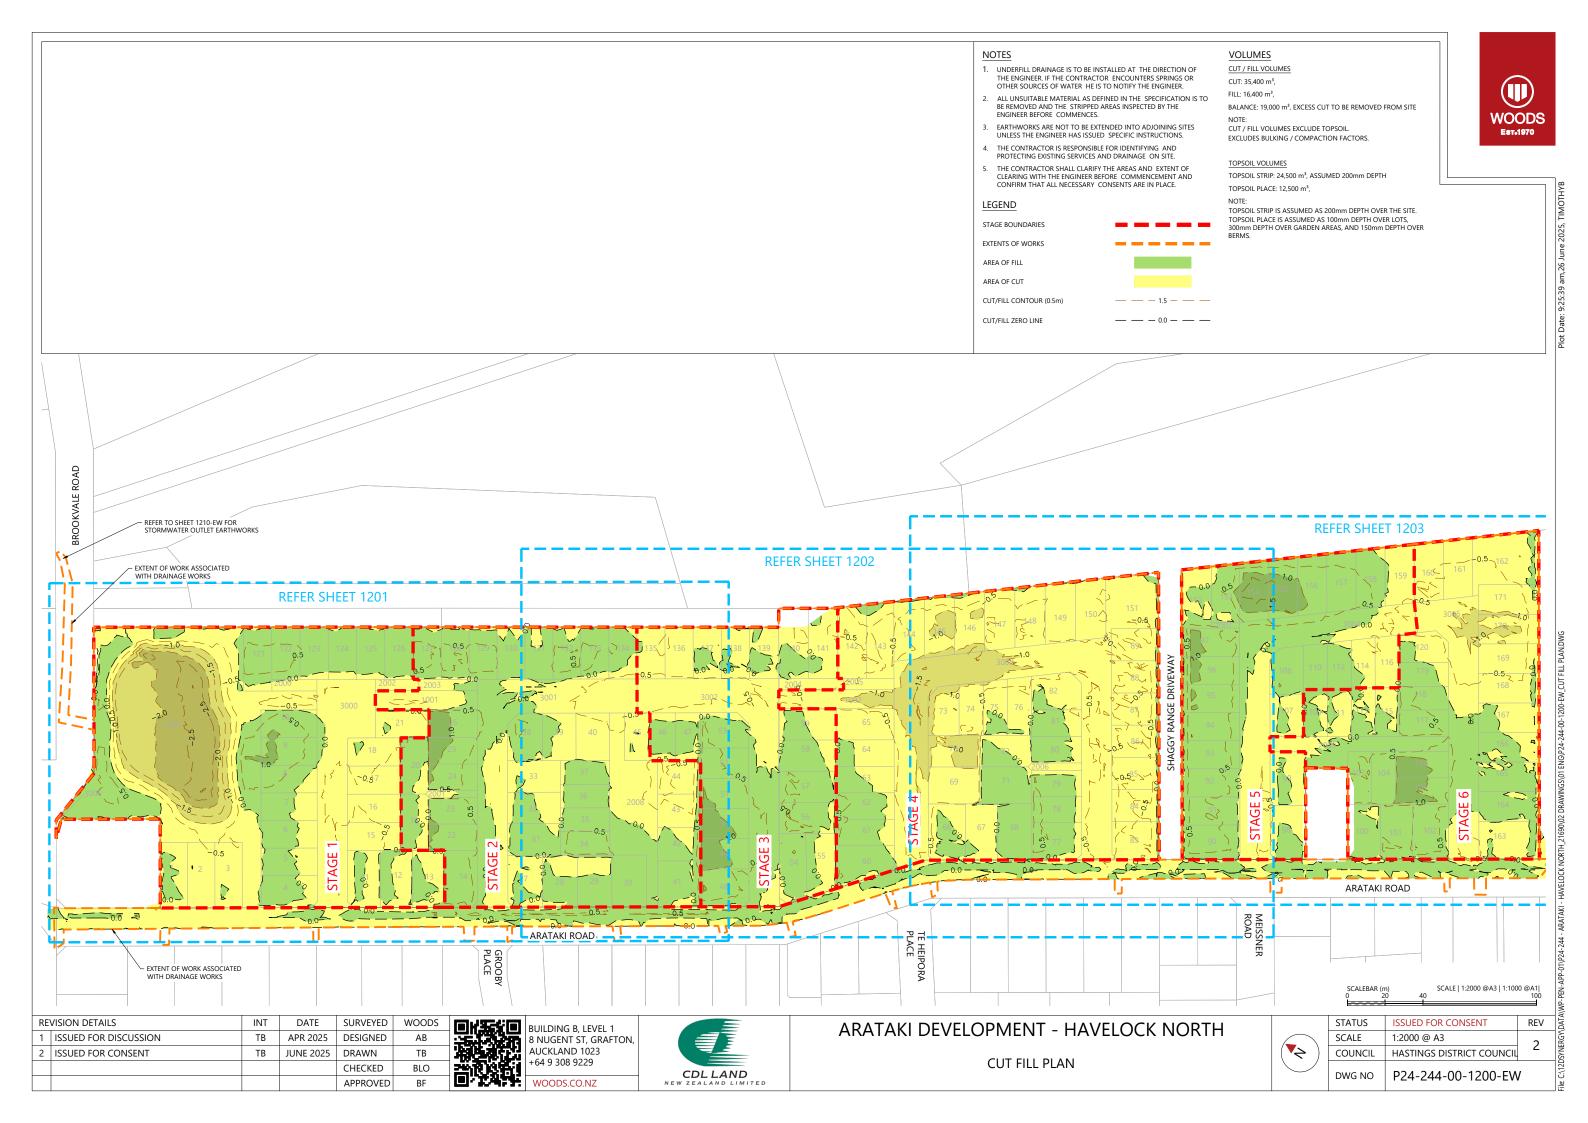


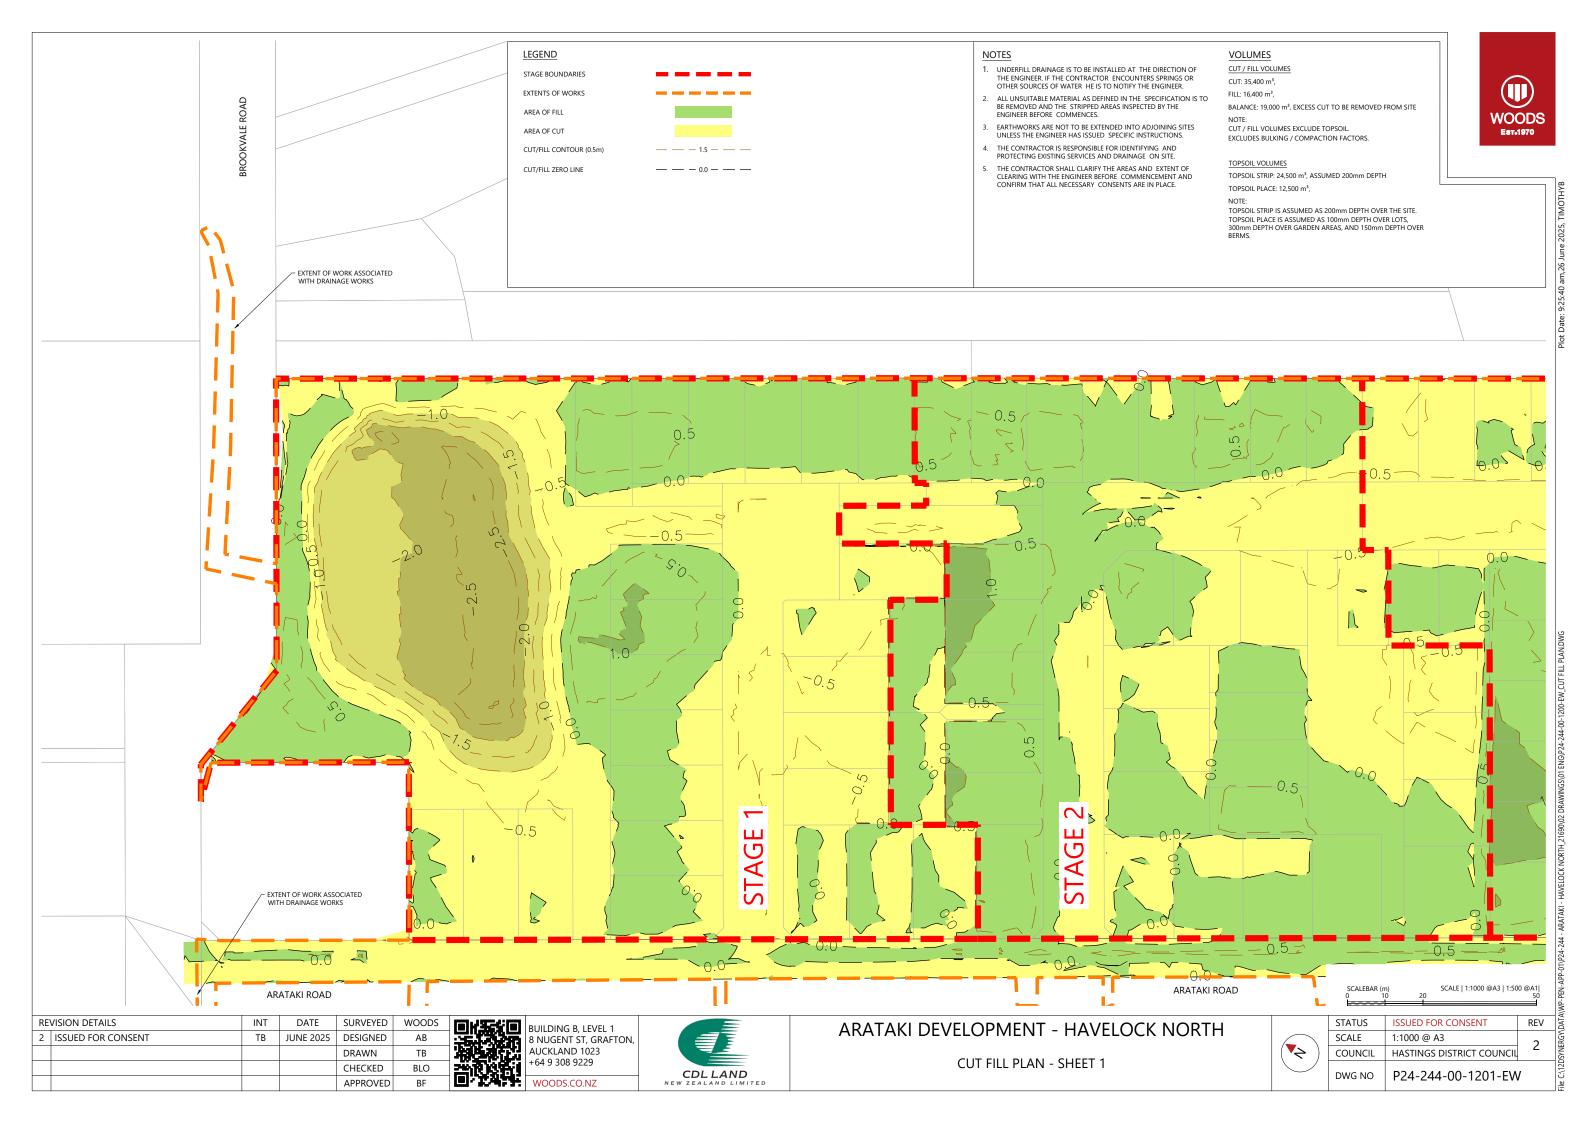

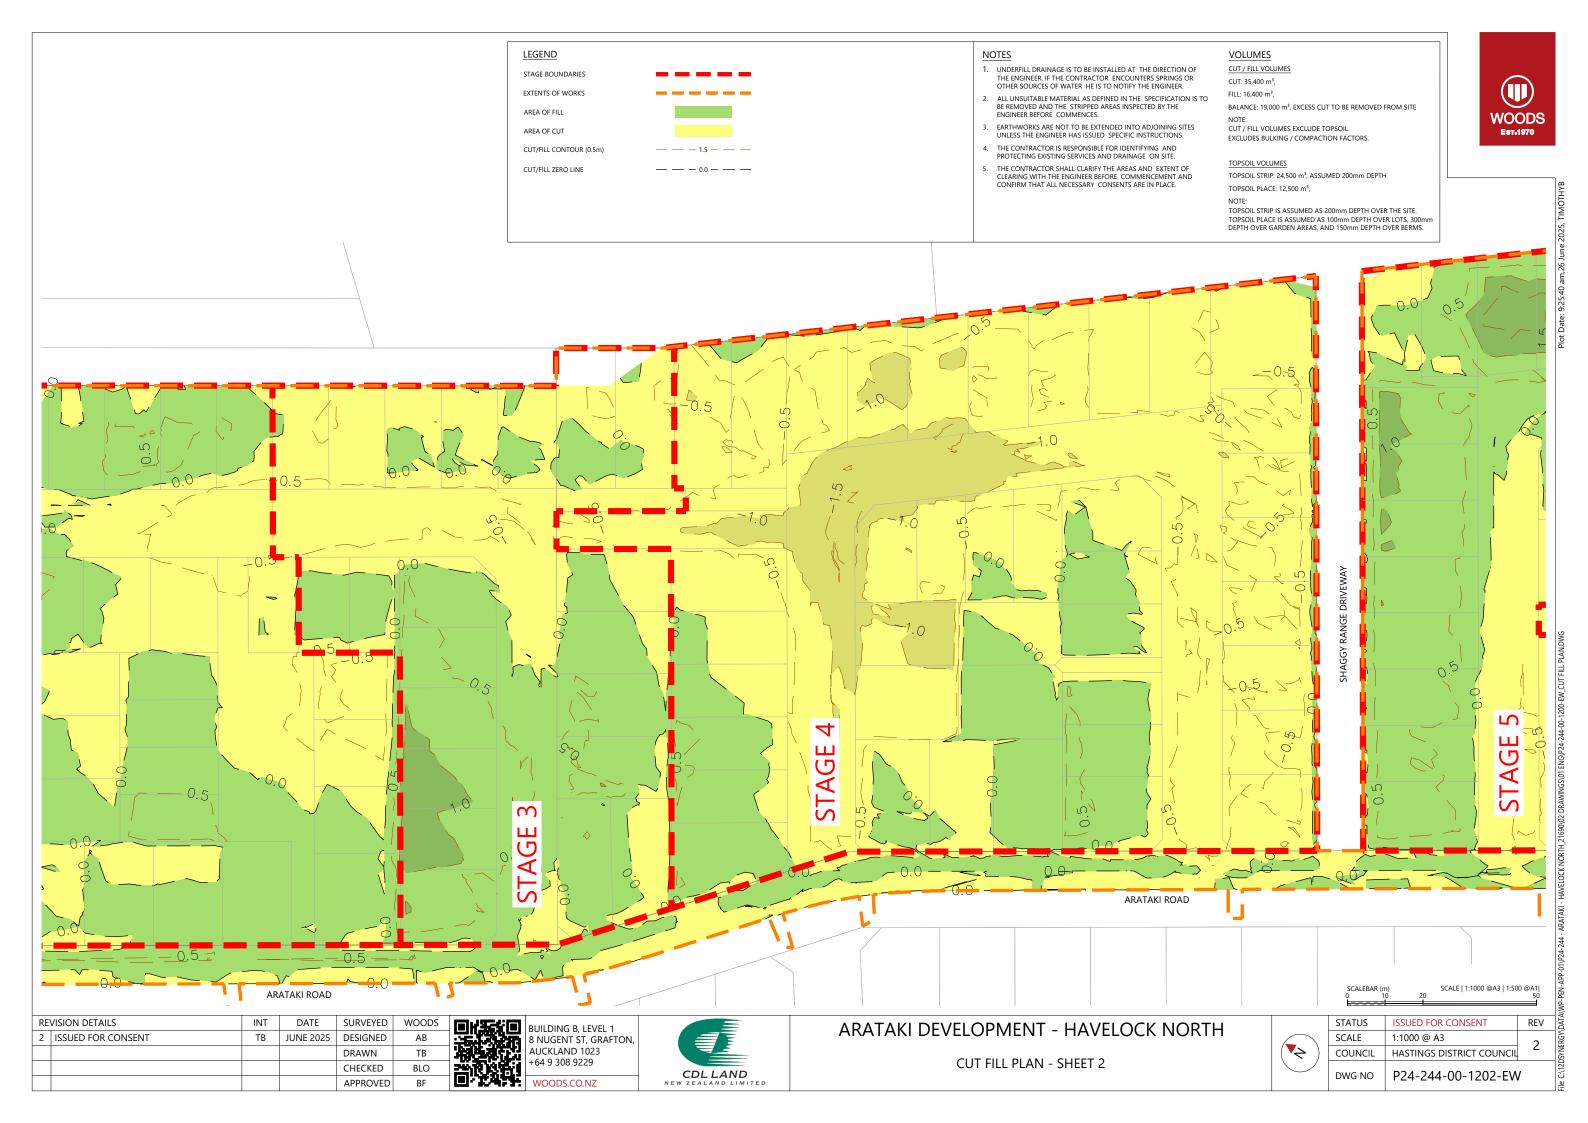

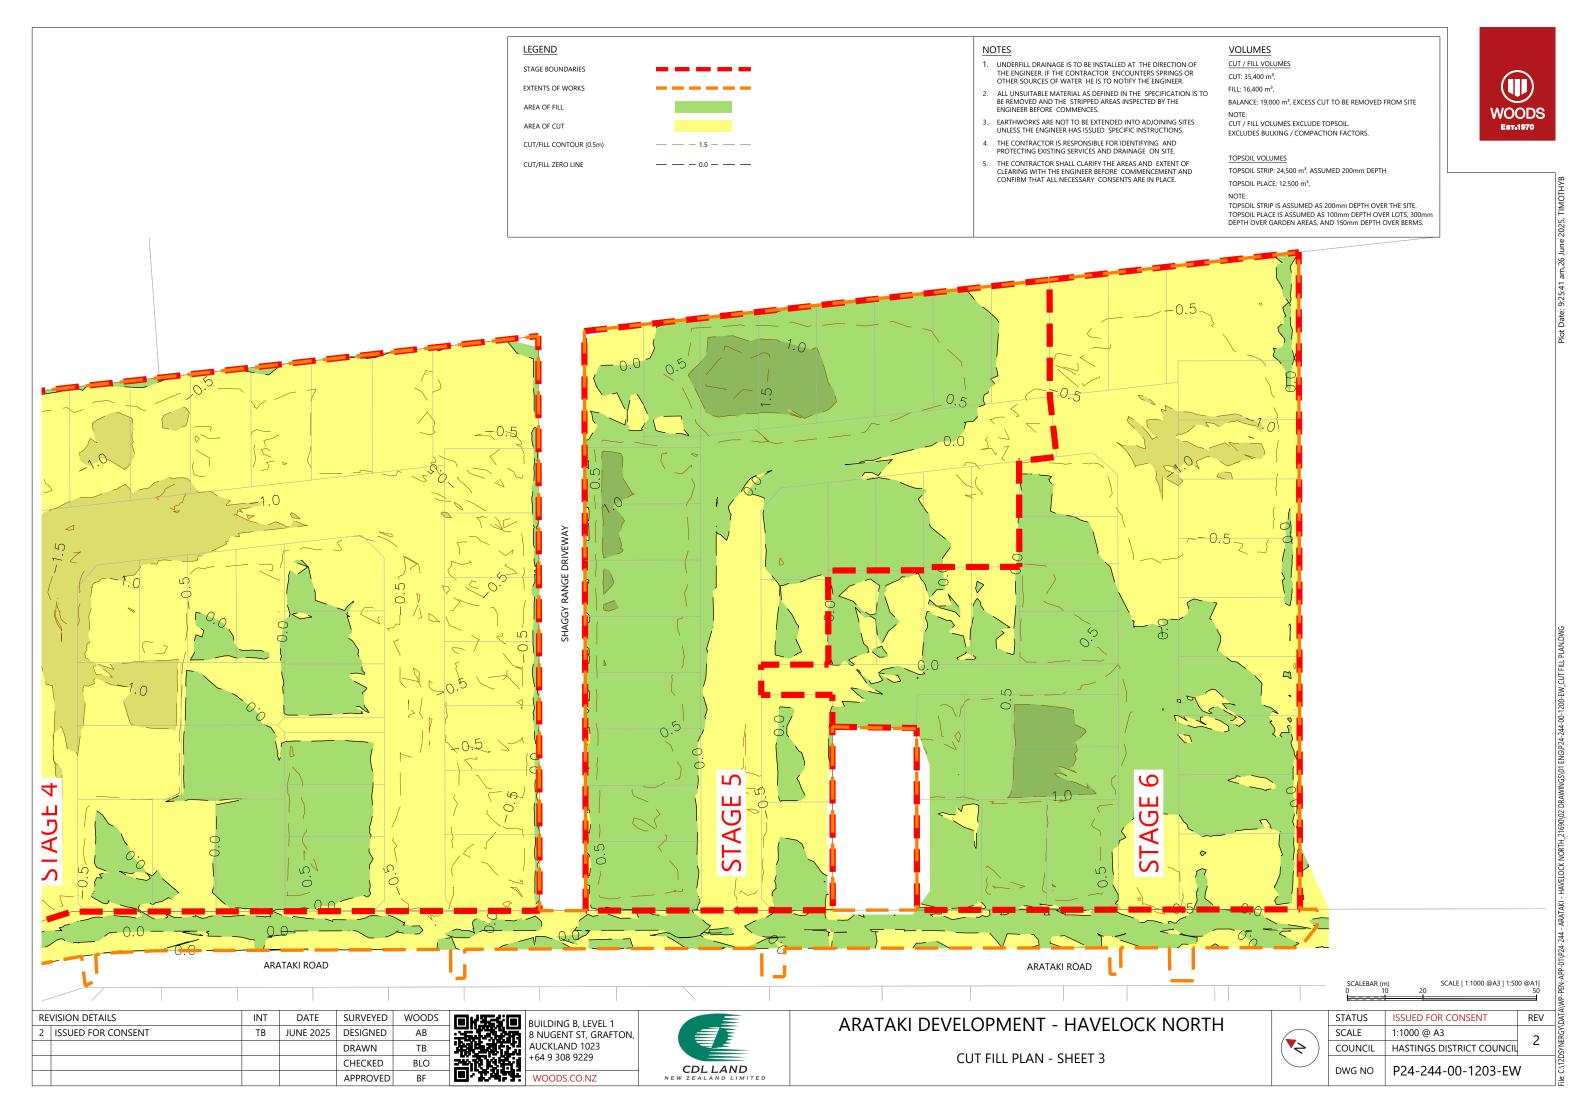


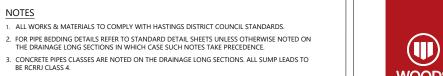

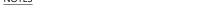

- 1. ALL WORKS & MATERIALS TO COMPLY WITH HASTINGS DISTRICT COUNCIL STANDARDS

- 4. ALL PIPE CROSSINGS UNDER ROADS TO BE HARDFILL BACKFILLED.
- ALL SW LOT CONNECTIONS TO BE 150MMØ. RAMPED RISERS ARE TO BE EXTENDED & CAPPED OFF WITHIN 1.0M OF THE FINISHED GROUND SURFACE.
- SW LOT CONNECTIONS ARE VIA KERB OUTLETS UNLESS OTHERWISE STATED. KERB OUTLETS TO
 FOLLOW HASTINGS DISTRICT COUNCIL ENGINEERING CODE OF PRACTICE STANDARD DRAWINGS
 WS 105 AND WS 106.
- 7. ALL MANHOLES TO BE 1050MMØ UNLESS OTHERWISE NOTED ON THE DRAINAGE LONG SECTION IN WHICH CASE SUCH NOTES SHALL TAKE PRECEDENCE.
- 8. THE CONTRACTOR IS TO PEG MANHOLES & CHECK FINISHED LEVELS (MH LID LEVELS) PRIOR TO ORDERING MANHOLES.
- 9. ALL MANHOLE LIDS IN CYCLEWAYS AND SHARED PATHS MUST HAVE A CYCLIST FRIENDLY COVER.
- 10. PIPE GRADES ON THE LONG SECTIONS ARE CALCULATED FROM MANHOLE SIDE TO MANHOLE SIDE. THE CONTRACTOR IS RESPONSIBLE FOR ENSURING THAT LASER LEVELS ARE SET TO COMPENSATE FOR THIS.

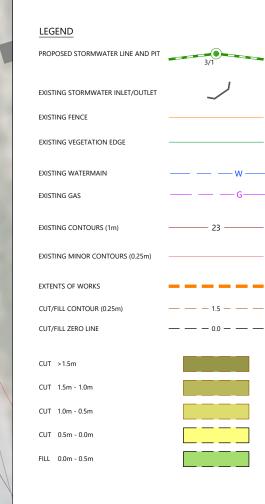

VOLUMES

CUT / FILL VOLUMES CUT: 15 m³,

BALANCE: 15 m³, EXCESS CUT TO BE REMOVED FROM SITE

MAX CUT: 1.8m

CUT / FILL VOLUMES EXCLUDE TOPSOIL

EXCLUDES BULKING / COMPACTION FACTORS.

TOPSOIL VOLUMES

TOPSOIL STRIP: 4m³, ASSUMED 200mm DEPTH

| ٩ | | | | | |
|----|------------------------|-----|----------|----------|-------|
| RE | VISION DETAILS | INT | DATE | SURVEYED | WOODS |
| 1 | ISSUED FOR INFORMATION | AS | APR 2025 | DESIGNED | AS |
| 2 | ISSUED FOR CONSENT | AS | JUN 2025 | DRAWN | AS |
| | | | | CHECKED | BLO |
| | | | | APPROVED | BF |

PROPOSED STORMWATER DISCHARGE POINT

SCALE | 1:5000 @A3 | 1:2500 @A1|

EXISTING WATERCOURSE ~

EXISTING VEGETATION TO BE-

CLEARED. REFER LANDSCAPE ARCHITECTURAL DESIGN FOR

REINSTATEMENT DETAILS.

#163 BROOKVALE ROAD

LOCATION PLAN SCALE 1:2500(A1) 1:5000(A3)

SCALEBAR (m) 0 50



BUILDING B, LEVEL 1 8 NUGENT ST, GRAFTON, AUCKLAND 1023 +64 9 308 9229 WOODS.CO.NZ



EXISTING CULVERT BLOCKS. LOCATION AND

SIZE TO BE CONFIRMED VIA ADDITIONAL SURVEY.

ARATAKI DEVELOPMENT - HAVELOCK NORTH

3

EXISTING CULVERT

OUTLET STRUCTURE INSTALLATION TO BE UNDERTAKEN DURING


BROOKVALE ROAD LANE CLOSURE WITH STOP/GO OPERATION

SUPER SILT FENCE (DURING

CONSTRUCTION ONLY)

STORMWATER OUTLET EARTHWORKS PLAN

| | STATUS | ISSUED FOR CONSENT | REV | |
|-----------|---------|---------------------------|-----|--|
| \\ | SCALE | 1:100 (A3) | 2 | |
| | COUNCIL | HASTINGS DISTRICT COUNCIL | | |
| | DWG NO | P24-244-00-1210-DR | | |

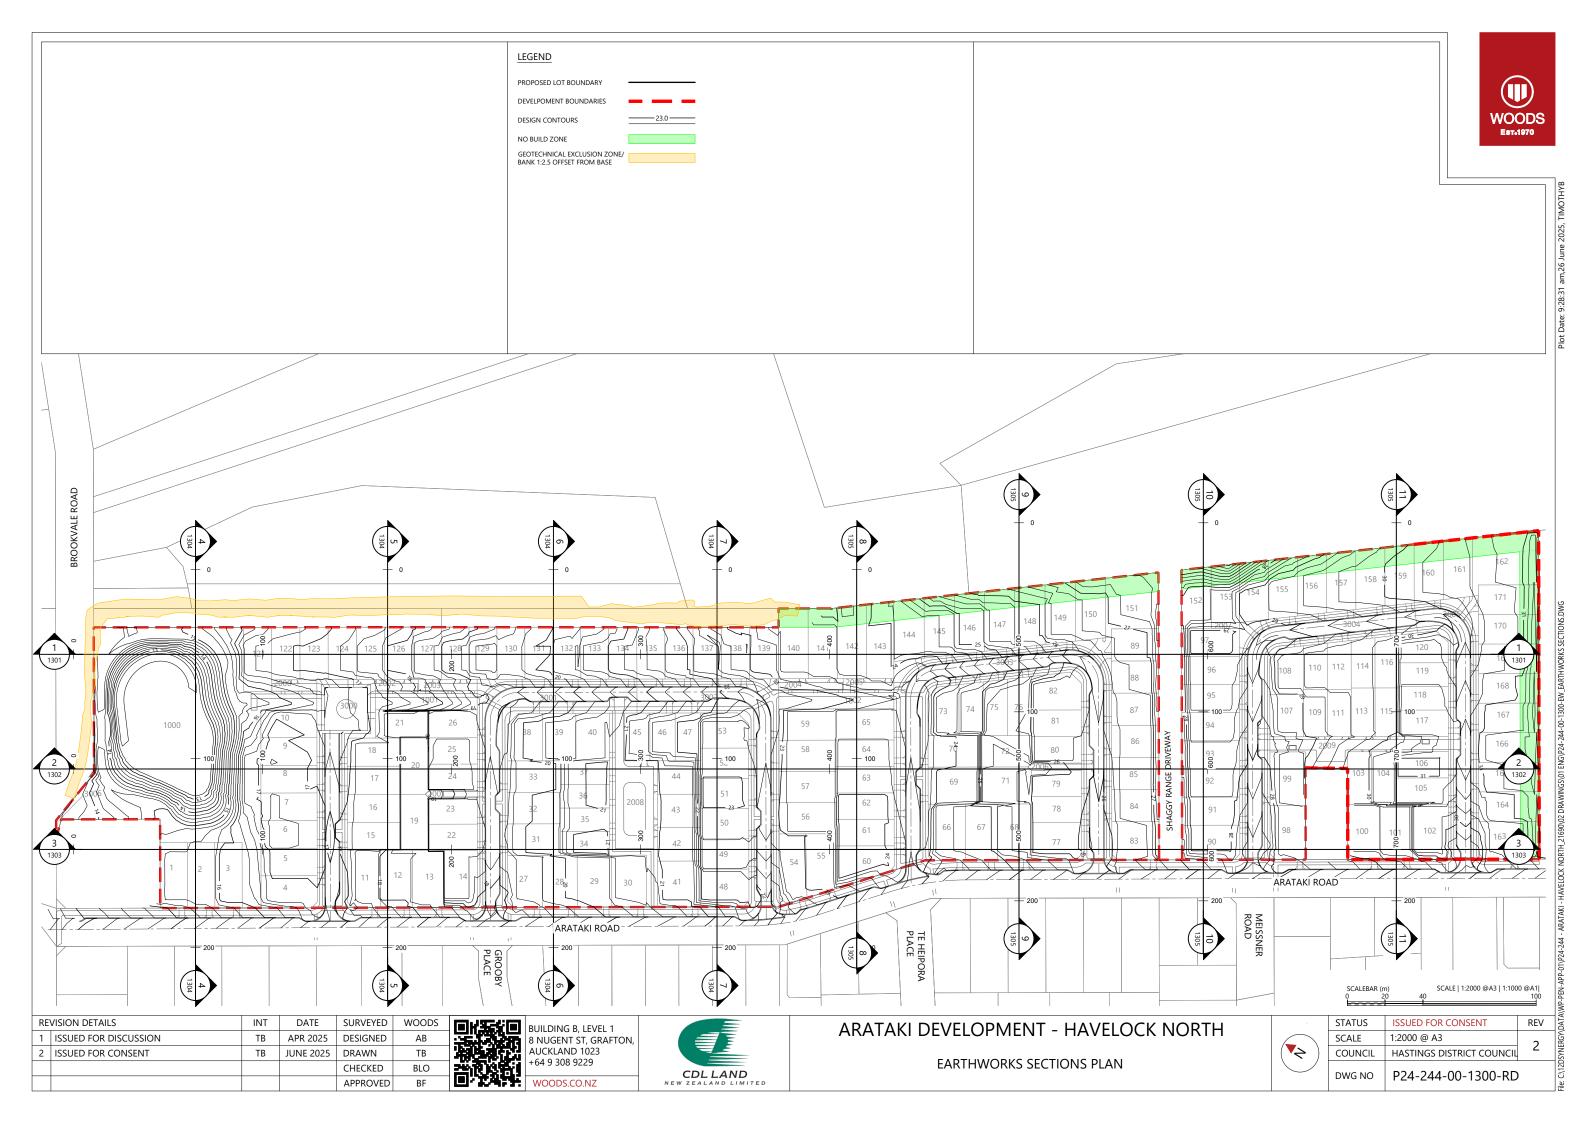


WOODS Est.1970

LEGEND


EXISTING SURFACE

PROPOSED GROUND



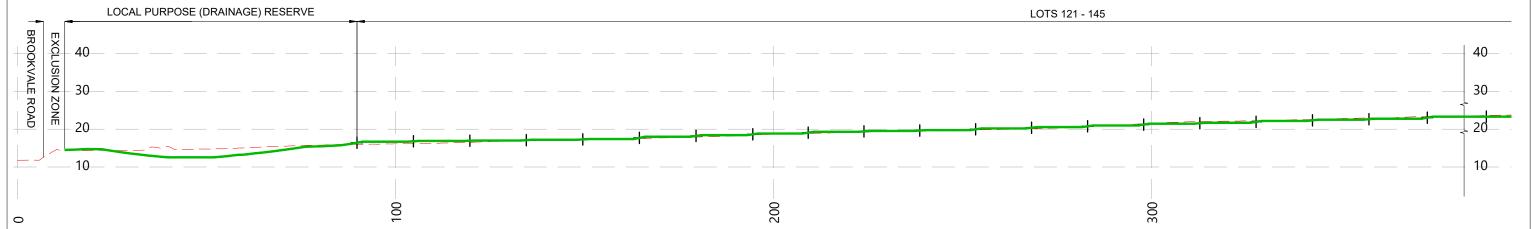



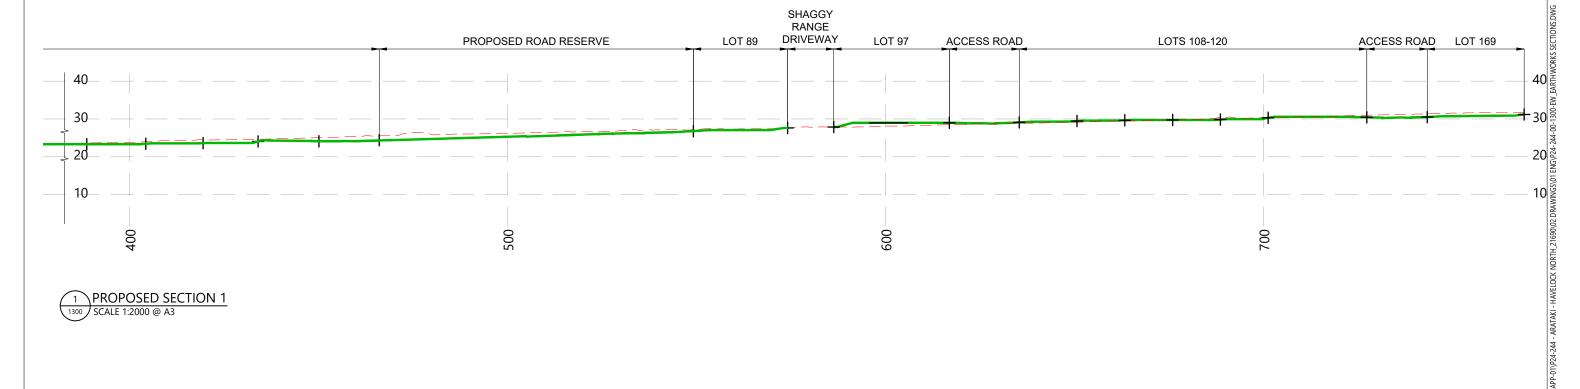

1 PROPOSED SECTION 1 1300 SCALE 1:2000 @ A3

| SCALEBA | R (m) | | SCALE 1:1000 @A3 1:500 @A1 |
|---------|-------|----|--------------------------------|
| 0 | 10 | 20 | 50 |
| | | | |

| RE | REVISION DETAILS | | DATE | SURVEYED | WOODS |
|----|-----------------------|----|-----------|----------|-------|
| 1 | ISSUED FOR DISCUSSION | ТВ | APR 2025 | DESIGNED | AB |
| 2 | ISSUED FOR CONSENT | ТВ | JUNE 2025 | DRAWN | ТВ |
| | | | | CHECKED | BLO |
| | | | | APPROVED | BF |



BUILDING B, LEVEL 1
8 NUGENT ST, GRAFTON,
AUCKLAND 1023
+64 9 308 9229

WOODS.CO.NZ



| ARATAKI | DEVELOPN | ΛΕΝΤ - | HAVEL | OCK | NORTH | ł |
|---------|----------|--------|-------|-----|-------|---|
| | | | | | | |

| EARTHWORKS SECTIONS - SHEET | 1 |
|-----------------------------|---|
| | |

| STATUS | ISSUED FOR CONSENT | REV |
|---------|---------------------------|-----|
| SCALE | 1:1000 @ A3 | 2 |
| COUNCIL | HASTINGS DISTRICT COUNCIL | |
| DWG NO | P24-244-00-1301-RD | |


LEGEND

WOODS Est.1970


EXISTING SURFACE

PROPOSED GROUND

BOUNDARY LOCATION

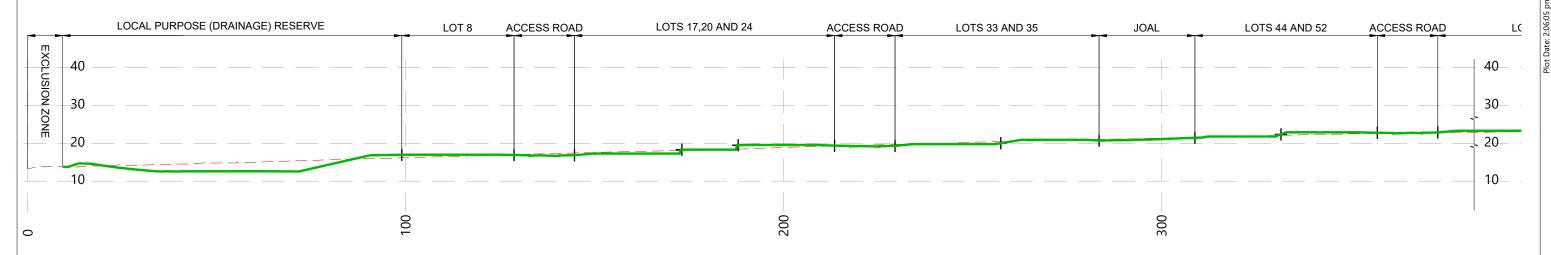

2 PROPOSED SECTION 2 1300 SCALE 1:2000 @ A3

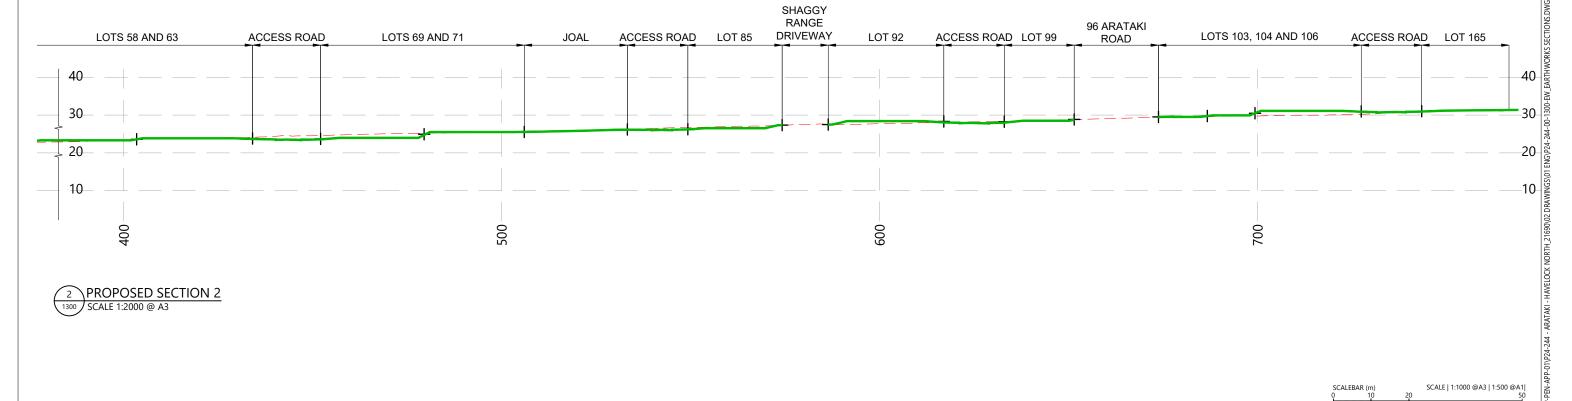

2 PROPOSED SECTION 2 1300 SCALE 1:2000 @ A3

| SCALEBA | AR (m) | | SCALE 1:1000 @A3 1:500 @A1 |
|---------|--------|----|--------------------------------|
| 0 | 10 | 20 | 50 |
| | | | |

| RE | REVISION DETAILS | | DATE | SURVEYED | WOODS |
|----|-----------------------|----|-----------|----------|-------|
| 1 | ISSUED FOR DISCUSSION | ТВ | APR 2025 | DESIGNED | AB |
| 2 | ISSUED FOR CONSENT | ТВ | JUNE 2025 | DRAWN | TB |
| | | | | CHECKED | BLO |
| | | | | APPROVED | BF |



BUILDING B, LEVEL 1
8 NUGENT ST, GRAFTON,
AUCKLAND 1023
+64 9 308 9229

WOODS.CO.NZ



| EARTHWORKS SECTIONS - SHEET 2 | |
|-------------------------------|--|
| LAKITIWOKKS SECTIONS SHEET 2 | |

| STATUS | ISSUED FOR CONSENT | REV |
|---------|---------------------------|-----|
| SCALE | 1:1000 @ A3 | 2 |
| COUNCIL | HASTINGS DISTRICT COUNCIL | |
| DWG NO | P24-244-00-1302-RD | 1 |


LEGEND

WOODS Est.1970


EXISTING SURFACE

PROPOSED GROUND

BOUNDARY LOCATION

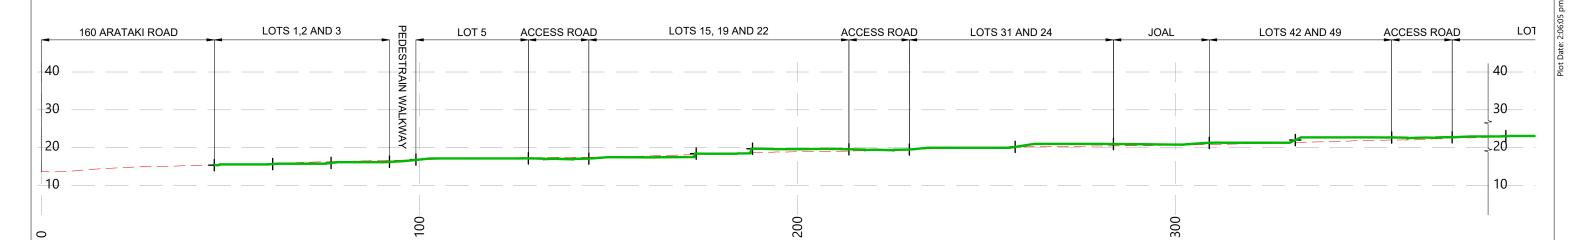



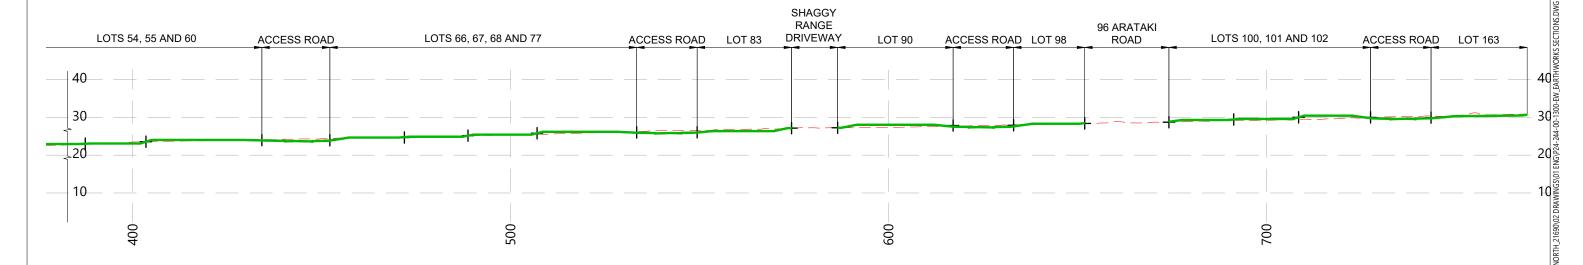

3 PROPOSED SECTION 3 1300 SCALE 1:2000 @ A3

| SCALEBA | AR (m) | | SCALE 1:1000 @A3 1:500 @A1 |
|---------|--------|----|--------------------------------|
| 0 | 10 | 20 | 50 |
| | | | |

| RE' | VISION DETAILS | INT | DATE | SURVEYED | WOODS |
|-----|-------------------------|-----|-----------|----------|-------|
| 1 | 1 ISSUED FOR DISCUSSION | | APR 2025 | DESIGNED | AB |
| 2 | ISSUED FOR CONSENT | ТВ | JUNE 2025 | DRAWN | ТВ |
| | | | | CHECKED | BLO |
| | | | | APPROVED | BF |



BUILDING B, LEVEL 1
8 NUGENT ST, GRAFTON,
AUCKLAND 1023
+64 9 308 9229


WOODS.CO.NZ



| ARATAKI DEVELOPMENT - HAVI | ELOCK NORTH |
|----------------------------|-------------|
|----------------------------|-------------|

| EARTHWORKS SECTIONS - SHEET 3 | |
|-------------------------------|--|
| LAKITIVOKKS SECTIONS SHEETS | |

| STATUS | ISSUED FOR CONSENT | REV |
|---------------------------|---------------------------|-----|
| SCALE | 1:1000 @ A3 | 2 |
| COUNCIL | HASTINGS DISTRICT COUNCIL | |
| DWG NO P24-244-00-1303-RD | | |

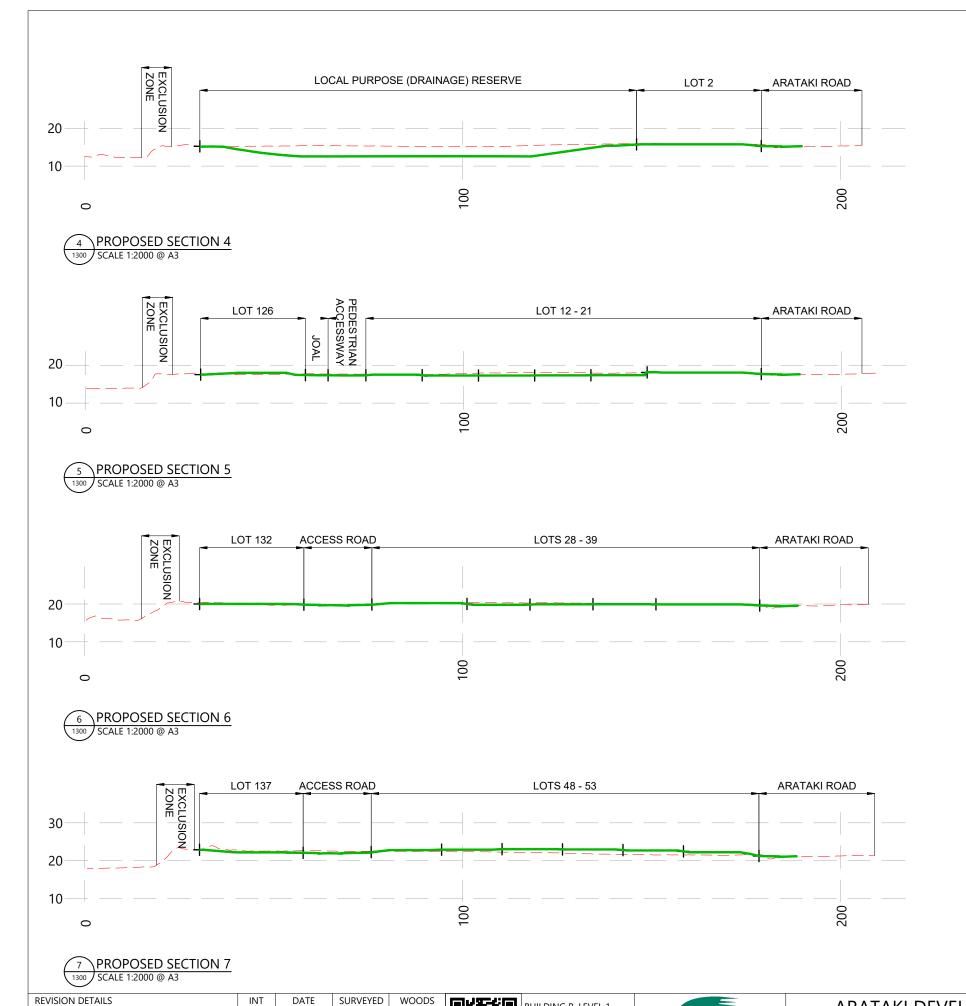

1 ISSUED FOR DISCUSSION

2 ISSUED FOR CONSENT

LEGEND

EXISTING SURFACE

PROPOSED GROUND


BOUNDARY LOCATION



| INT | DATE SU | JRVEYED | WOODS | BUILDING B. LEVEL 1 | | ARATAKI DEVELOPMENT - HAVELOCK NORTH |
|-----|--------------|---------|-------|---------------------------|---------------------|--|
| ТВ | APR 2025 DE | ESIGNED | AB | 8 NUGENT ST, GRAFTON, | | ANATAKI DEVELOFIVILINI - HAVELOCK NOKITI |
| ТВ | JUNE 2025 DR | RAWN | | | | EARTHMORKS SECTIONS SUFFER A |
| | СН | HECKED | BLO | +64 9 308 9229 | CDLLAND | EARTHWORKS SECTIONS - SHEET 4 |
| | AP | PPROVED | BF | WOODS.CO.NZ | NEW ZEALAND LIMITED | |

| STATUS | ISSUED FOR CONSENT | REV |
|---------|---------------------------|-----|
| SCALE | 1:1000 @ A3 | 2 |
| COUNCIL | HASTINGS DISTRICT COUNCIL | |
| DWG NO | P24-244-00-1304-RD |) |

SCALEBAR (m)

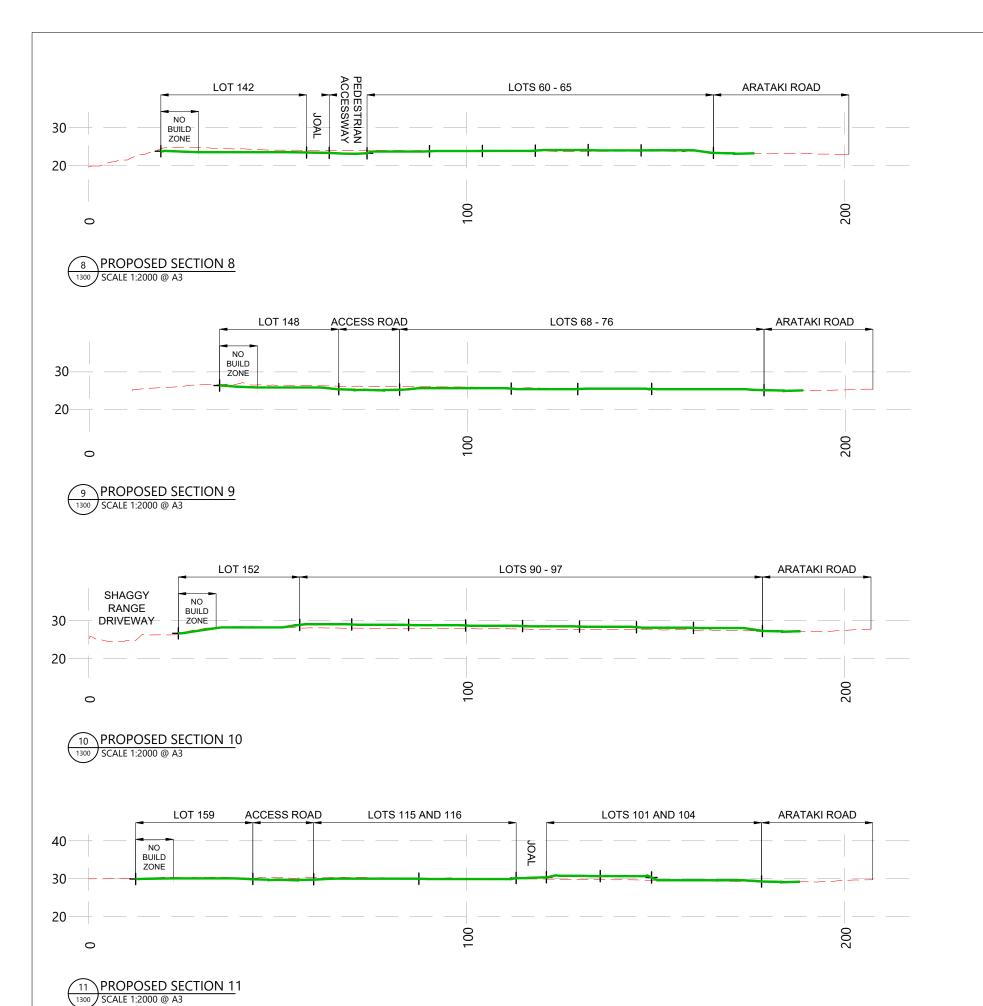

LEGEND

EXISTING SURFACE

PROPOSED GROUND

BOUNDARY LOCATION

WOODS

SCALEBAR (m) SCALE | 1:1000 @A3 | 1:500 @A1|

| REVISION DETAILS | | | DATE | SURVEYED | WOODS |
|------------------|-----------------------|----|-----------|----------|-------|
| 1 | ISSUED FOR DISCUSSION | ТВ | APR 2025 | DESIGNED | AB |
| 2 | ISSUED FOR CONSENT | ТВ | JUNE 2025 | DRAWN | ТВ |
| | | | | CHECKED | BLO |
| | | | | APPROVED | BF |

BUILDING B, LEVEL 1
8 NUGENT ST, GRAFTO
AUCKLAND 1023
+64 9 308 9229


WOODS.CO.NZ 8 NUGENT ST, GRAFTON,





| ARATAKI DEVELOPMENT - HAVELOCK N | JORTH |
|----------------------------------|--------------|
|----------------------------------|--------------|


| FARTHWORKS | SECTIONS - | SHEET 5 |
|------------|------------|---------|
| | | |

| STATUS | ISSUED FOR CONSENT | REV | |
|---------|---------------------------|-----|--|
| SCALE | 1:1000 @ A3 | | |
| COUNCIL | HASTINGS DISTRICT COUNCIL | | |
| DWG NO | P24-244-00-1305-RD | | |

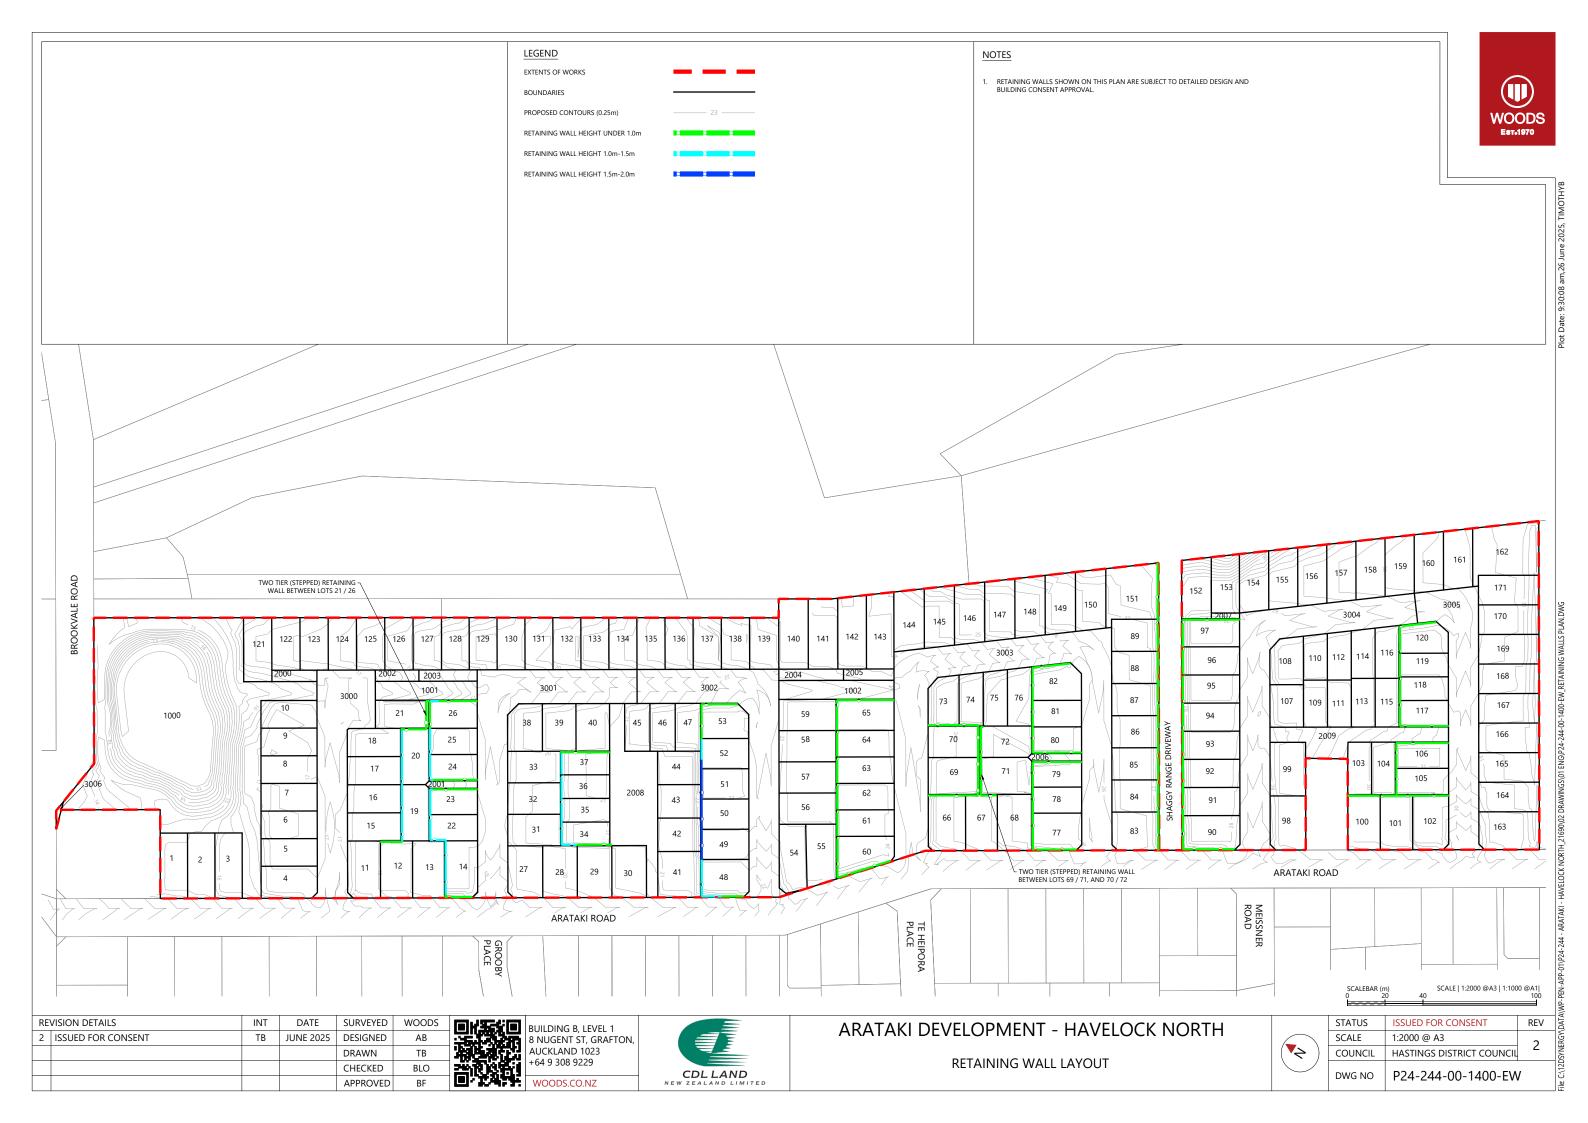

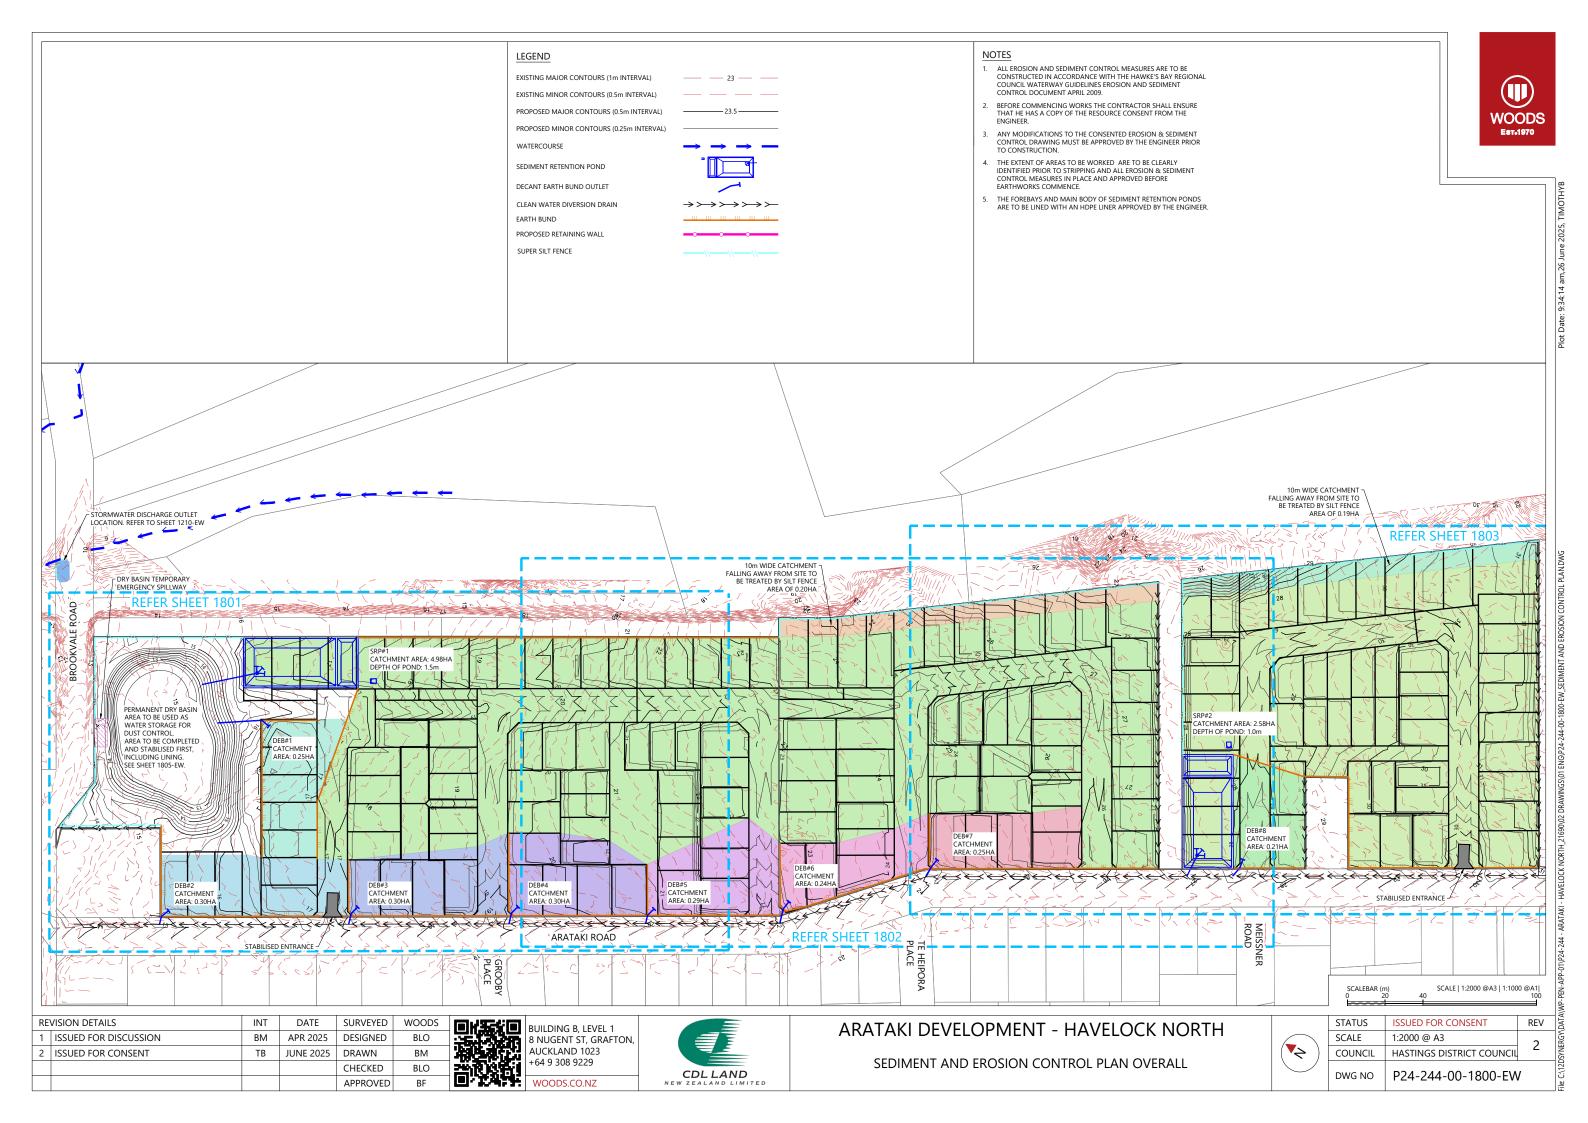

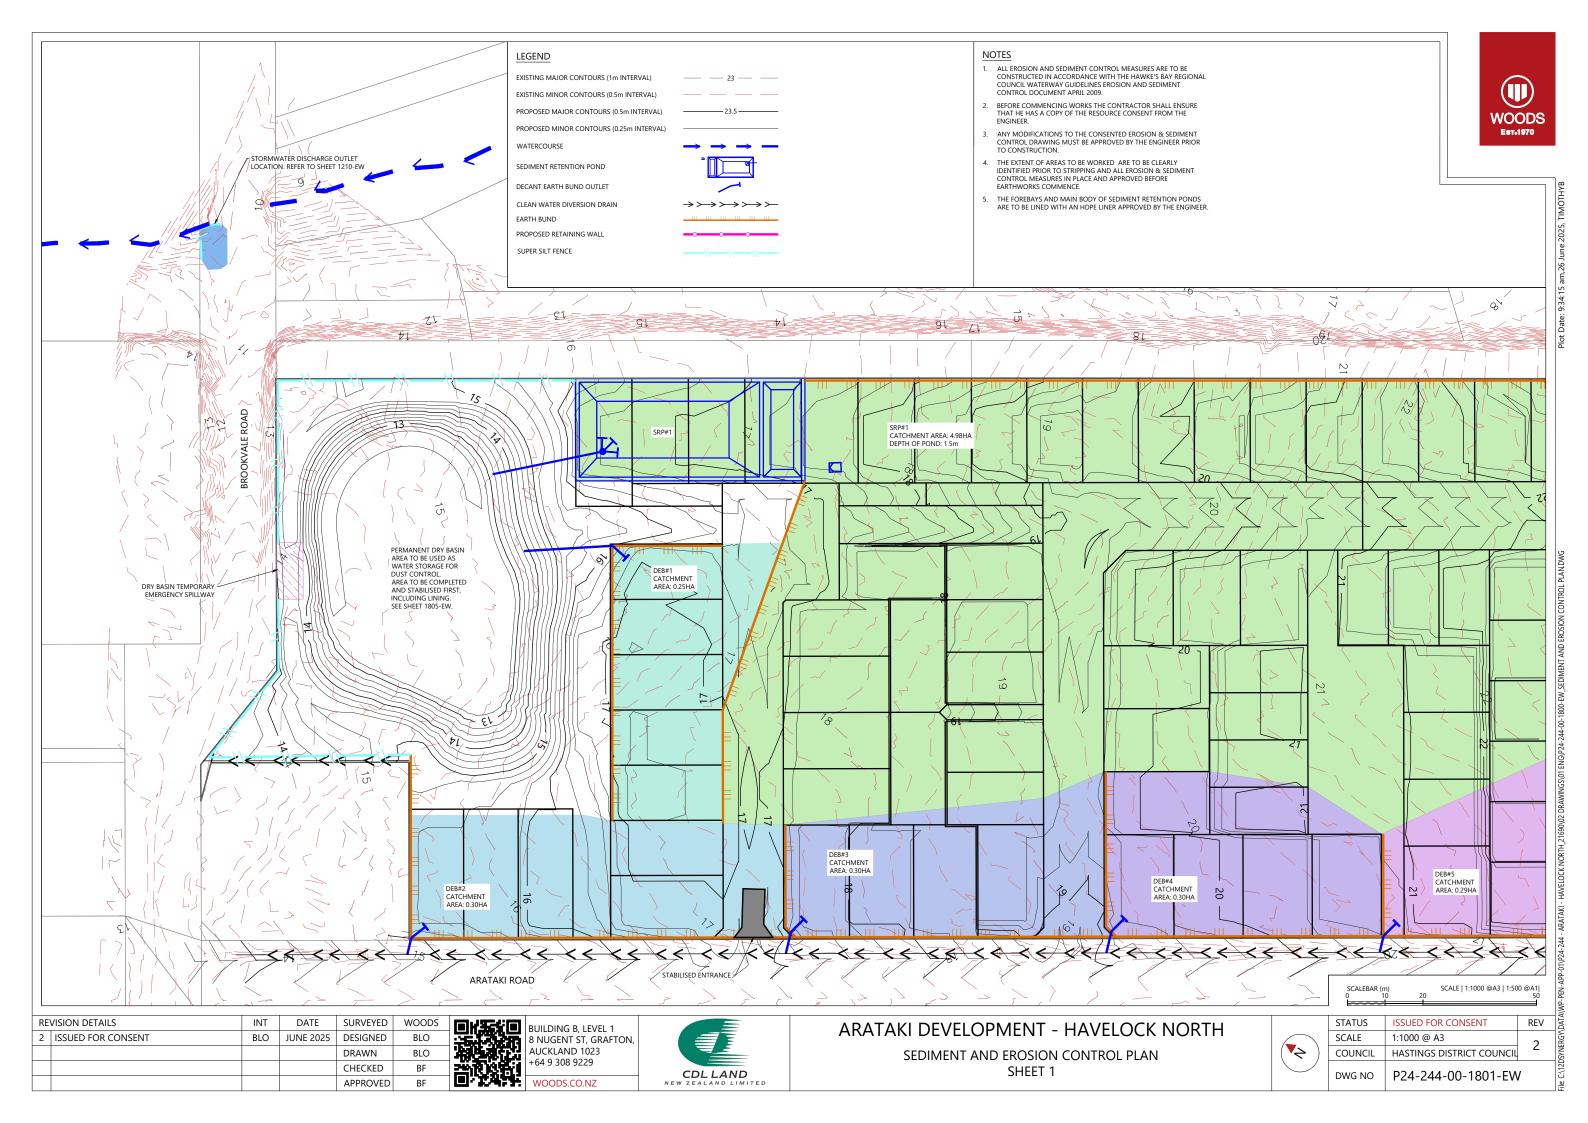

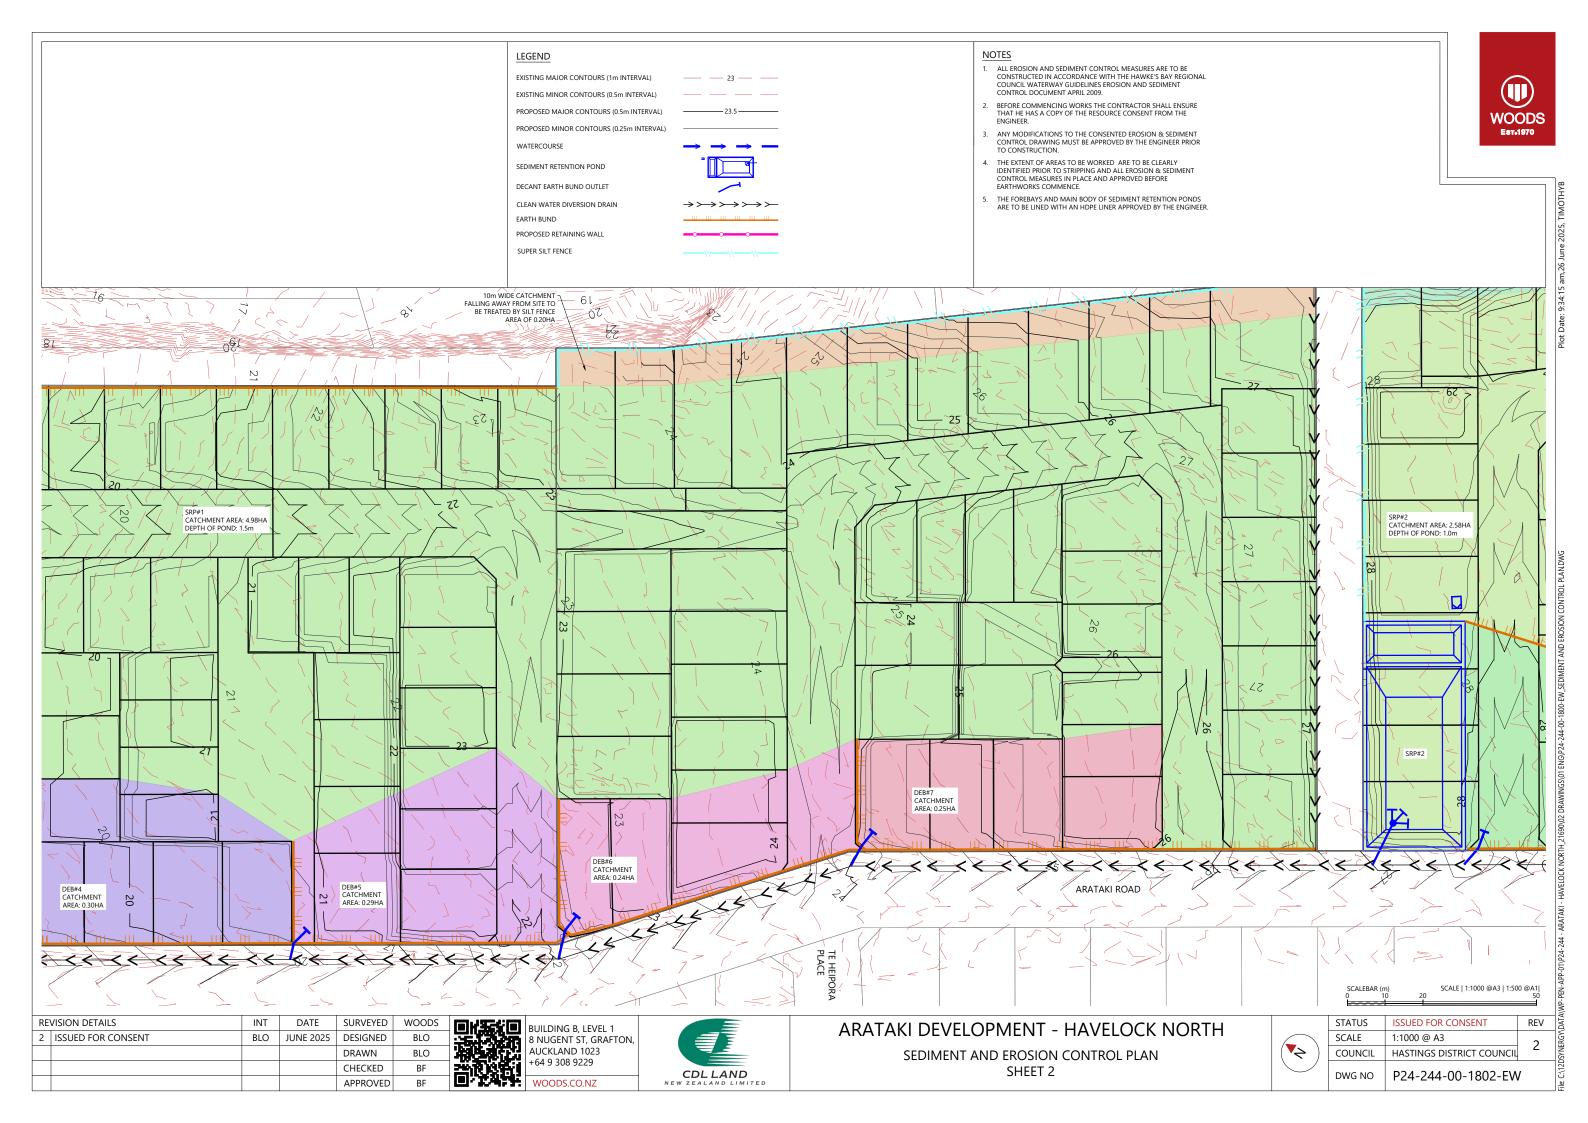

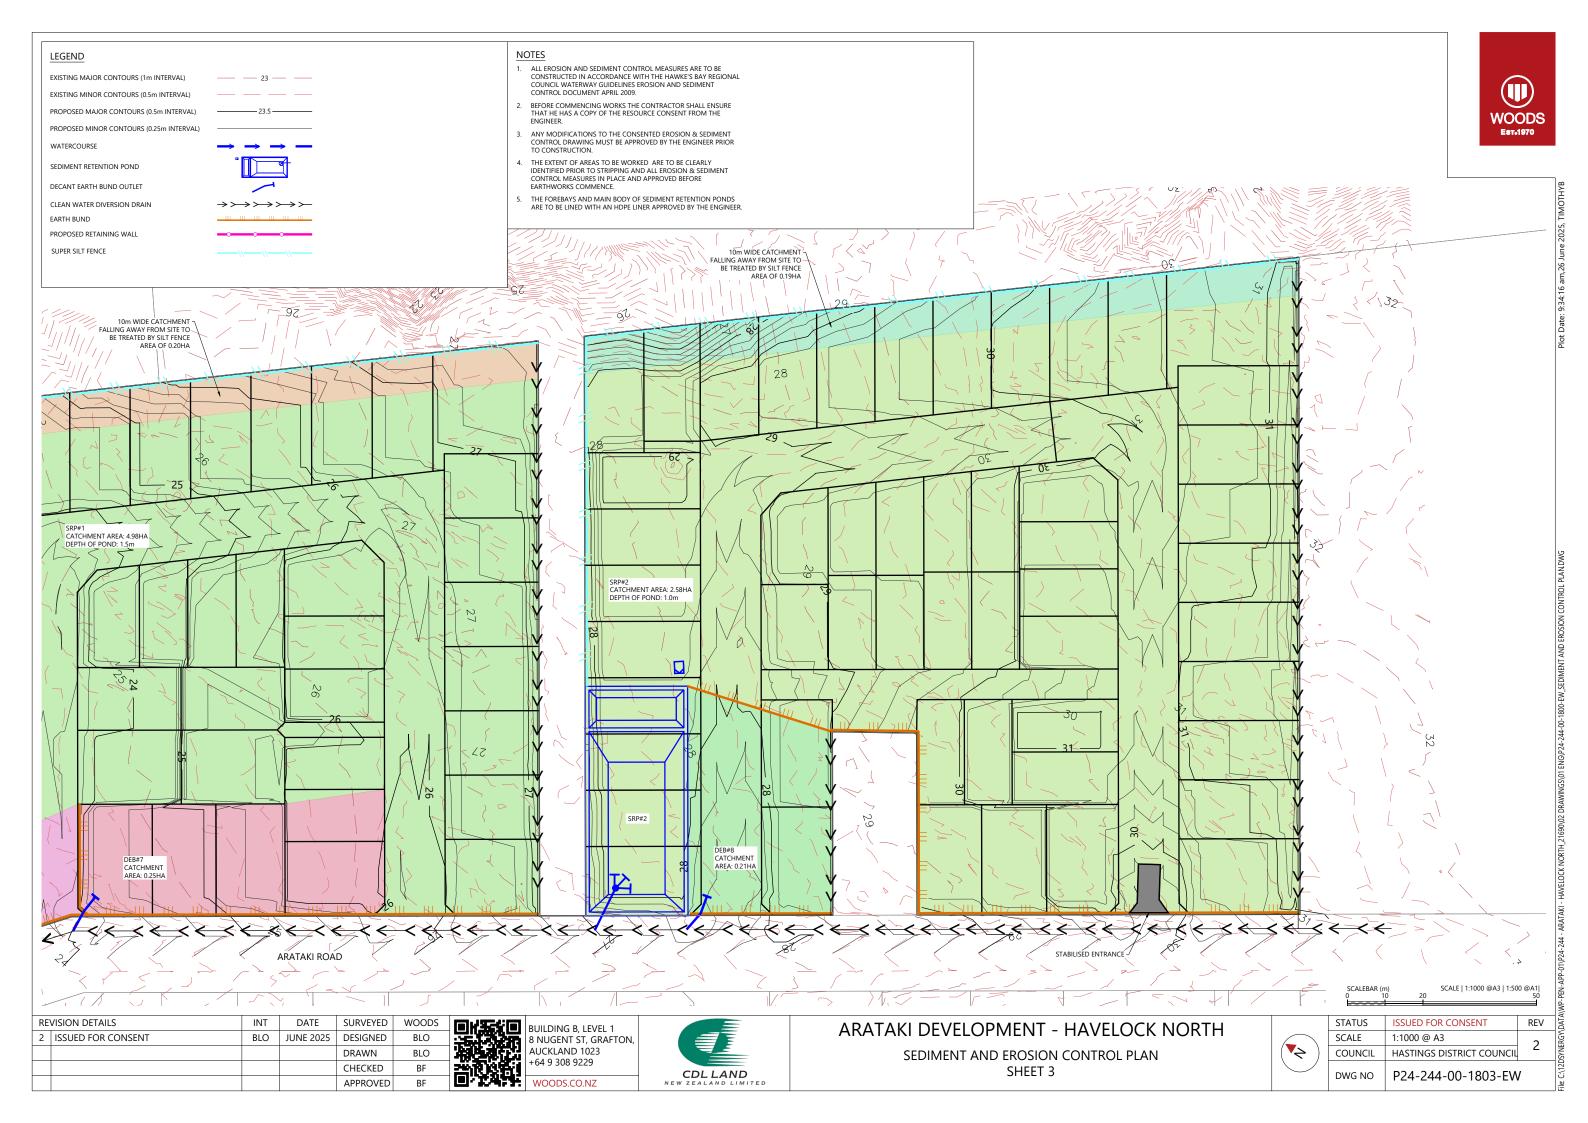




Figure 5-3 Contour Drain


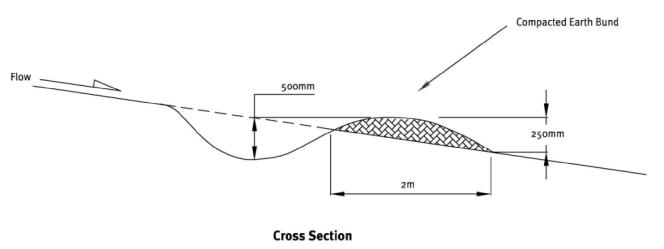


Figure 5-1
Cleanwater Runoff Diversion Bund

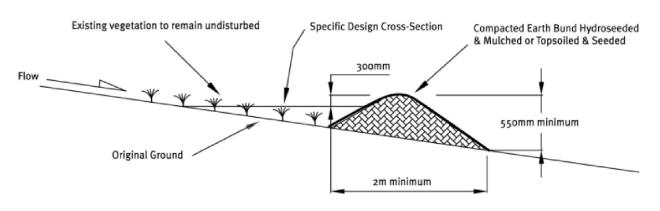

Cross Section



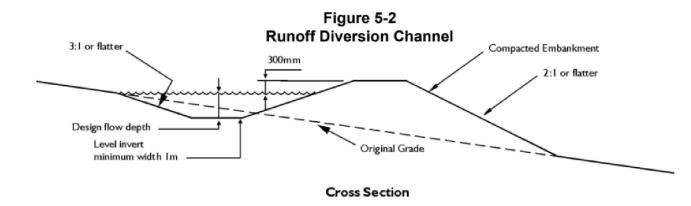


Figure 5-7
Stabilised Construction Entrance Schematic



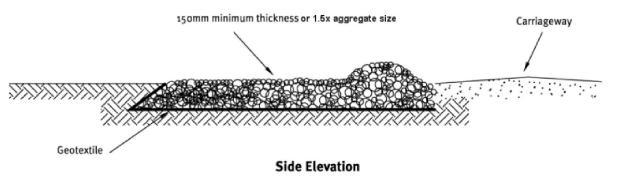

| REVISION DETAILS | | | DATE | SURVEYED | WOODS |
|------------------|-----------------------|----|-----------|------------|-------|
| 1 | ISSUED FOR DISCUSSION | BM | APR 2025 | DESIGNED | AB |
| 2 | ISSUED FOR CONSENT | ТВ | JUNE 2025 | DRAWN | BM |
| | | | | CHECKED | BLO |
| | | | | \ DDD∩\/ED | DE |

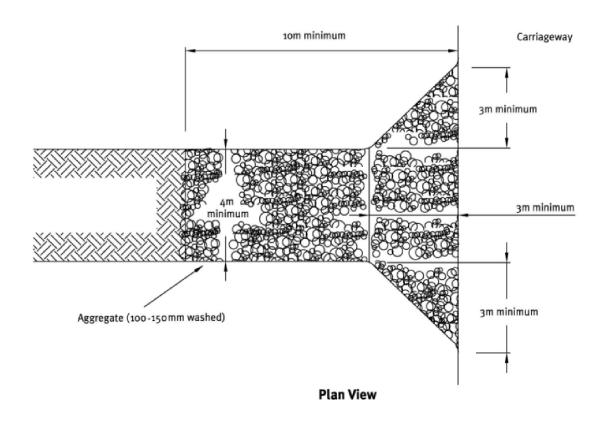

BUILDING B, LEVEL 1 8 NUGENT ST, GRAFTON, AUCKLAND 1023 +64 9 308 9229 WOODS.CO.NZ




ARATAKI DEVELOPMENT - HAVELOCK NORTH

| SEDIMENT AND EROSION CONTROL |
|------------------------------|
| STANDARD DETAILS SHEET 1 |


| STATUS | ISSUED FOR CONSENT | REV | |
|---------|---------------------------|-------------------|--|
| SCALE | N.T.S | 2 | |
| COUNCIL | HASTINGS DISTRICT COUNCIL | | |
| DWG NO | P24-244-00-1810-EW | 24-244-00-1810-EW | |



Figure 6-9 Schematic of Silt Fence

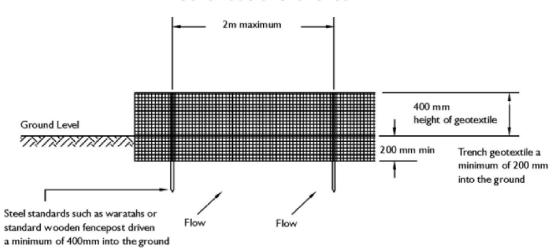

Elevation

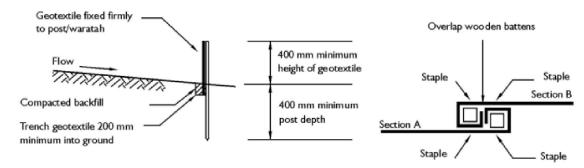

Cross Section

Standard Fabric Joint



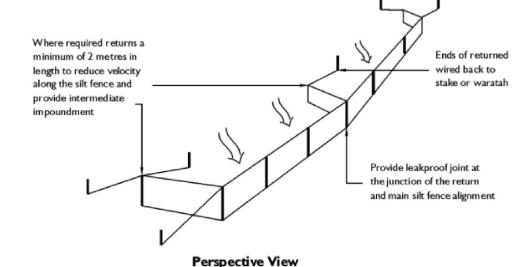


Figure 6-10 Super Silt Fence Schematic

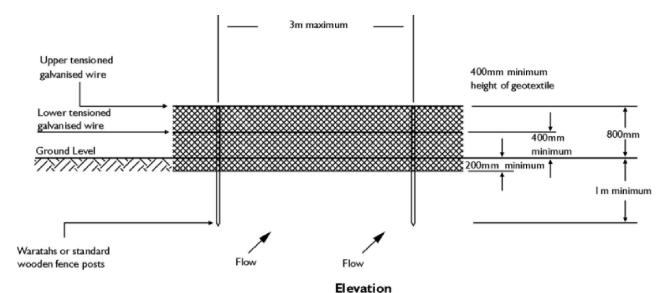

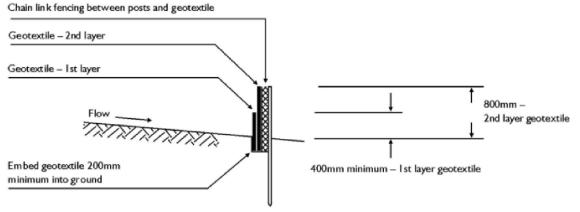

Cross Section

| RE | VISION DETAILS | INT | DATE | SURVEYED | WOODS |
|----|-----------------------|-----|-----------|----------|-------|
| 1 | ISSUED FOR DISCUSSION | BM | APR 2025 | DESIGNED | AB |
| 2 | ISSUED FOR CONSENT | ТВ | JUNE 2025 | DRAWN | BM |
| | | | | CHECKED | BLO |
| | | | | APPROVED | BF |



BUILDING B, LEVEL 1 8 NUGENT ST, GRAFTON, AUCKLAND 1023 +64 9 308 9229 WOODS.CO.NZ



| SEDIMENT AND EROSION CONTROL | |
|------------------------------|--|
| STANDARD DETAILS SHEET 2 | |

| STATUS | ISSUED FOR CONSENT | REV |
|---------|---------------------------|-----|
| SCALE | N.T.S | 2 |
| COUNCIL | HASTINGS DISTRICT COUNCIL | |
| DWG NO | NO P24-244-00-1811-EW | |

Figure 6-12 Decanting Earth Bund with a Floating Decant

Bund to ensure correct

Impoundment area to have a level invert and a length to width ratio between 3:1 and 5:1

1.2 m total length
Waratahs

Spillway geotextile extended through to cover the bund around the stormwater manhole

Refer Decanting Topsoil Bund schematic for alternate spillway

Figure 6-13
Cross-section of a Floating Decant


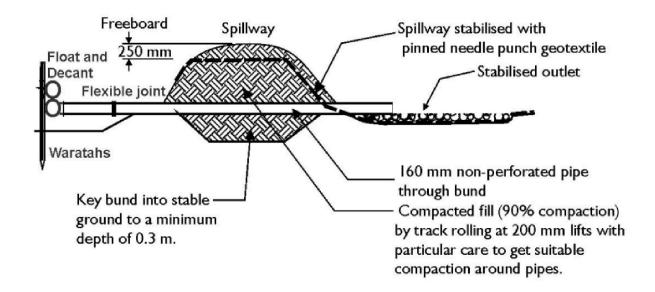


Figure 6-2 Schematic of a T-bar Decant Structure

Waratahs placed either side of decant arm

as alternative means of securing decant Wire limiting vertical movement of decant Attach 1.8m long waratah to weight decant (see section A-A) Standard end caps Wire or steel straps to Decant: Six equally spaced join decant and float rows of 10mm diameter and clamped - two joints to holes at 60mm spacings be used only for lower decant along the full length of the decant pipe, 200 holes per 1.5 ha catchment

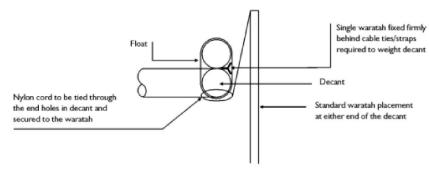

Section A-A

STATUS ISSUED FOR CONSENT REV

SCALE N.T.S

COUNCIL HASTINGS DISTRICT COUNCIL

DWG NO P24-244-00-1812-EW

| REVISION DETAILS | | INT | DATE | SURVEYED | WOODS |
|------------------|-----------------------|-----|-----------|----------|-------|
| 1 | ISSUED FOR DISCUSSION | BM | APR 2025 | DESIGNED | AB |
| 2 | ISSUED FOR CONSENT | ТВ | JUNE 2025 | DRAWN | ВМ |
| | | | | CHECKED | BLO |
| | | | | APPROVED | BF |




BUILDING B, LEVEL 1 8 NUGENT ST, GRAFTON, AUCKLAND 1023 +64 9 308 9229



manhole

Plot Date: 2:06:12 pm,17 June 2025, TIMOTHYE

PEN-APP-01\P24-244 - ARATAKI - HAVELOCK NORTH_21690\02 DRAWINGS\01 ENG\P24-244-00-1810-EW_ESC STANDARD DETAILS.DWG

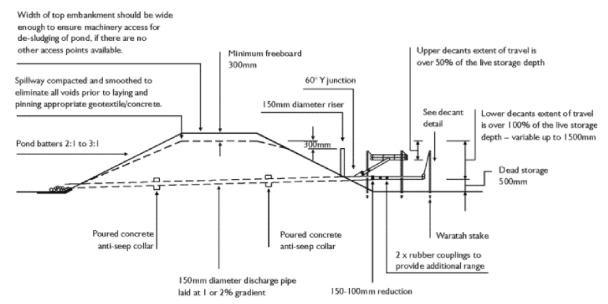

Cross Section



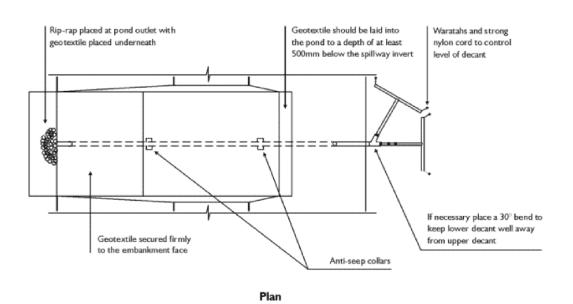


Figure 6-5
Sediment Retention Pond for Catchments Between 3 and 5 ha.

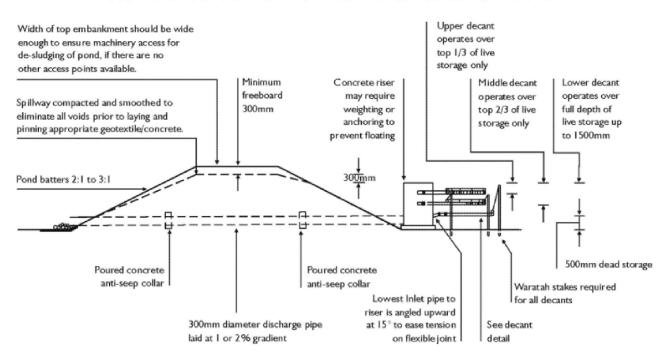

Cross Section

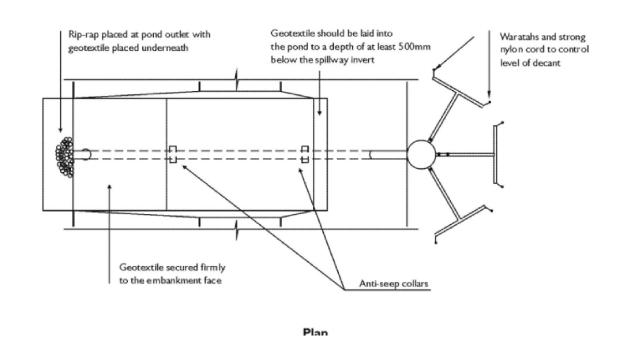

| REVISION DETAILS | | INT | DATE | SURVEYED | WOODS |
|------------------|-----------------------|-----|-----------|----------|-------|
| 1 | ISSUED FOR DISCUSSION | BM | APR 2025 | DESIGNED | AB |
| 2 | ISSUED FOR CONSENT | ТВ | JUNE 2025 | DRAWN | ВМ |
| | | | | CHECKED | BLO |
| | | | | APPROVED | BF |



BUILDING B, LEVEL 1 8 NUGENT ST, GRAFTON, AUCKLAND 1023 +64 9 308 9229 WOODS.CO.NZ



| SEDIMENT AND EROSION CONTROL | |
|------------------------------|--|
| STANDARD DETAILS SHEET 4 | |

| STATUS | ISSUED FOR CONSENT | REV |
|---------|---------------------------|-----|
| SCALE | N.T.S | 2 |
| COUNCIL | HASTINGS DISTRICT COUNCIL | |
| DWG NO | o P24-244-00-1813-EW | |




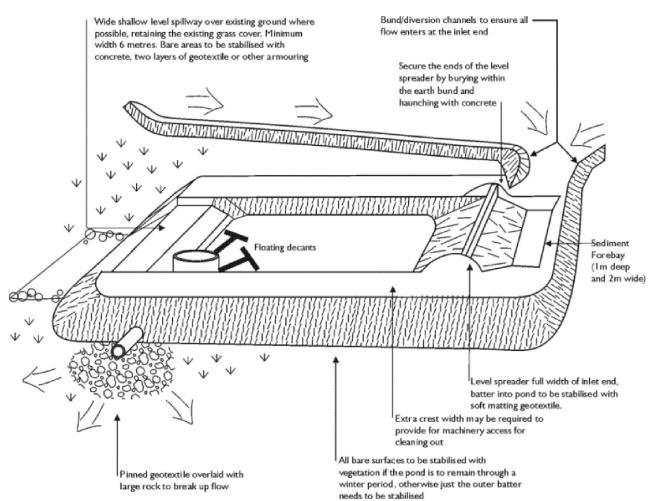


Figure 6-11 Schematic of Inlet Protection



REVISION DETAILS INT DATE SURVEYED WOODS 1 ISSUED FOR DISCUSSION ВМ APR 2025 DESIGNED 2 ISSUED FOR CONSENT ТВ JUNE 2025 DRAWN ВМ CHECKED BLO APPROVED

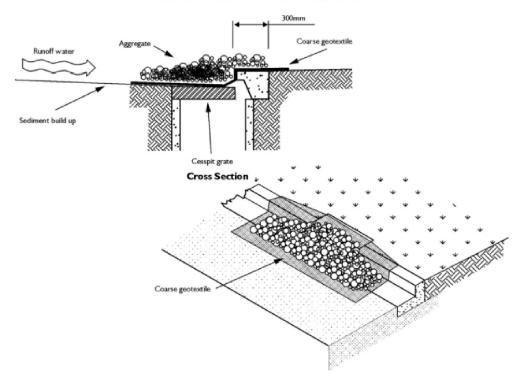


BUILDING B, LEVEL 1 8 NUGENT ST, GRAFTON, AUCKLAND 1023 +64 9 308 9229 WOODS.CO.NZ





ARATAKI DEVELOPMENT - HAVELOCK NORTH


SEDIMENT AND EROSION CONTROL STANDARD DETAILS SHEET 5


| STATUS | ISSUED FOR CONSENT | REV |
|---------|---------------------------|-----|
| SCALE | N.T.S | 2 |
| COUNCIL | HASTINGS DISTRICT COUNCIL | |
| DWG NO | P24-244-00-1814-EW | / |

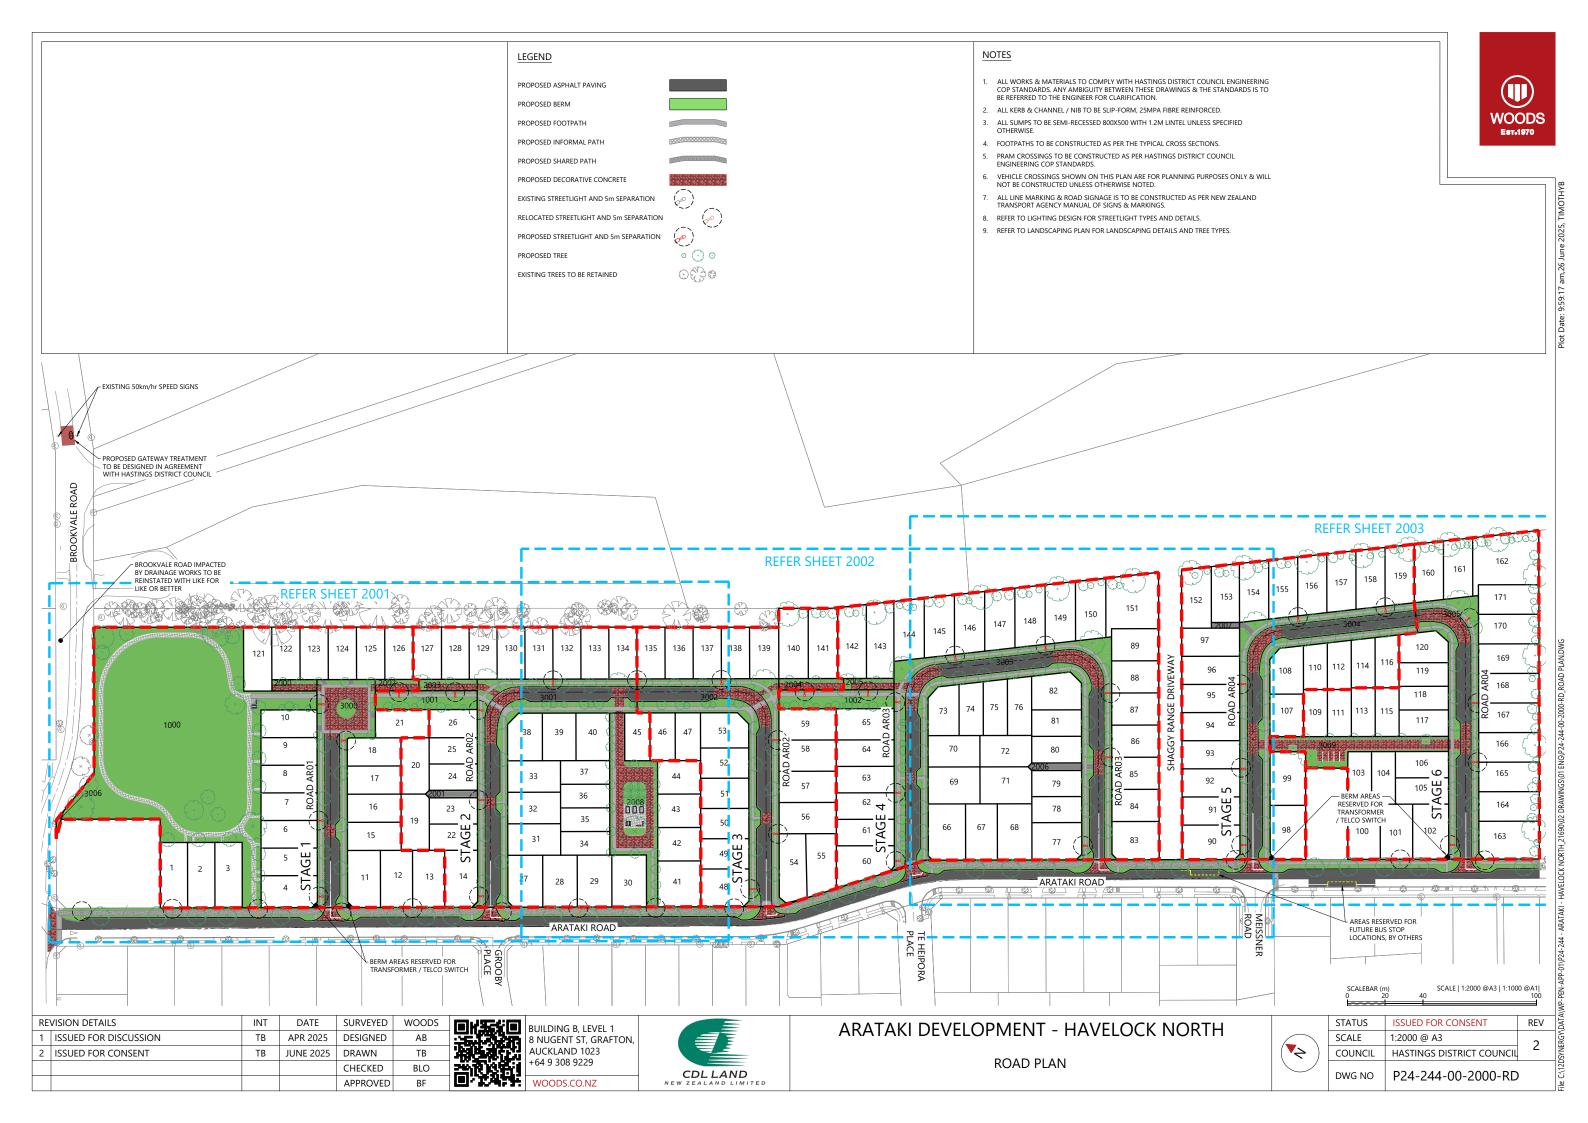


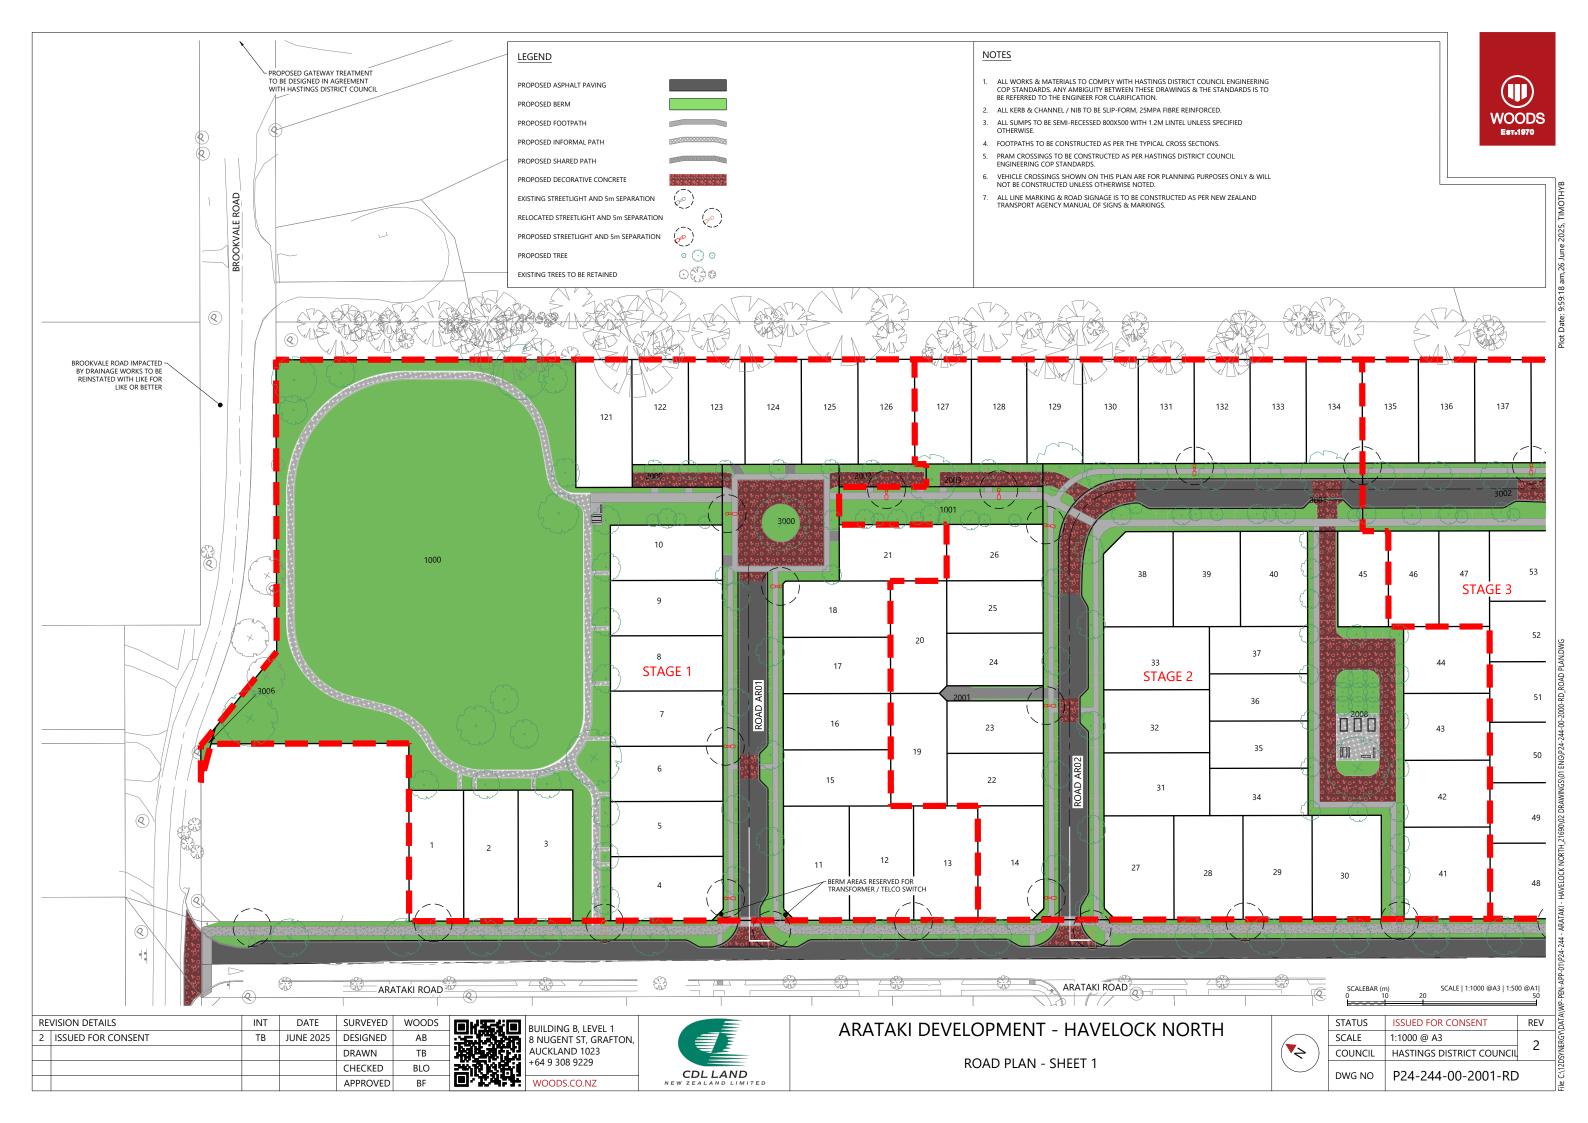

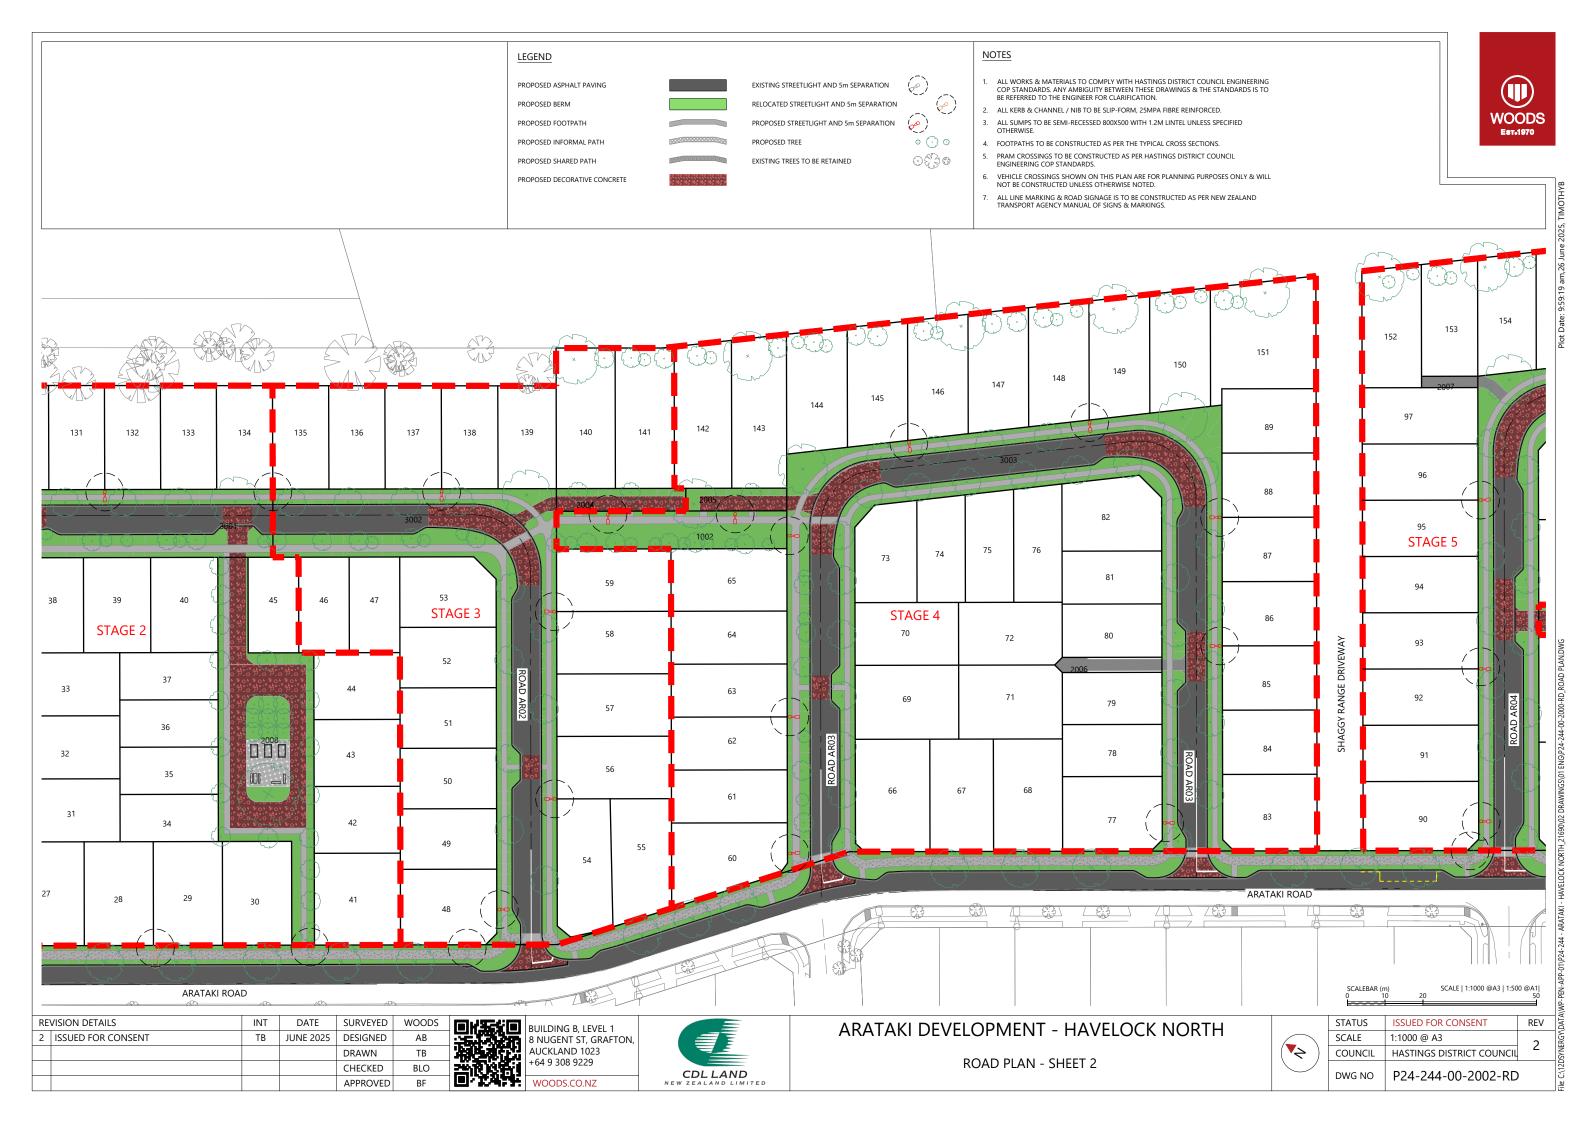


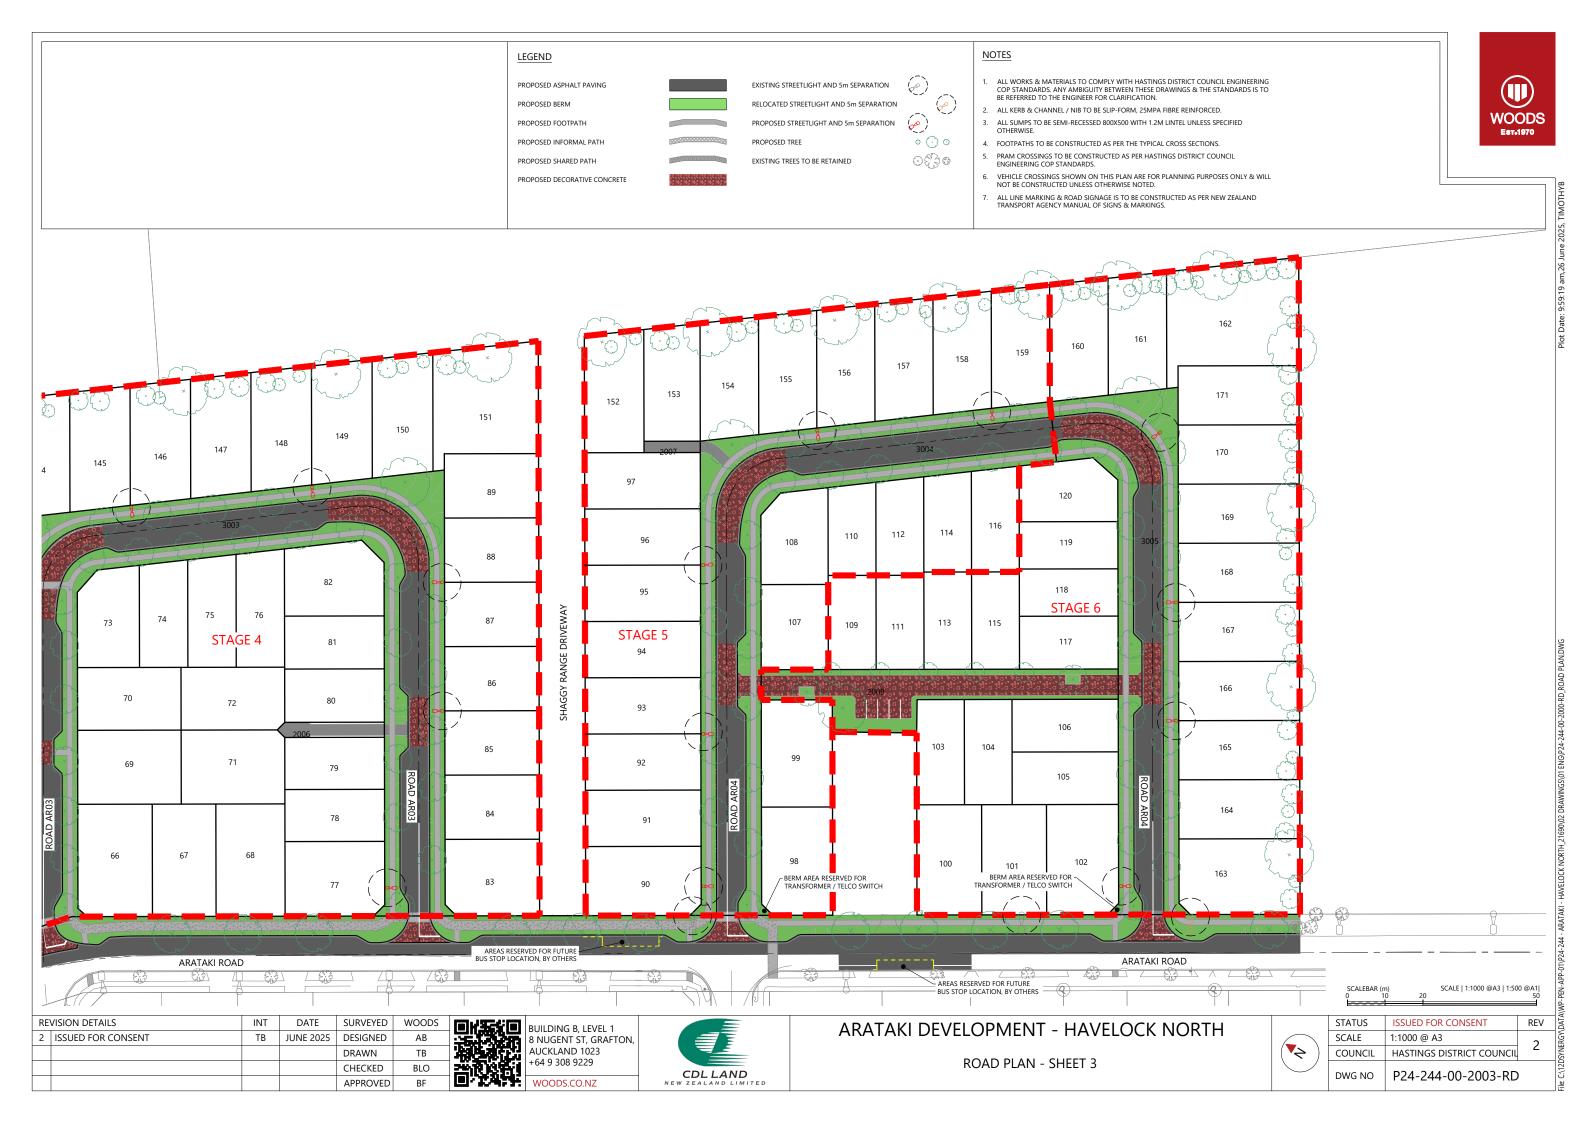


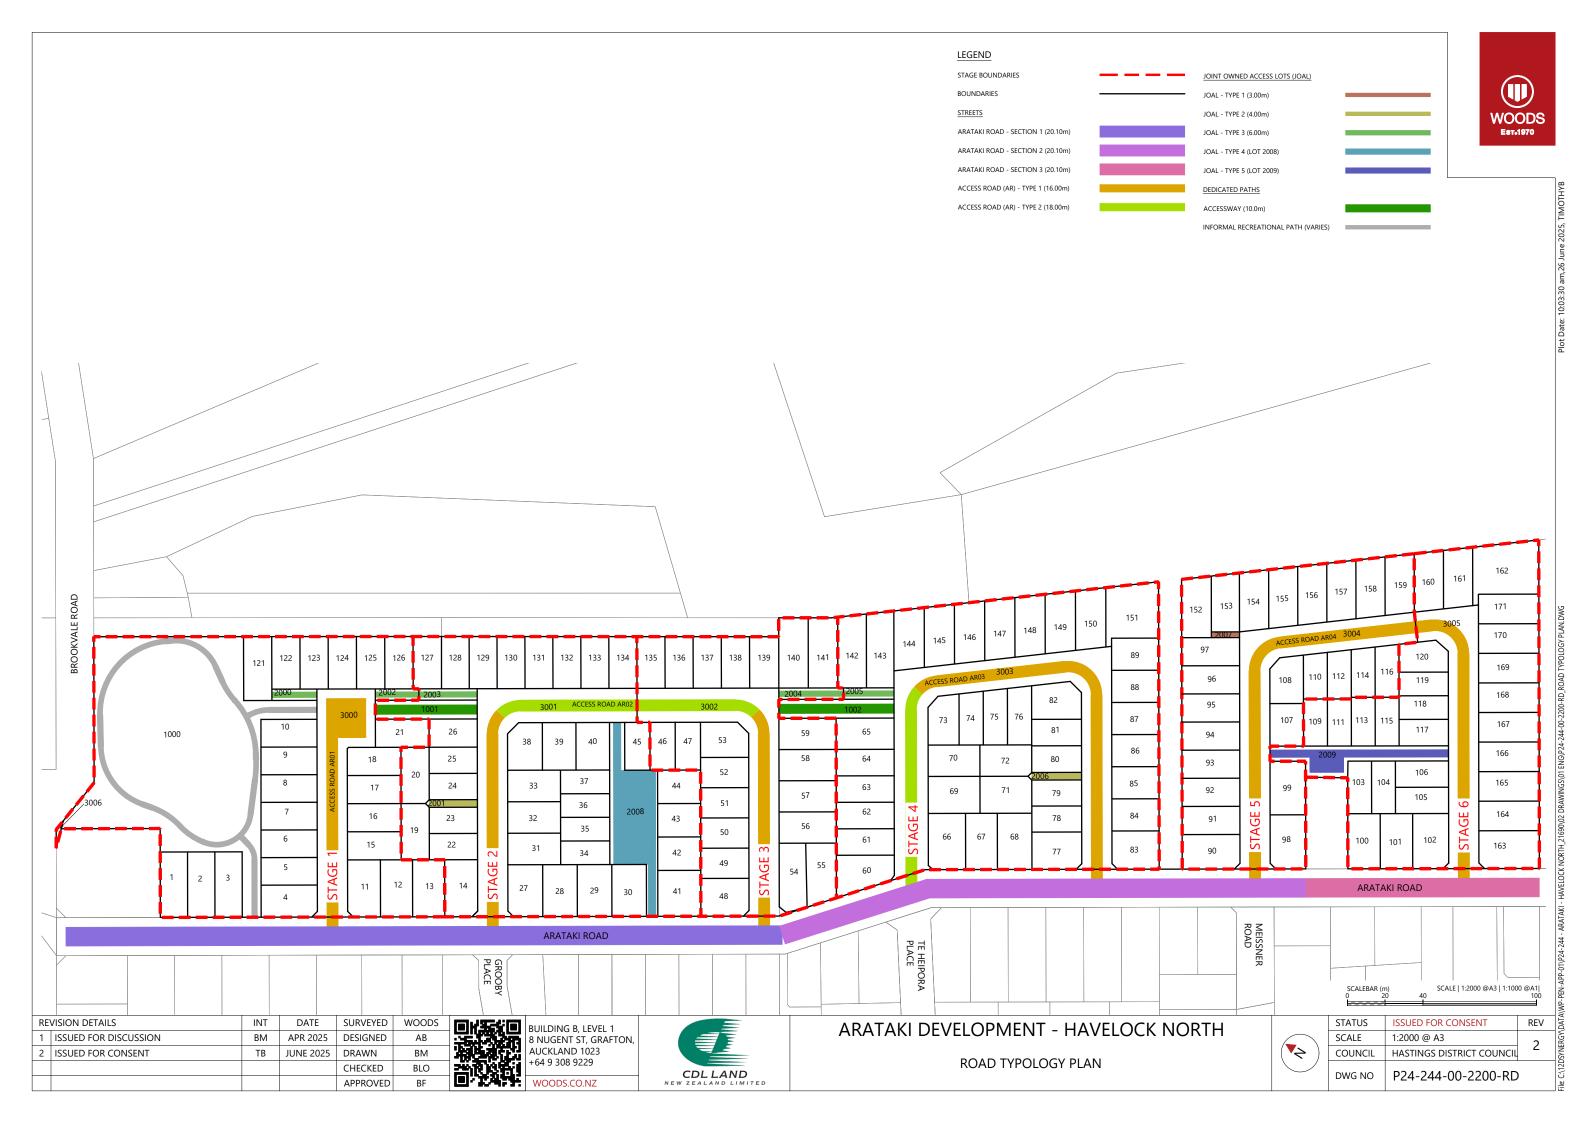

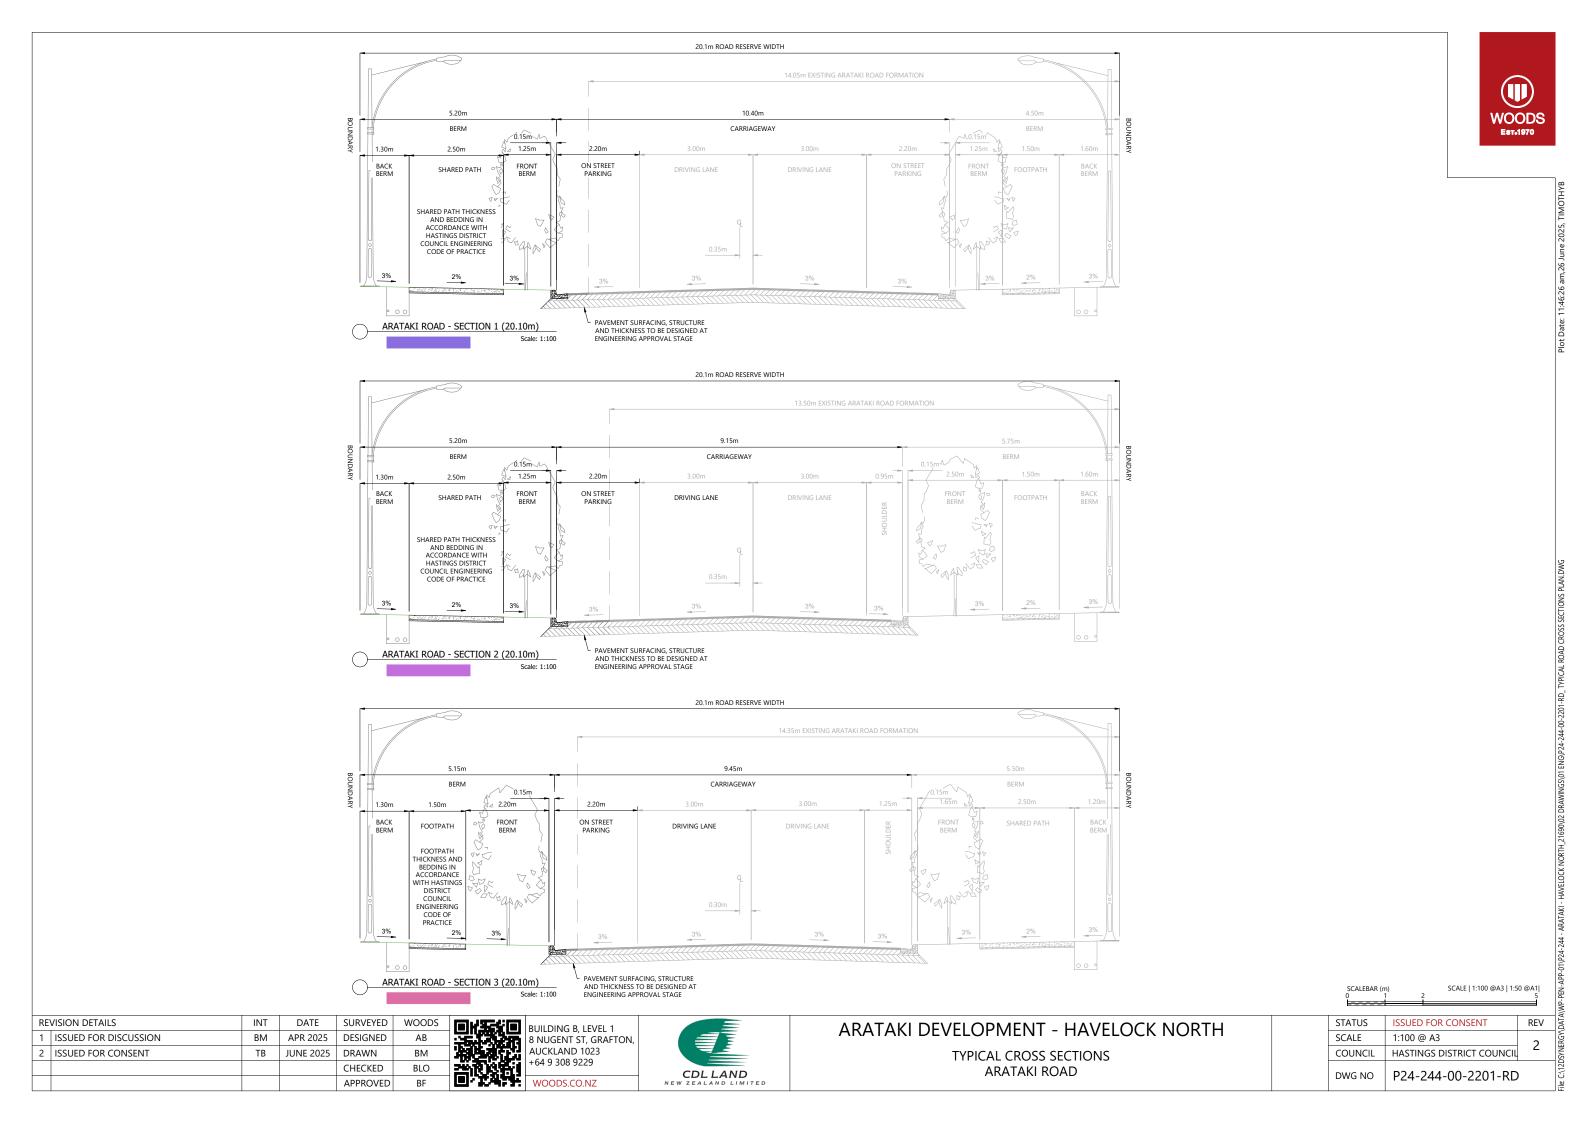



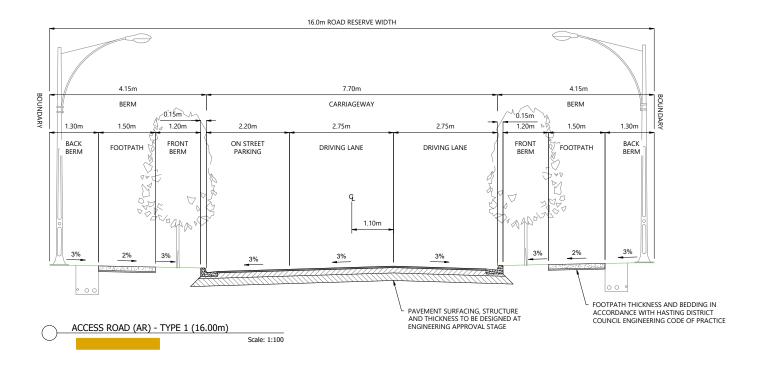

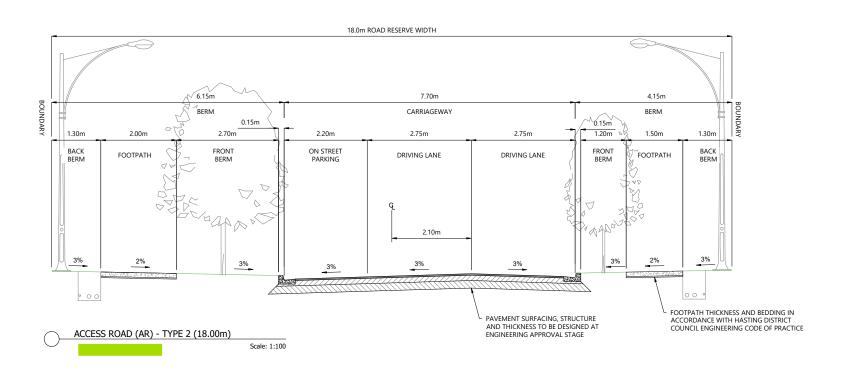

| SCALEBAR (m) | | SCALE 1:100 @A3 1:50 @A1 |
|--------------|---|------------------------------|
| 0 1 | 2 | 5 |
| | | |

| l | | | | | |
|------------------|-----------------------|-----|-----------|----------|-------|
| REVISION DETAILS | | INT | DATE | SURVEYED | WOODS |
| 1 | ISSUED FOR DISCUSSION | BM | APR 2025 | DESIGNED | AB |
| 2 | ISSUED FOR CONSENT | ТВ | JUNE 2025 | DRAWN | ВМ |
| | | | | CHECKED | BLO |
| | | | | APPROVED | BF |




BUILDING B, LEVEL 1
8 NUGENT ST, GRAFTON,
AUCKLAND 1023
+64 9 308 9229


WOODS.CO.NZ




ARATAKI DEVELOPMENT - HAVELOCK NORTH TYPICAL CROSS SECTIONS ACCESS ROAD TYPE 1 & TYPE 2


| STATUS | ISSUED FOR CONSENT | REV |
|---------|---------------------------|-----|
| SCALE | 1:100 @ A3 | 2 |
| COUNCIL | HASTINGS DISTRICT COUNCIL | |
| DWG NO | P24-244-00-2202-RD | ١ |

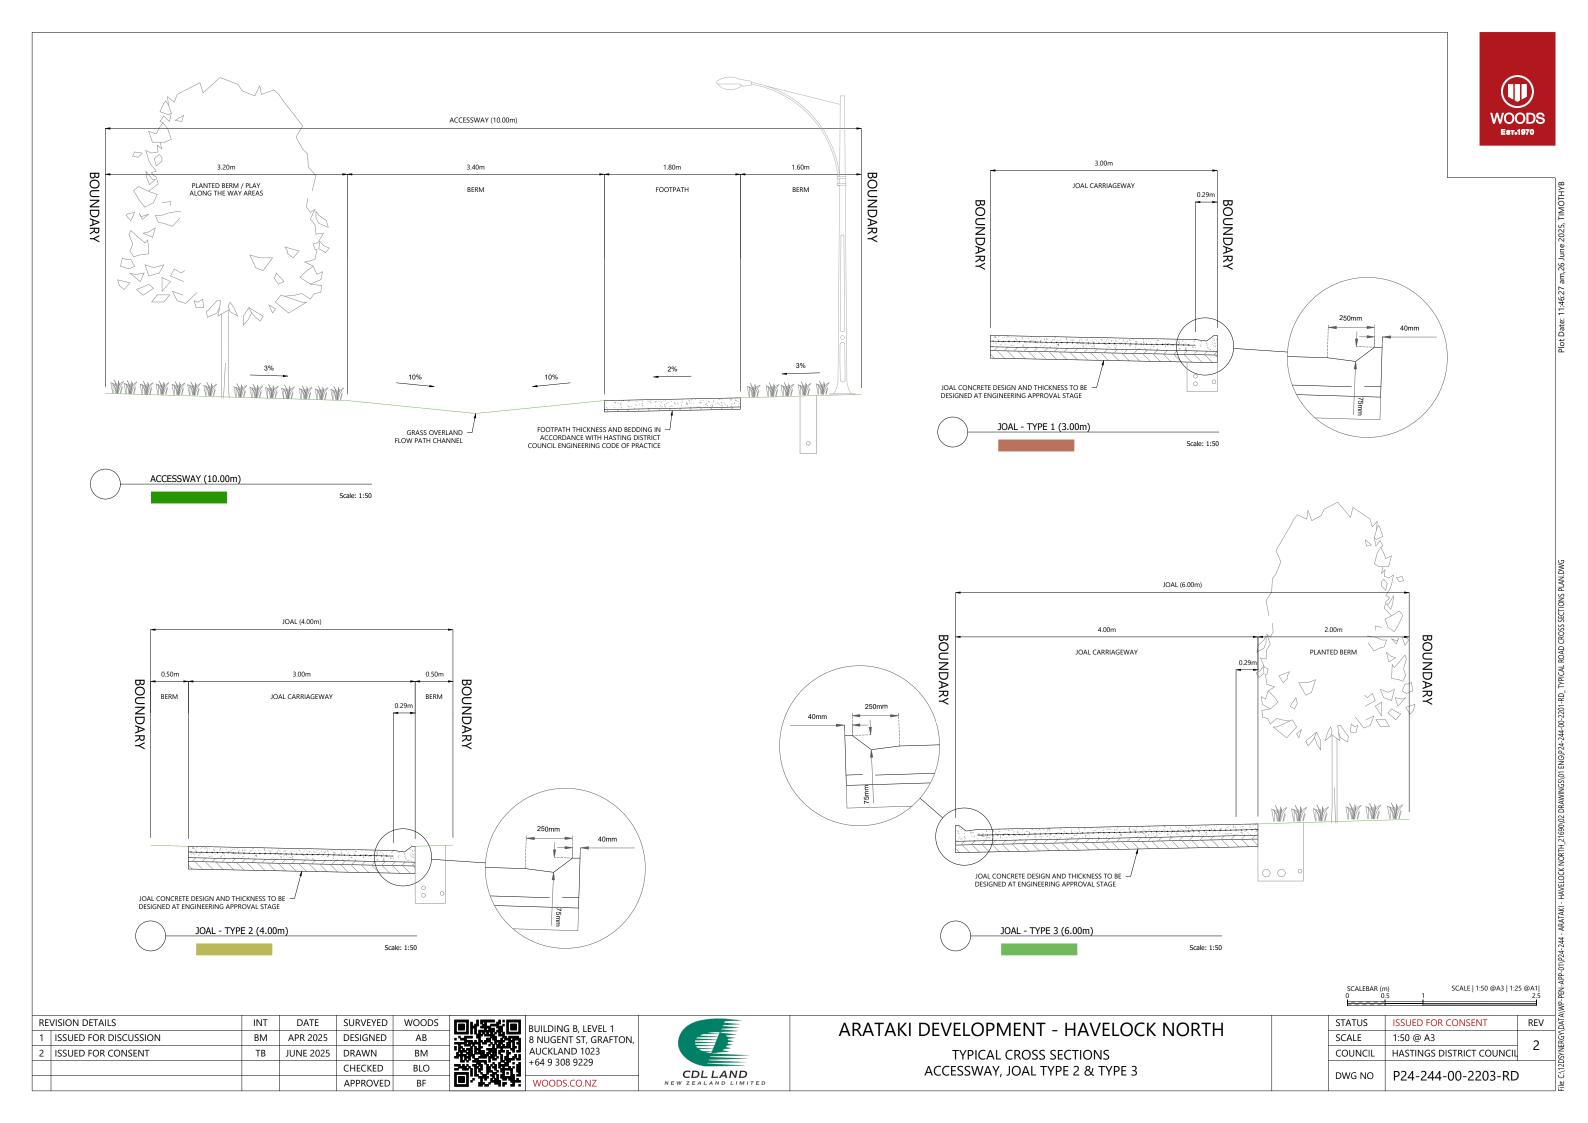

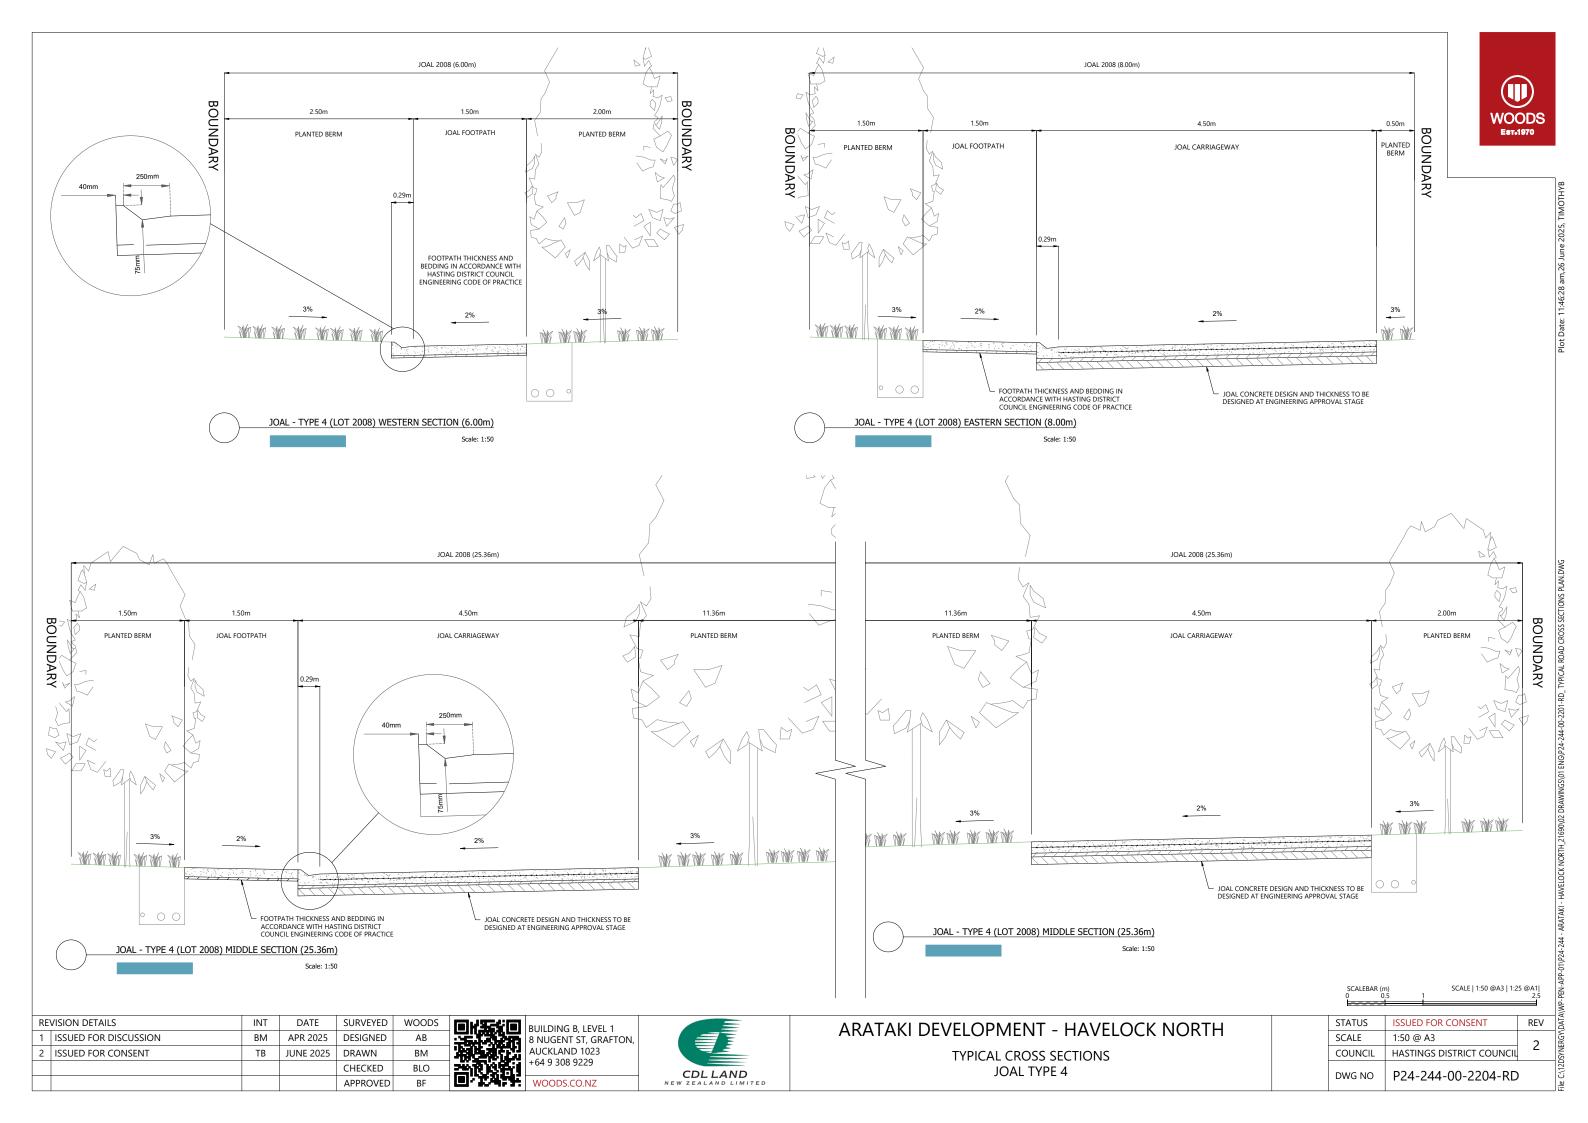

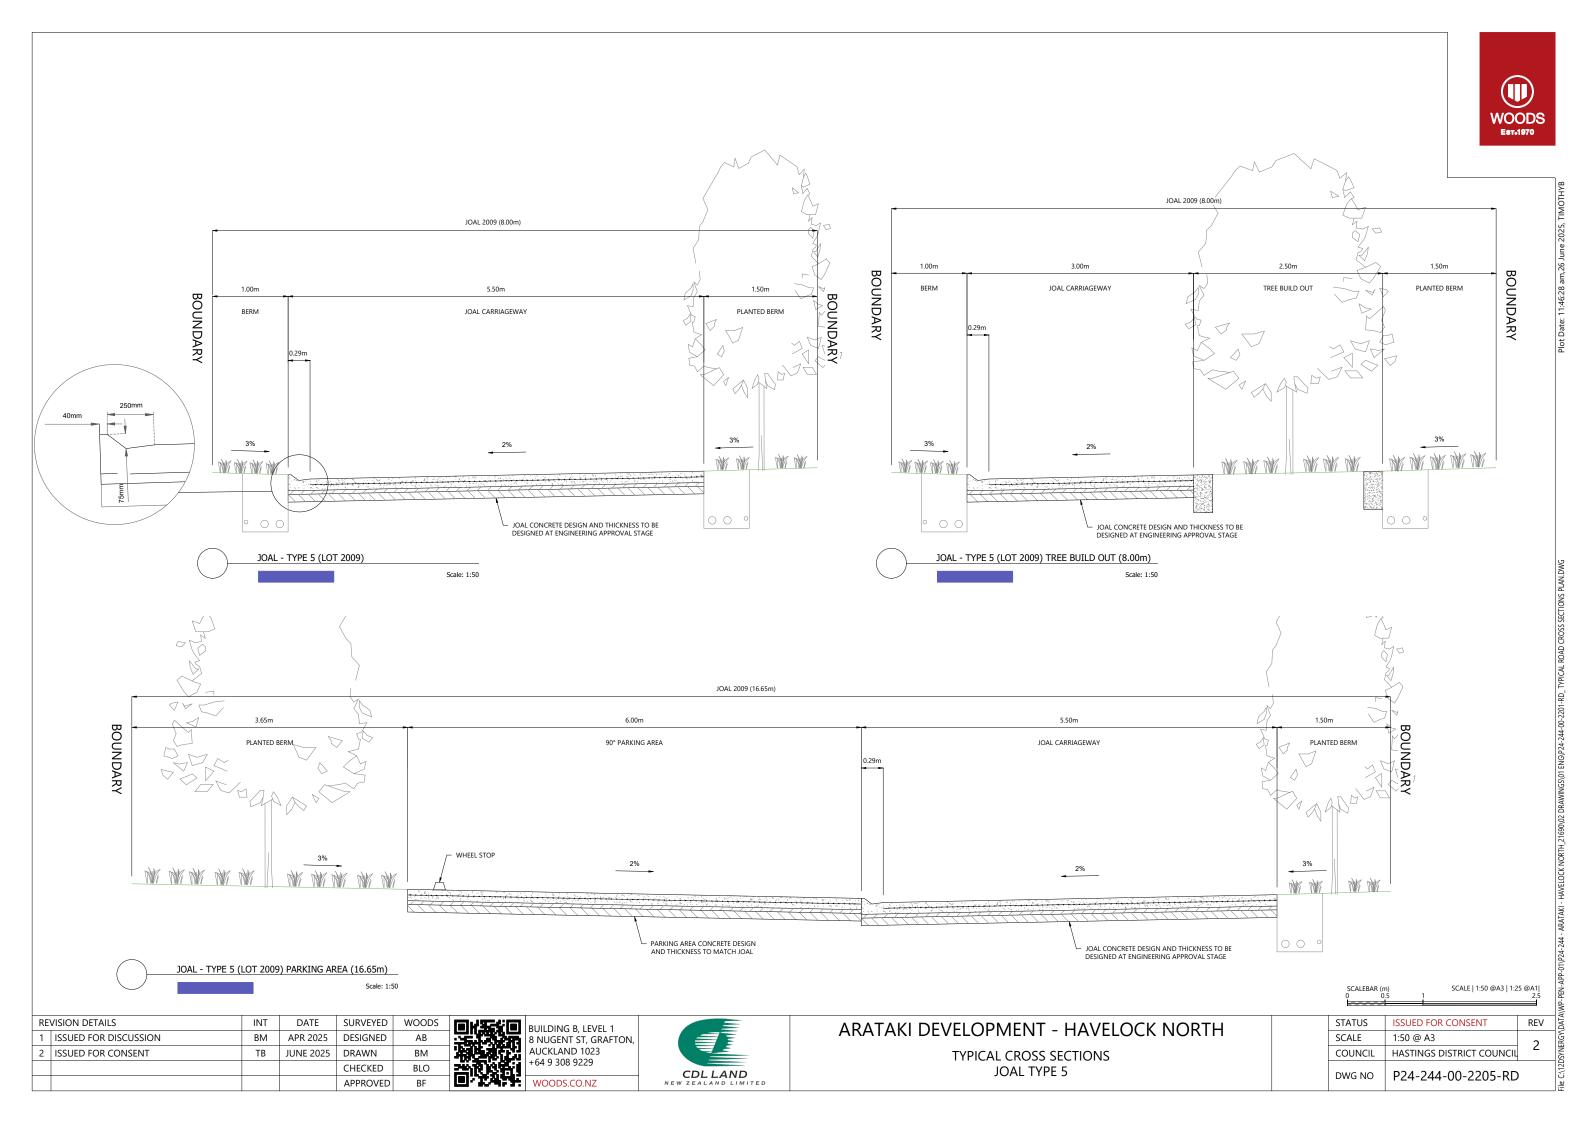



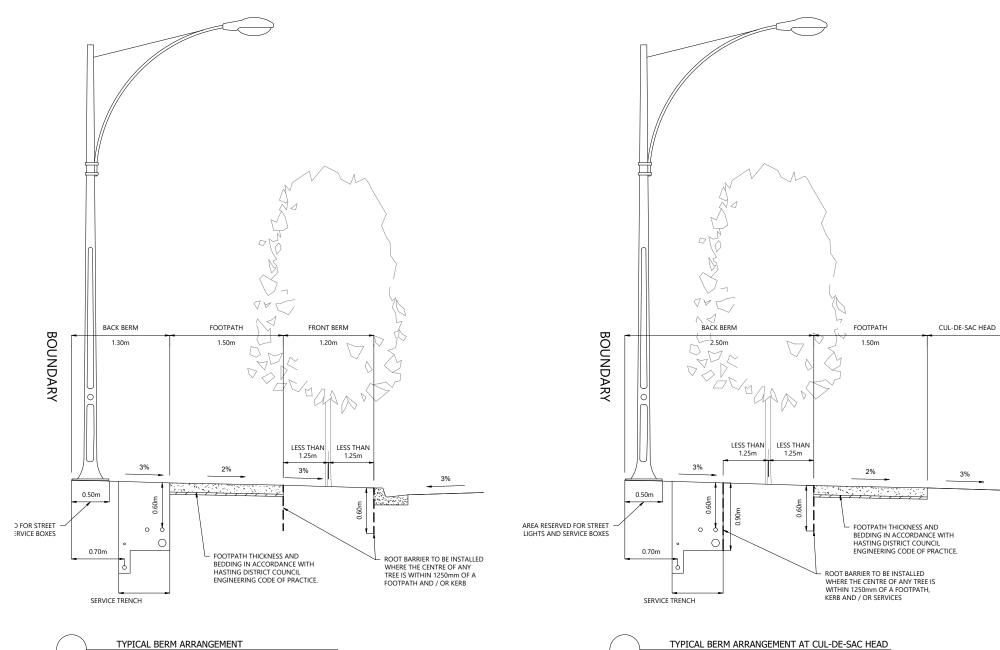

Scale: 1:50

REVISION DETAILS INT DATE SURVEYED WOODS 1 ISSUED FOR DISCUSSION ВМ APR 2025 DESIGNED 2 ISSUED FOR CONSENT ТВ JUNE 2025 DRAWN BM BLO CHECKED



Scale: 1:50

APPROVED

BUILDING B, LEVEL 1 8 NUGENT ST, GRAFTON, AUCKLAND 1023 +64 9 308 9229 WOODS.CO.NZ




ARATAKI DEVELOPMENT - HAVELOCK NORTH


TYPICAL CROSS SECTIONS TYPICAL BERM ARRANGEMENT

| STATUS | ISSUED FOR CONSENT | REV |
|---------|---------------------------|-----|
| SCALE | 1:50 @ A3 | 2 |
| COUNCIL | HASTINGS DISTRICT COUNCIL | |
| DWG NO | P24-244-00-2206-RD | 1 |

SCALE | 1:50 @A3 | 1:25 @A1|

SCALEBAR (m) 0 0.5

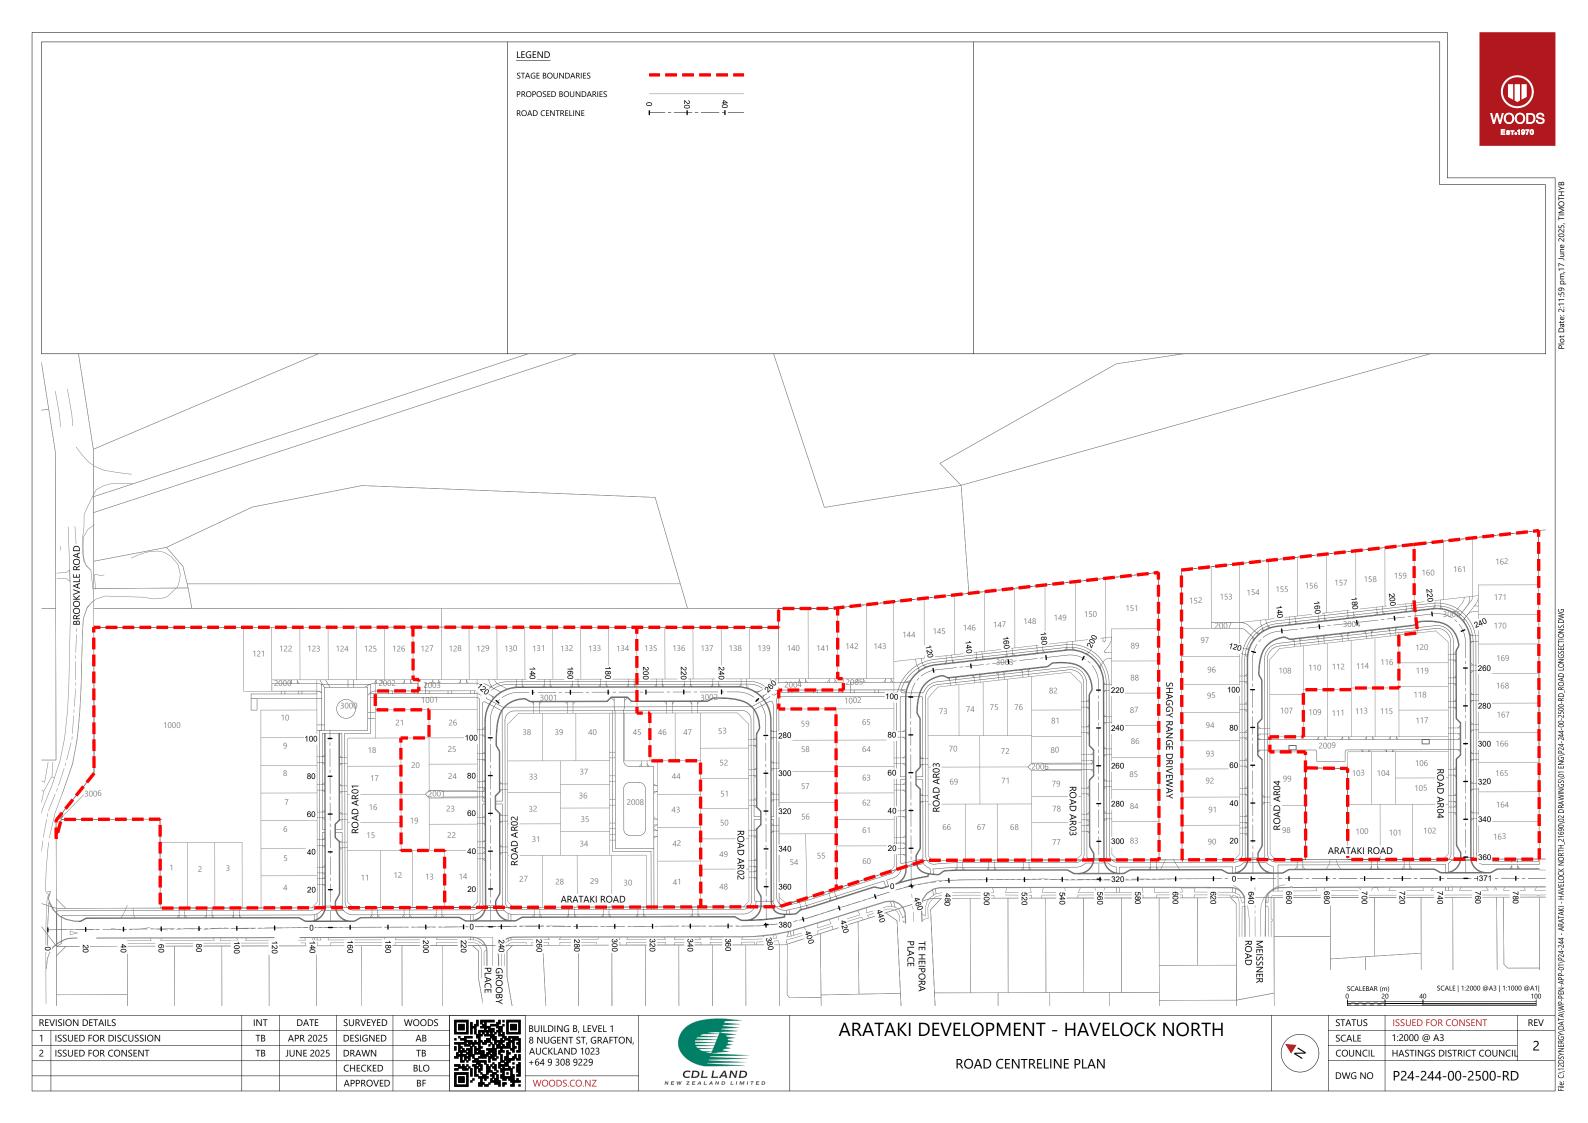

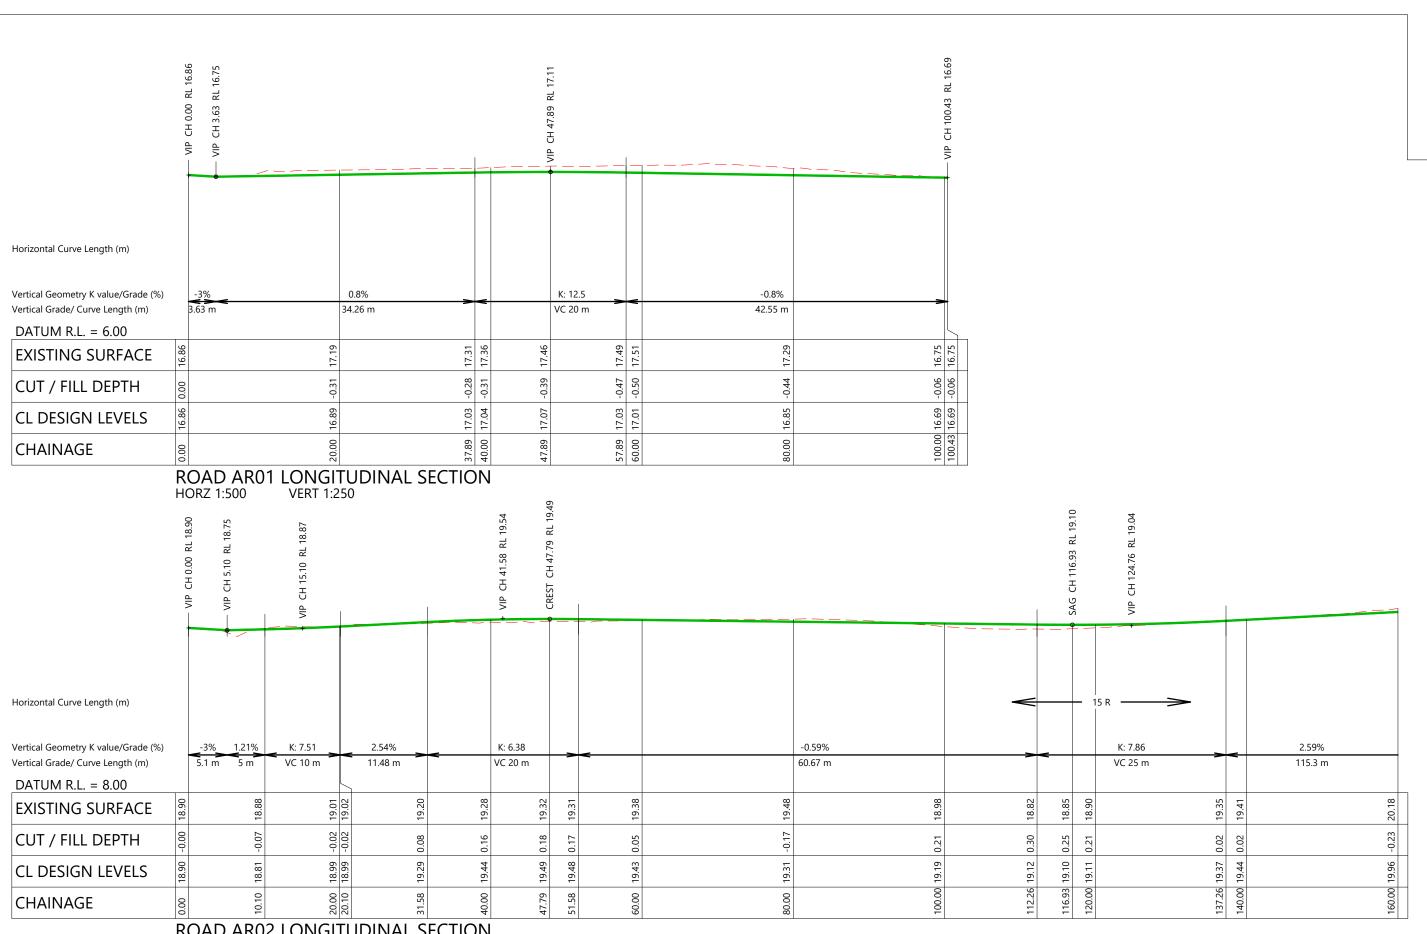

ROAD AR02 LONGITUDINAL SECTION HORZ 1:500 VERT 1:250

| SCALI | BAR (m) | | SCALE 1:500 @A3 1:250 @A1 |
|--------|---------|-----|---------------------------------------|
| HOR. 0 | 5 | 10 | 25 |
| VERT. | 2.5 | 5.0 | 12.5 SCALE 1:250 @A3 1:150 @A1 |

WOODS

| REVISION DETAILS | | INT | DATE | SURVEYED | WOODS |
|------------------|-----------------------|-----|-----------|----------|-------|
| 1 | ISSUED FOR DISCUSSION | ТВ | APR 2025 | DESIGNED | AB |
| 2 | ISSUED FOR CONSENT | ТВ | JUNE 2025 | DRAWN | TB |
| | | | | CHECKED | BLO |
| | | | | APPROVED | RF |



BUILDING B, LEVEL 1
8 NUGENT ST, GRAFTO
AUCKLAND 1023
+64 9 308 9229

WOODS.CO.NZ 8 NUGENT ST, GRAFTON,




| ARATAKI DEVELOPMENT | - HAVELOCK NORTH |
|---------------------|------------------|
| | |

| ROAD LONGSECTIONS - SHEET 1 | |
|-----------------------------|--|
| NO/ID CONTROLLENT | |

| VENI. | SCALE 1:250 @A3 1:150 | [2.5 @A1 | \WP- |
|---------|---------------------------|---------------|------------------------------|
| STATUS | ISSUED FOR CONSENT | REV | DATA |
| SCALE | AS SHOWN | 2 | RGY |
| COUNCIL | HASTINGS DISTRICT COUNCIL | | SYNE |
| DWG NO | P24-244-00-2501-RD | 1 | File: C\12DSYNERGY\DATA\WP-F |



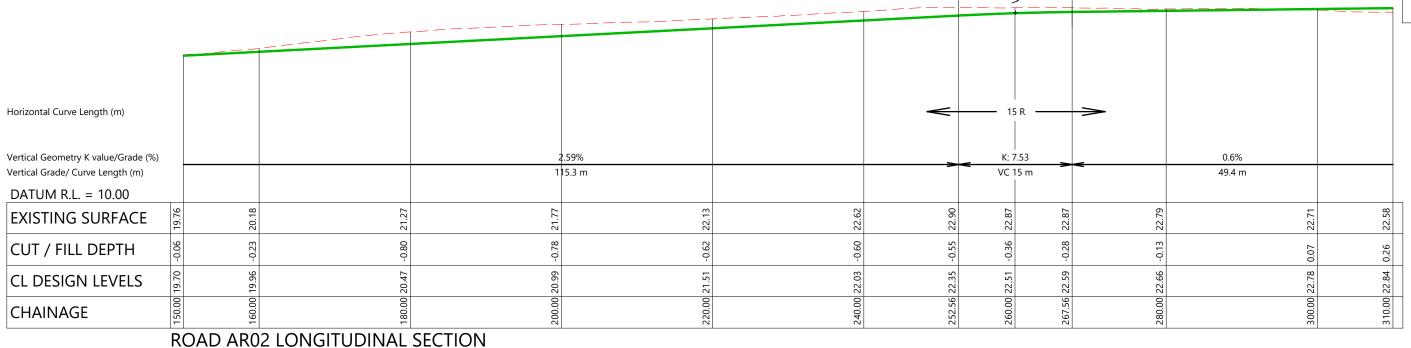

HORZ 1:500 VERT 1:250 RL 21.97 CH 377.12 RL 21.87 \exists ΛIP Horizontal Curve Length (m) Vertical Geometry K value/Grade (%) 0.6% K: 7.59 -2.7% K: 5.88 6.65 m 3.25 m Vertical Grade/ Curve Length (m) 49.4 m VC 25 m 18.51 m VC 10 m DATUM R.L. = 12.00 22.42 22.38 22.18 **EXISTING SURFACE** CUT / FILL DEPTH 380.00 21.96 -380.37 21.97 -22.90 22.90 22.67 CL DESIGN LEVELS CHAINAGE

> **ROAD AR02 LONGITUDINAL SECTION** HORZ 1:500 VERT 1:250

| SCAL | EBAR (m) | | SCALE 1:500 @A3 1:250 @A1 |
|--------|----------|-----|---------------------------------------|
| HOR. 0 | 5 | 10 | 25 |
| VERT. | 2.5 | 5.0 | 12.5 SCALE 1:250 @A3 1:150 @A1 |

| | 1 ISSUED FOR DISCUSSION 2 ISSUED FOR CONSENT | | INI | DATE | SURVEYED | WOODS |
|--|--|--|-----|-----------|----------|-------|
| | | | ТВ | APR 2025 | DESIGNED | AB |
| | | | ТВ | JUNE 2025 | DRAWN | TB |
| | | | | | CHECKED | BLO |
| | | | | | APPROVED | RF |



BUILDING B, LEVEL 1
8 NUGENT ST, GRAFTO
AUCKLAND 1023
+64 9 308 9229


WOODS.CO.NZ 8 NUGENT ST, GRAFTON,



| ARATAKI DEVELOPMENT - HAVELOCK NORTH |
|--------------------------------------|
| |

| ROAD LONGSECTIONS - SHEET 2 |
|-----------------------------|
| |

| | | · ' |
|---------|---------------------------|-----|
| STATUS | ISSUED FOR CONSENT | REV |
| SCALE | AS SHOWN | 2 |
| COUNCIL | HASTINGS DISTRICT COUNCIL | 2 |
| DWG NO | P24-244-00-2502-RD | |

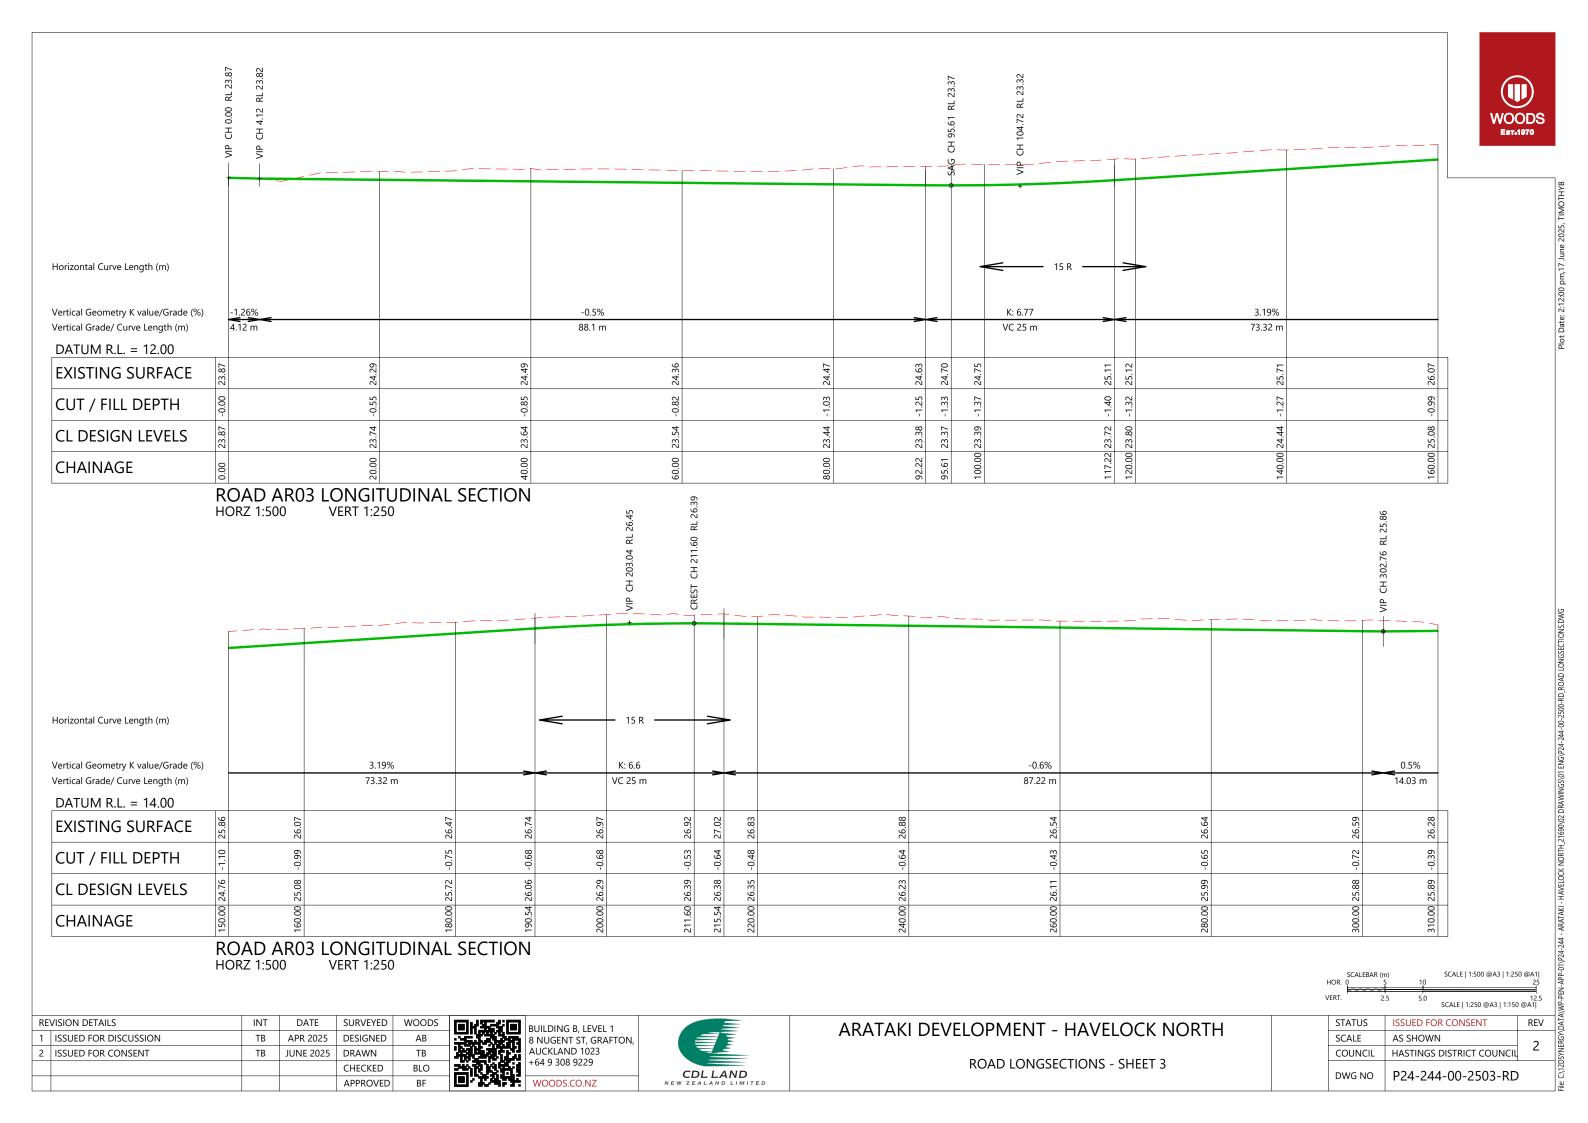



RL 26.03 CH 316.79 RL 25.93 CH 320.04 ΝN Horizontal Curve Length (m) Vertical Geometry K value/Grade (%) 0.5% 3.25 m Vertical Grade/ Curve Length (m) 14.03 m DATUM R.L. = 16.00 **EXISTING SURFACE** 320.00 26.03 -0.00 320.04 26.03 -0.00 CUT / FILL DEPTH CL DESIGN LEVELS CHAINAGE

> **ROAD ARO3 LONGITUDINAL SECTION** HORZ 1:500 VERT 1:250

CH 12.35 RL 27.38 CH 14.03 RL 27.42 VIP C Horizontal Curve Length (m) – 15 R Vertical Geometry K value/Grade (%) K: 1.89 1.22% 277.42 m Vertical Grade/ Curve Length (m) 8.35 m VC 8 m DATUM R.L. = 18.00 27.78 28.09 28.83 **EXISTING SURFACE** -0.36 0.37 CUT / FILL DEPTH 27.42 27.43 27.72 28.46 29.19 28.95 CL DESIGN LEVELS 16.35 60.00 CHAINAGE

> **ROAD AR04 LONGITUDINAL SECTION** HORZ 1:500 VERT 1:250

INT DATE CURVEYED WOODS

| SCALI | EBAR (m) | | SCALE 1:500 @A3 1:250 @A1 | ľ |
|--------|----------|-----|---------------------------------------|---|
| HOR. 0 | 5 | 10 | 25 | l |
| VERT. | 2.5 | 5.0 | 12.5 SCALE 1:250 @A3 1:150 @A1 | |

| | KE | REVISION DETAILS | | DATE | SURVEYED | WOODS |
|---|----|-----------------------|----|-----------|----------|-------|
| 1 | | ISSUED FOR DISCUSSION | ТВ | APR 2025 | DESIGNED | AB |
| | 2 | ISSUED FOR CONSENT | ТВ | JUNE 2025 | DRAWN | TB |
| | | | | | CHECKED | BLO |
| | | | | | APPROVED | BF |

DEVICION DETAILS




BUILDING B, LEVEL 1
8 NUGENT ST, GRAFTC
AUCKLAND 1023
+64 9 308 9229
WOODS.CO.NZ 8 NUGENT ST, GRAFTON,



| DO A DI LONGGE CTIONIC CLIE | |
|-----------------------------|-------------|
| ROAD LONGSECTIONS - SHE | <u>-</u> 14 |

| 50/12 1.250 @/15 1.150 @ | | | | | |
|------------------------------|---------------------------|-----|--|--|--|
| STATUS | ISSUED FOR CONSENT | REV | | | |
| SCALE | AS SHOWN | | | | |
| COUNCIL | HASTINGS DISTRICT COUNCIL | 2 | | | |
| DWG NO P24-244-00-2504-RD | | | | | |

씸

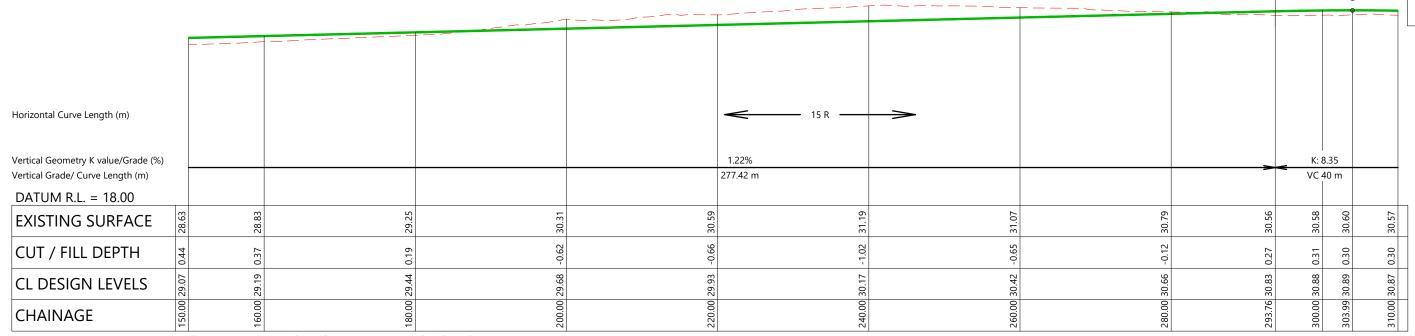

ROAD AR04 LONGITUDINAL SECTION


HORZ 1:500 VERT 1:250 CH 357.23 $\overline{\mathsf{MP}}$ Horizontal Curve Length (m) Vertical Geometry K value/Grade (%) K: 8.35 -3.57% K: 1.68 8.54 m VC 40 m 17.97 m VC 11 m Vertical Grade/ Curve Length (m) DATUM R.L. = 20.00 30.18 30.16 29.96 9 9 **EXISTING SURFACE** CUT / FILL DEPTH 29.62 29.63 29.69 371.27 29.95 CL DESIGN LEVELS 357.70 CHAINAGE

> **ROAD AR04 LONGITUDINAL SECTION** HORZ 1:500 VERT 1:250

| SCAL | EBAR (m) | | SCALE 1:500 @A3 1:250 @A1 |
|--------|----------|-----|---------------------------------------|
| HOR. 0 | 5 | 10 | 25 |
| VERT. | 2.5 | 5.0 | 12.5 SCALE 1:250 @A3 1:150 @A1 |

| | KE | REVISION DETAILS | | DATE | SURVEYED | WOODS |
|---|----|-----------------------|----|-----------|----------|-------|
| 1 | | ISSUED FOR DISCUSSION | ТВ | APR 2025 | DESIGNED | AB |
| | 2 | ISSUED FOR CONSENT | ТВ | JUNE 2025 | DRAWN | TB |
| | | | | | CHECKED | BLO |
| | | | | | APPROVED | BF |

DEVICIONI DETAILC

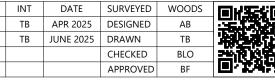


BUILDING B, LEVEL 1
8 NUGENT ST, GRAFTC
AUCKLAND 1023
+64 9 308 9229
WOODS.CO.NZ 8 NUGENT ST, GRAFTON,





| ARATAKI DEVELOPMENT - HAVELOCK NORTH |
|--------------------------------------|
| |


| ROAD LONGSECTIONS - SHEET 5 |
|-----------------------------|
|-----------------------------|


| | | · | |
|--|---------|---------------------------|-----|
| | STATUS | ISSUED FOR CONSENT | REV |
| | SCALE | AS SHOWN | 2 |
| | COUNCIL | HASTINGS DISTRICT COUNCIL | 2 |
| | | | |

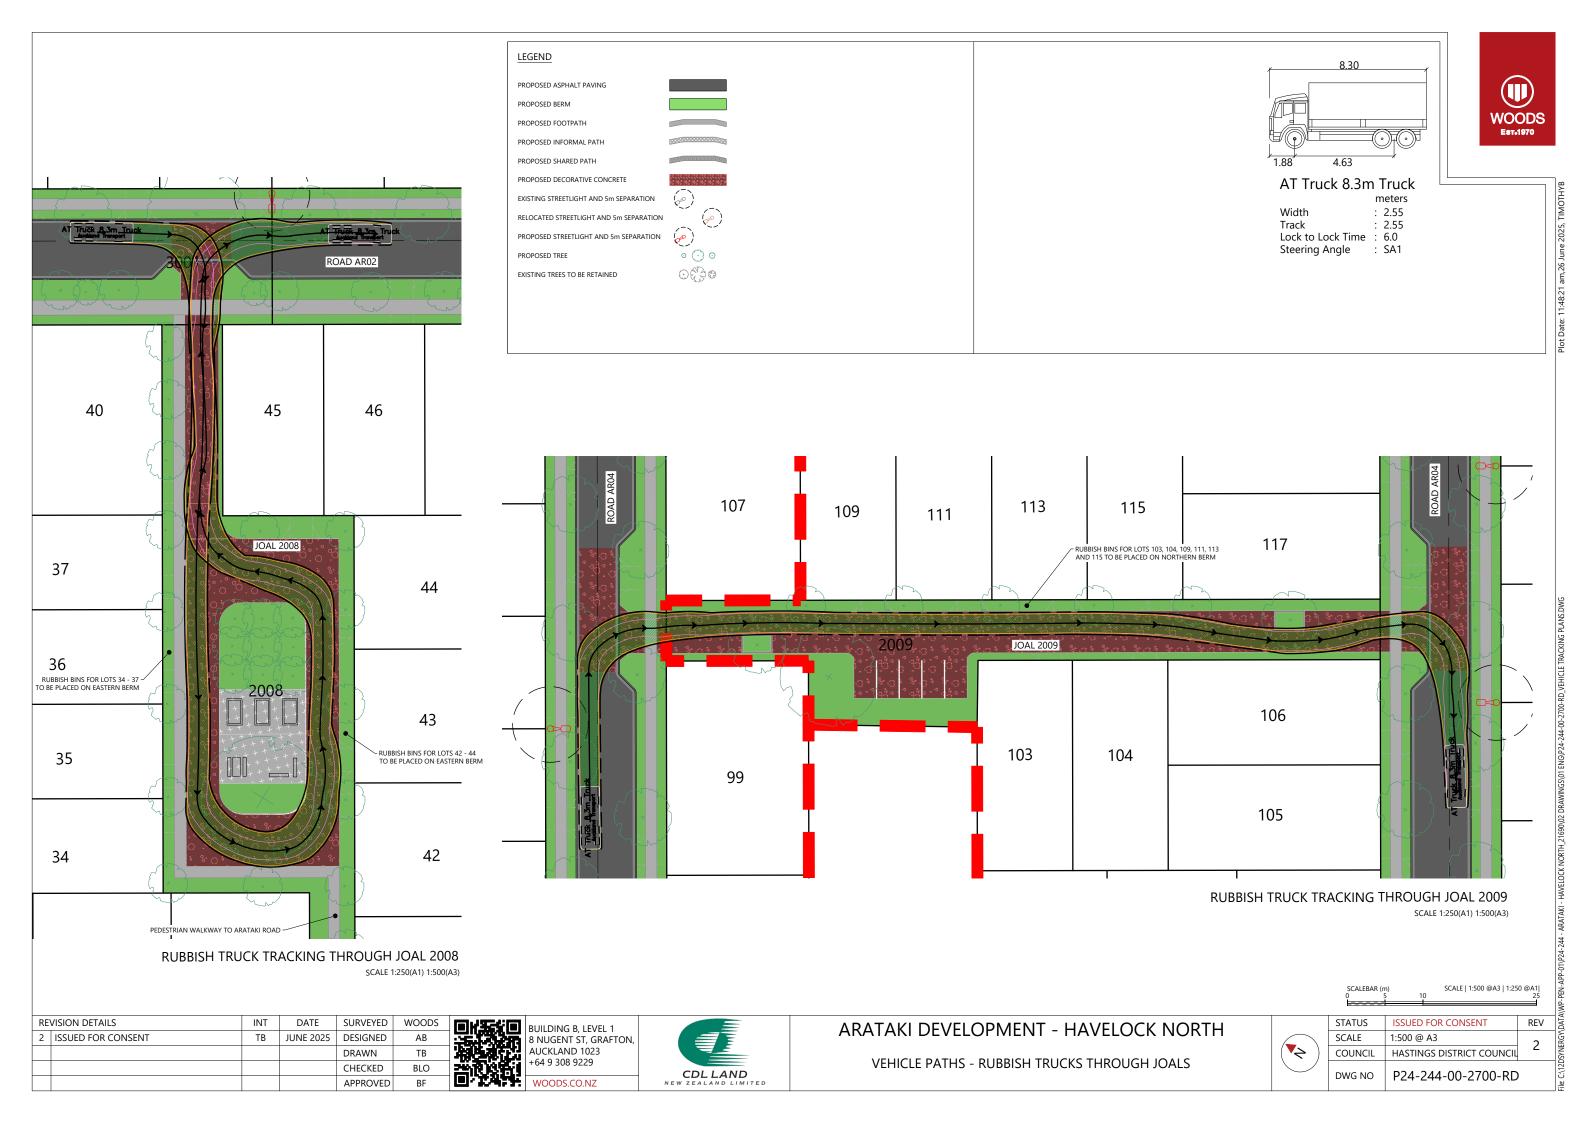


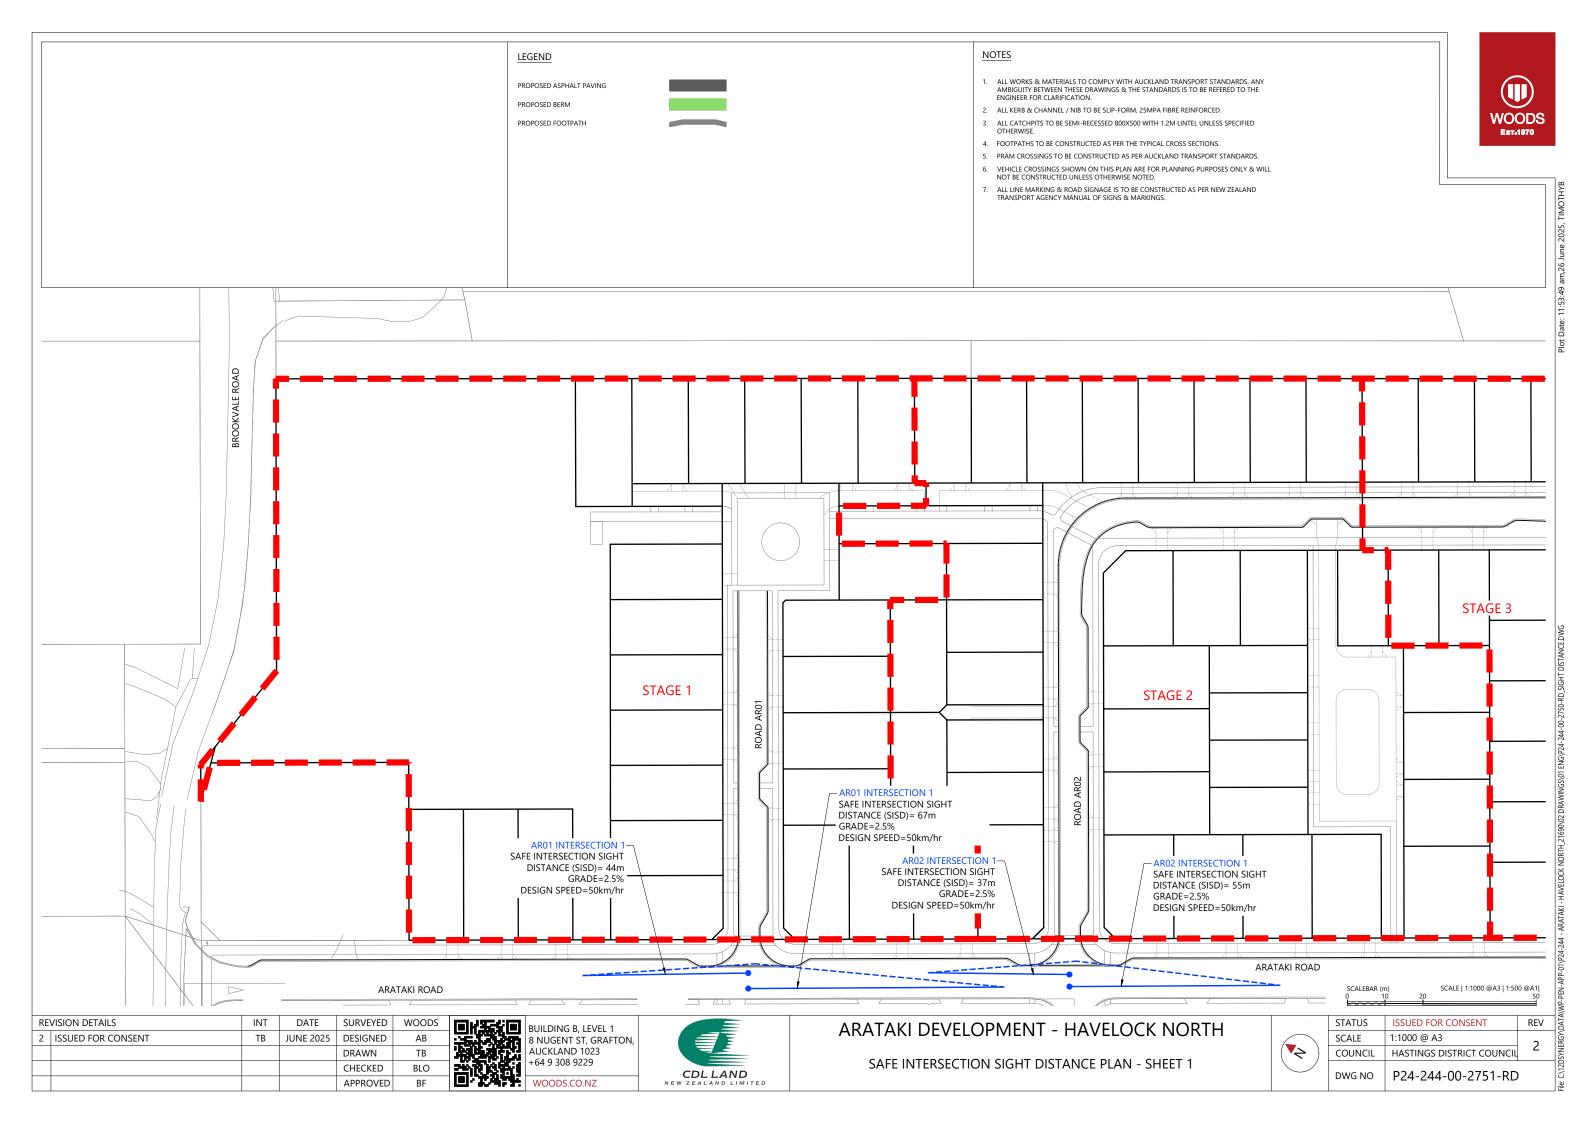


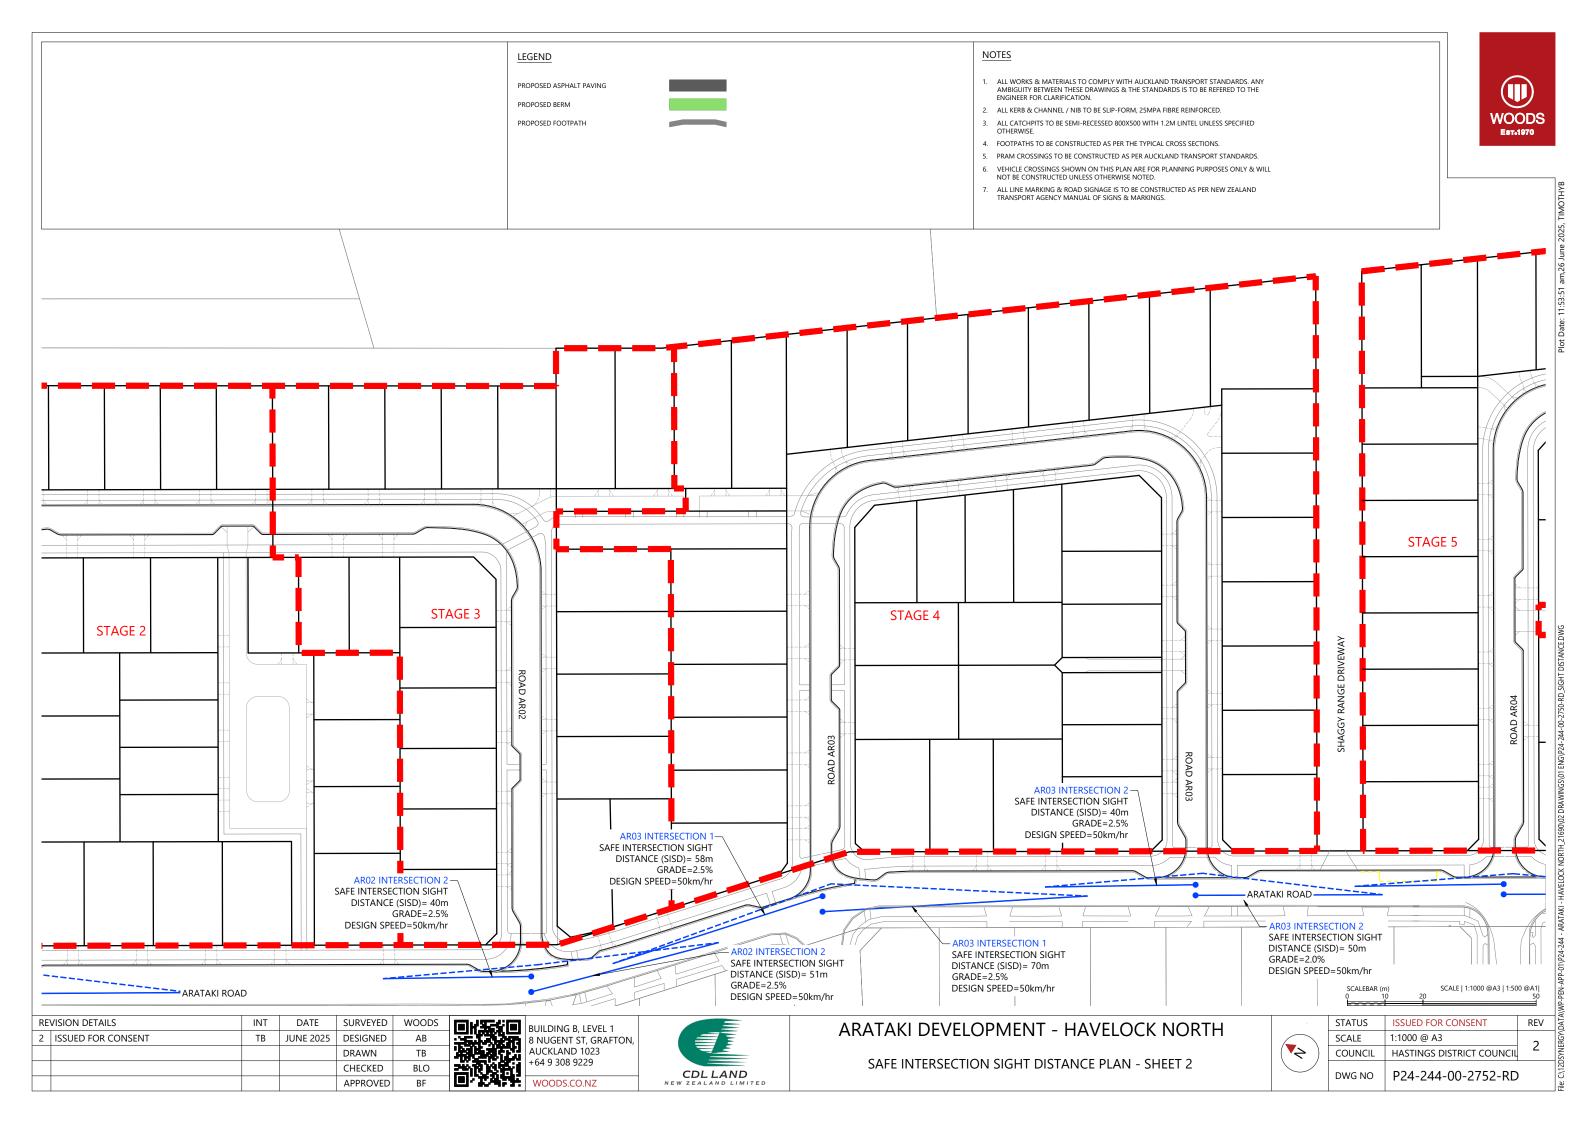


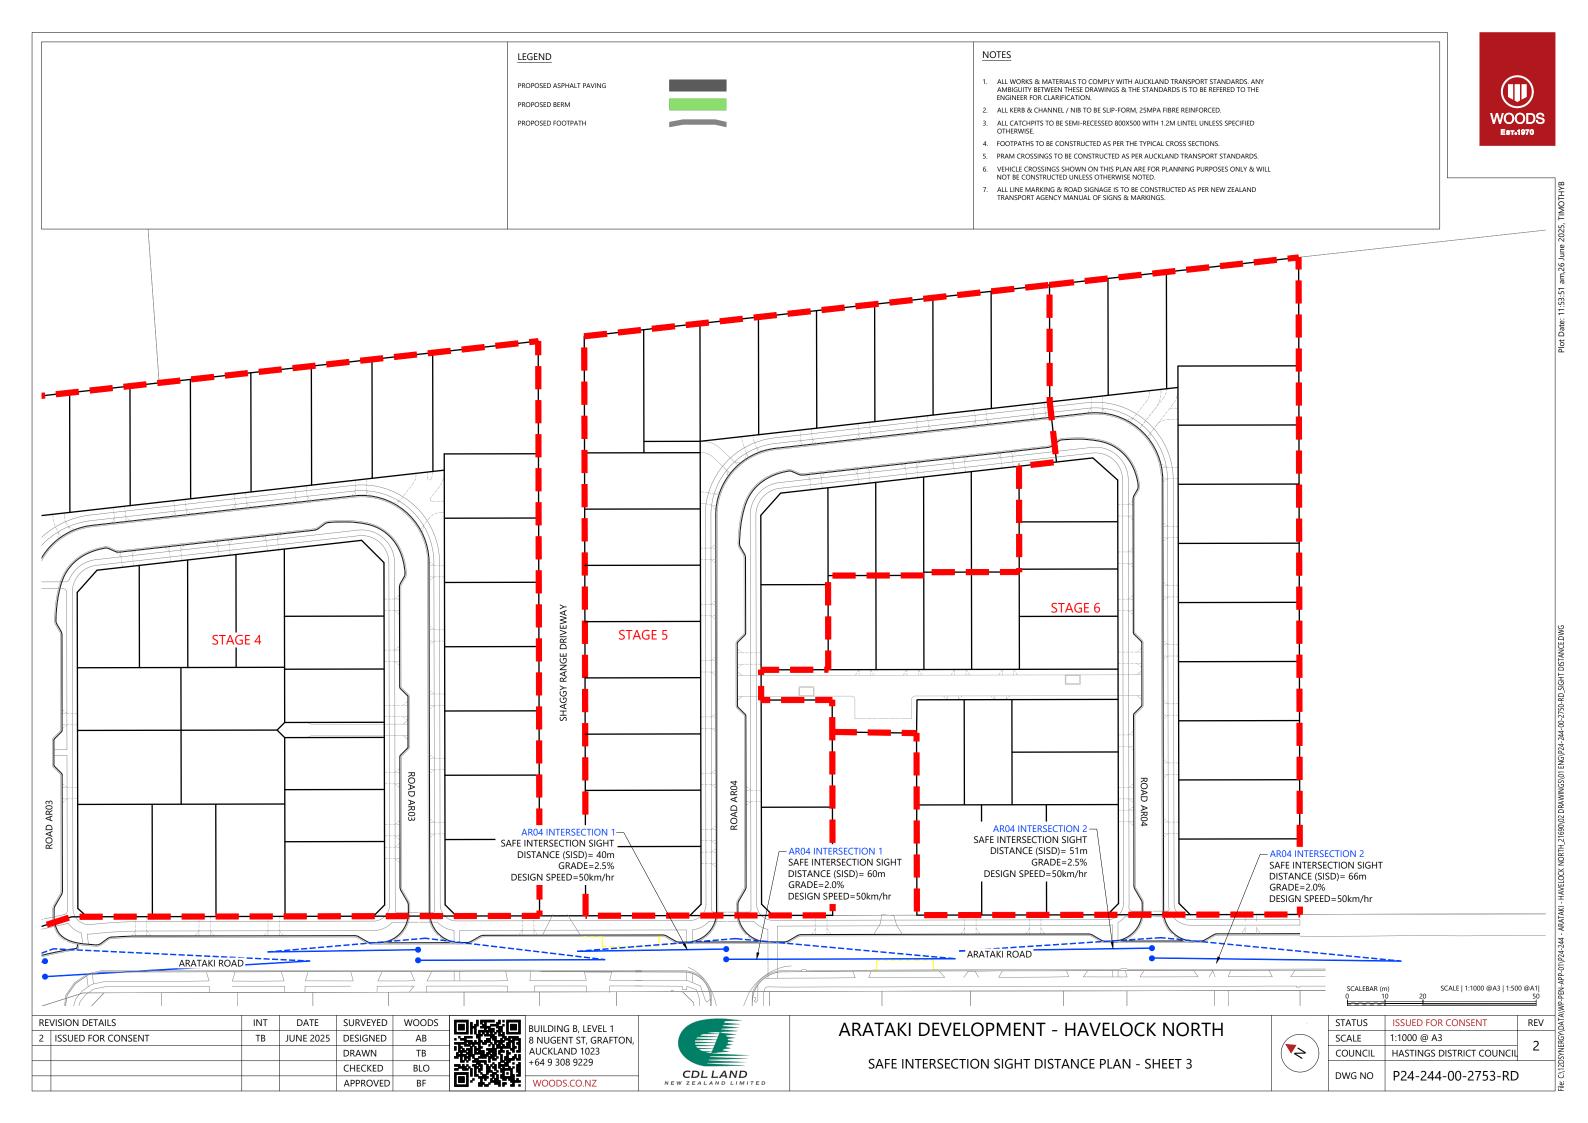


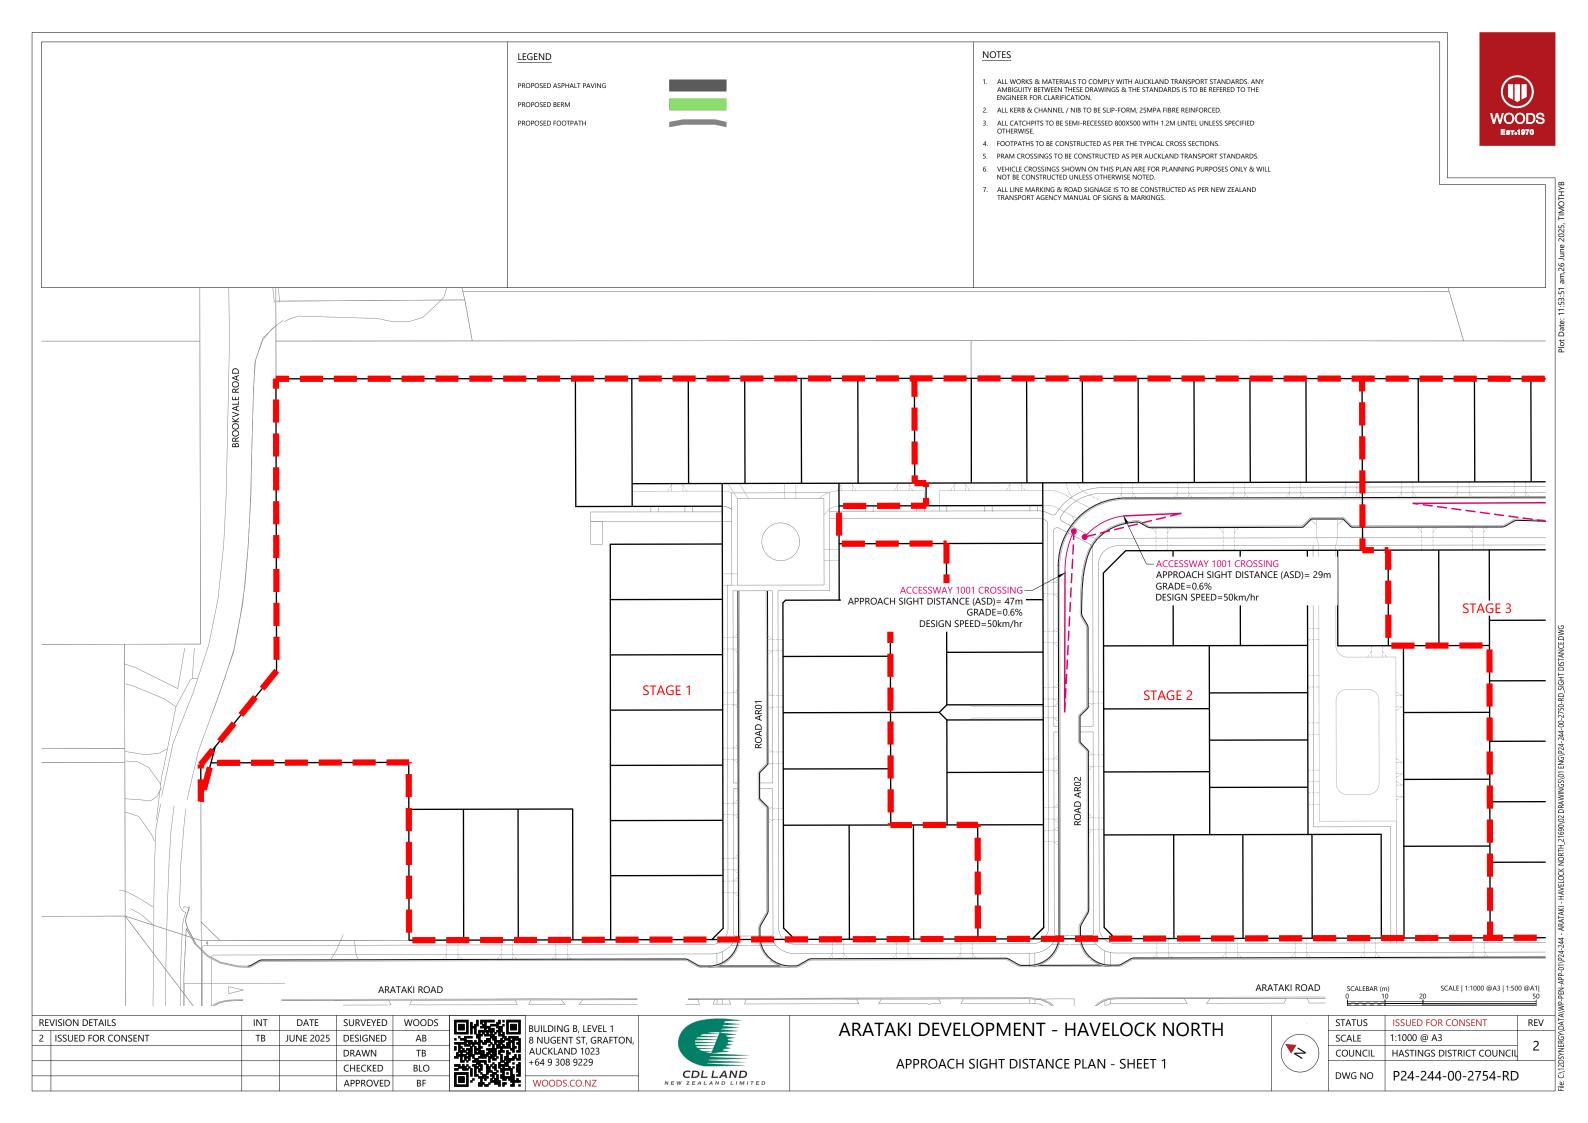


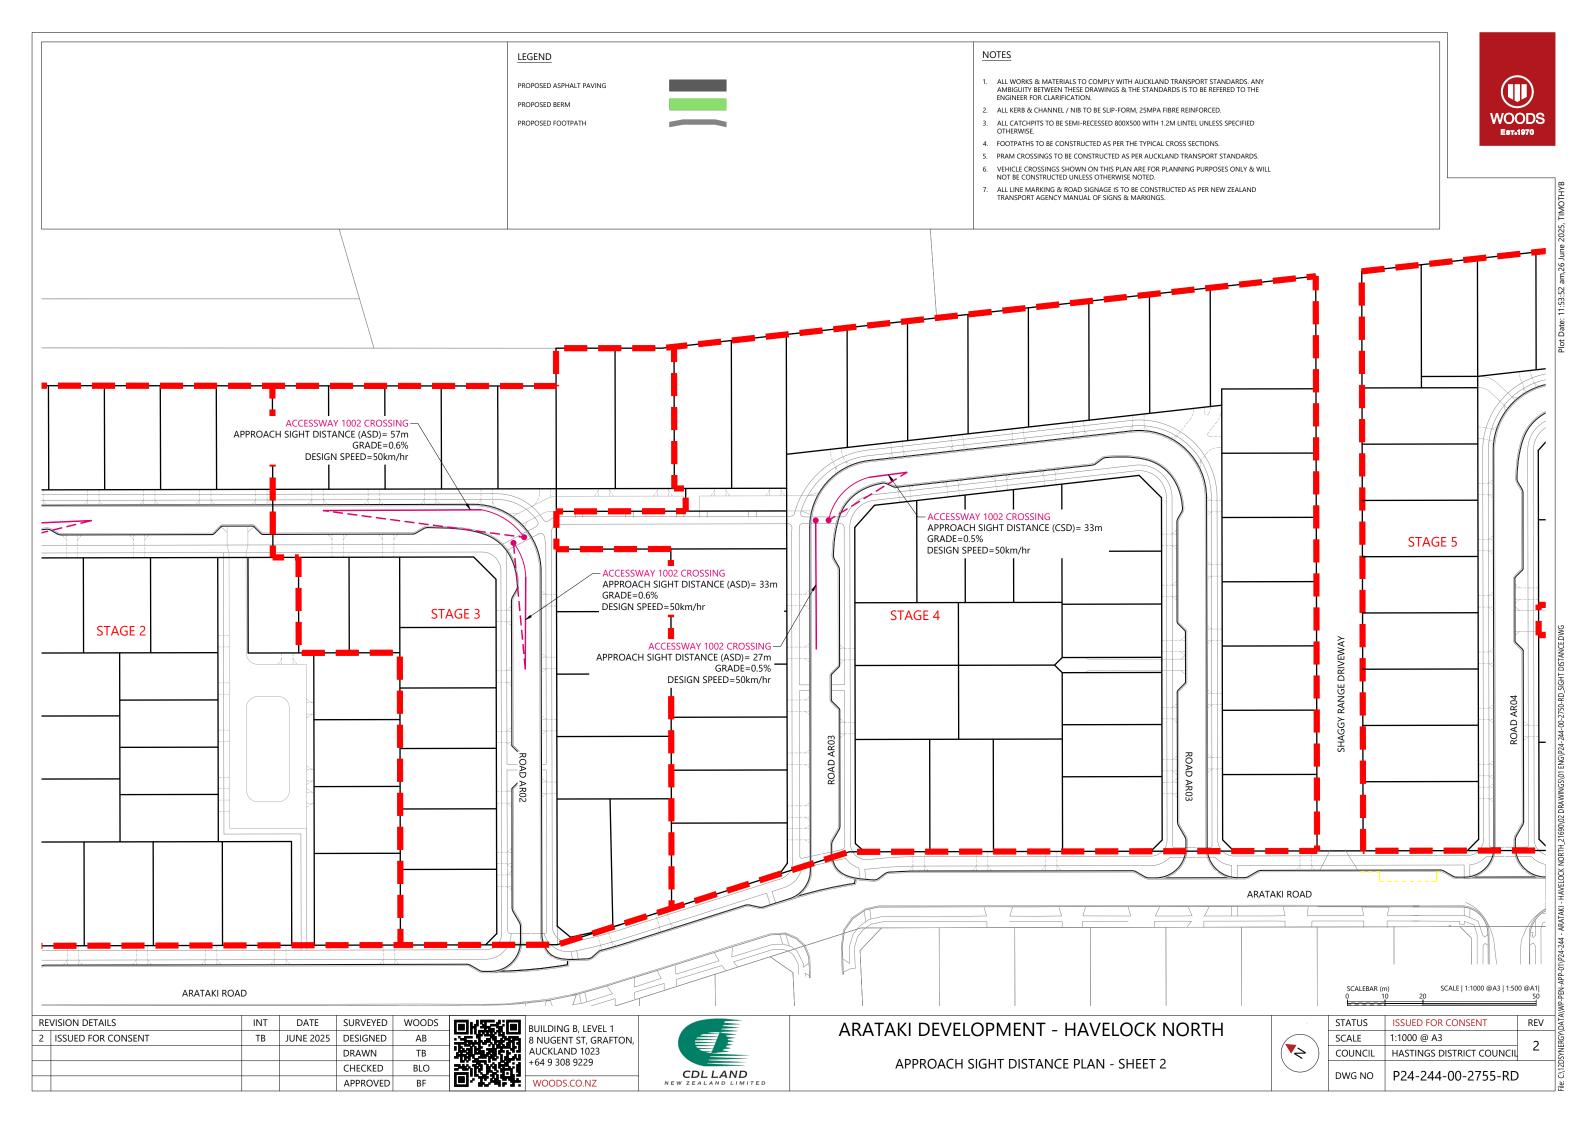

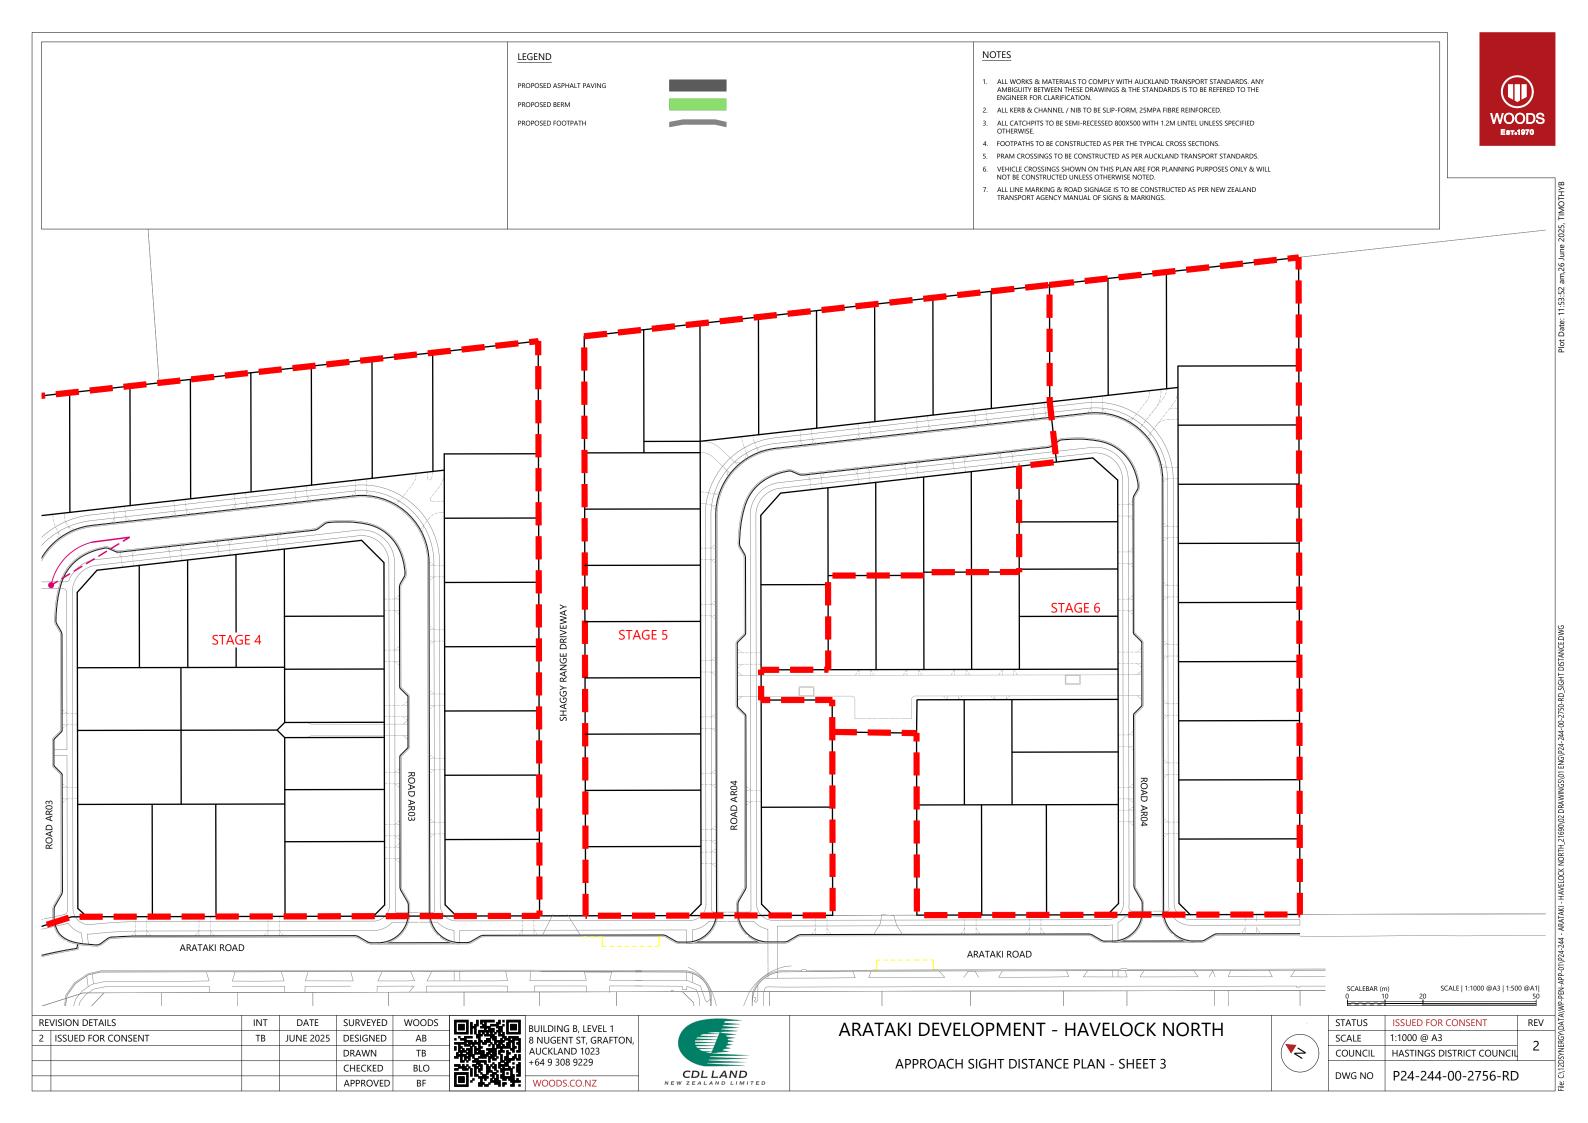

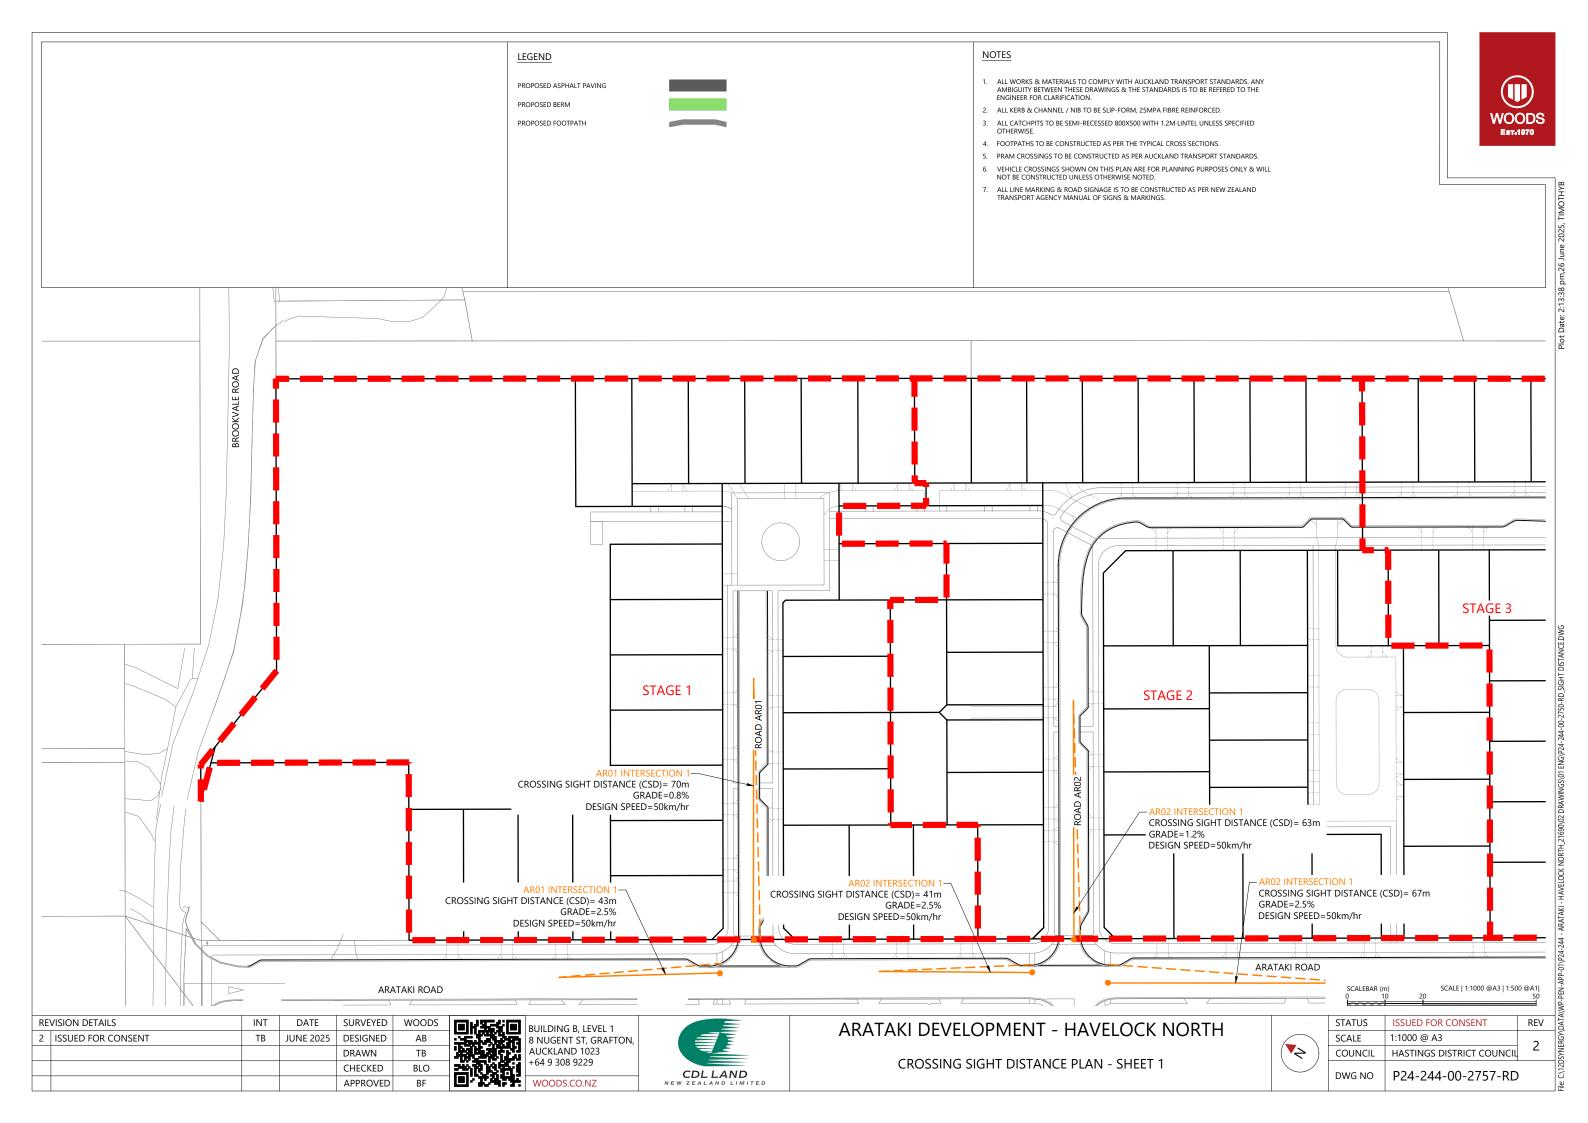

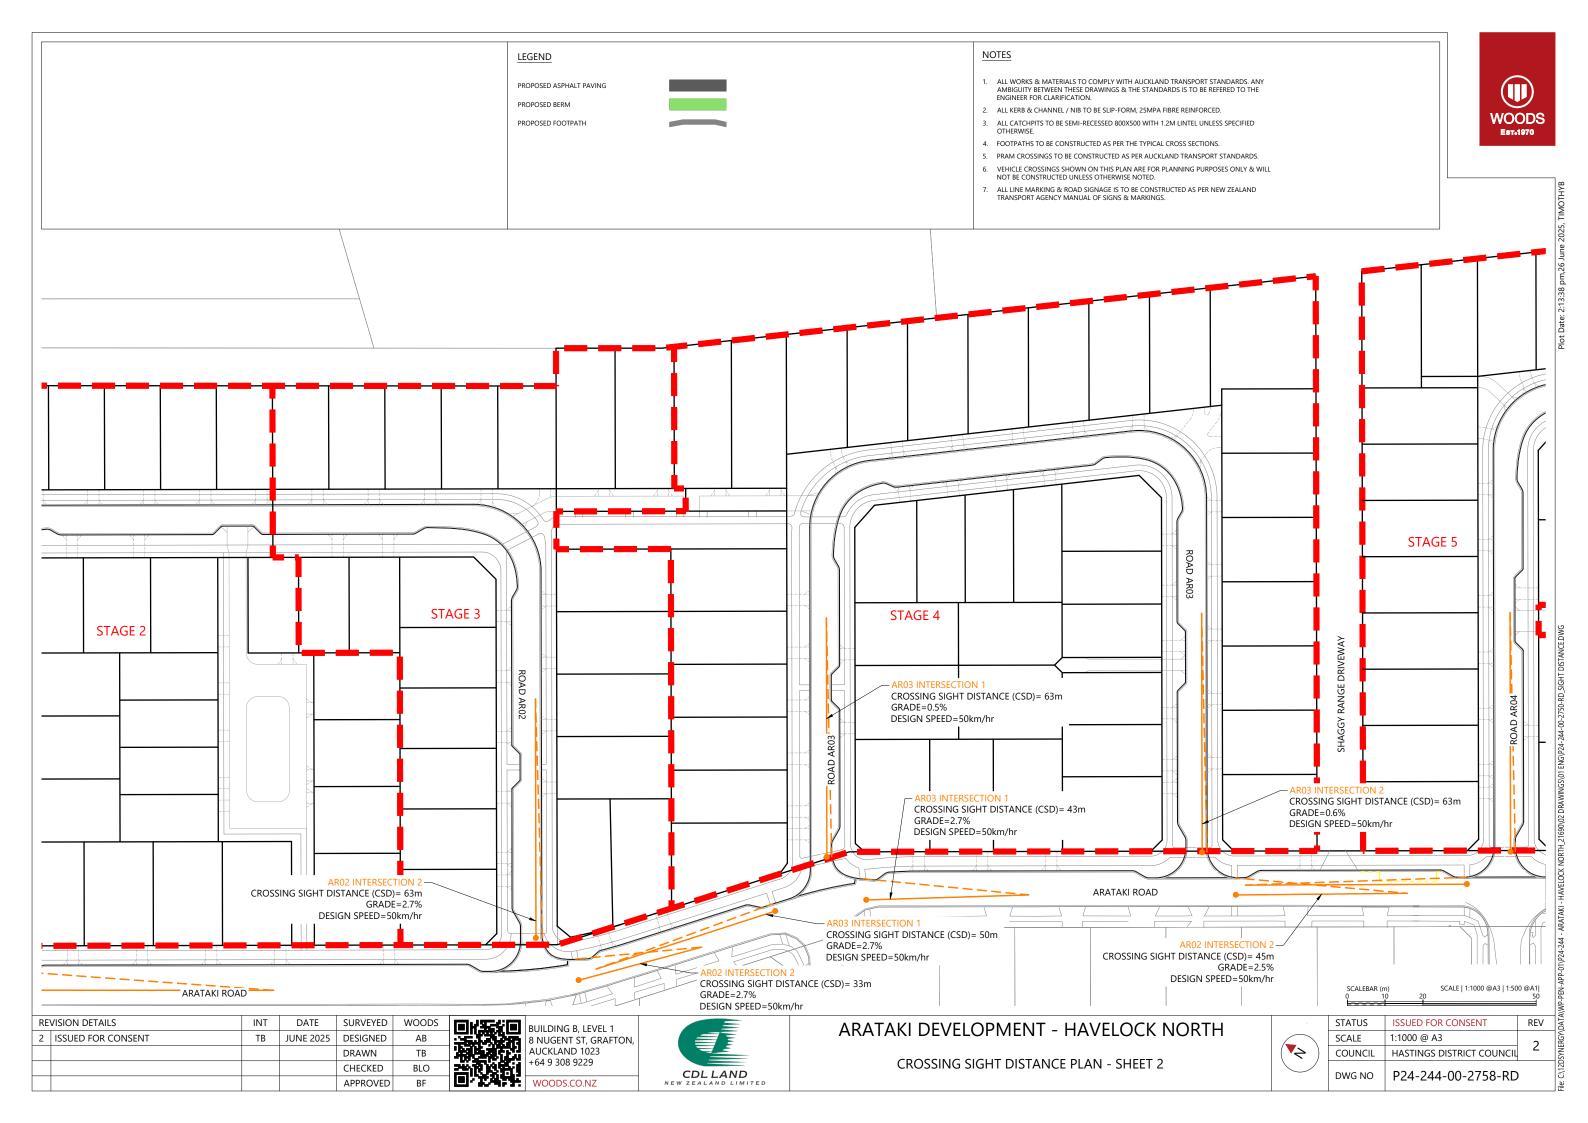


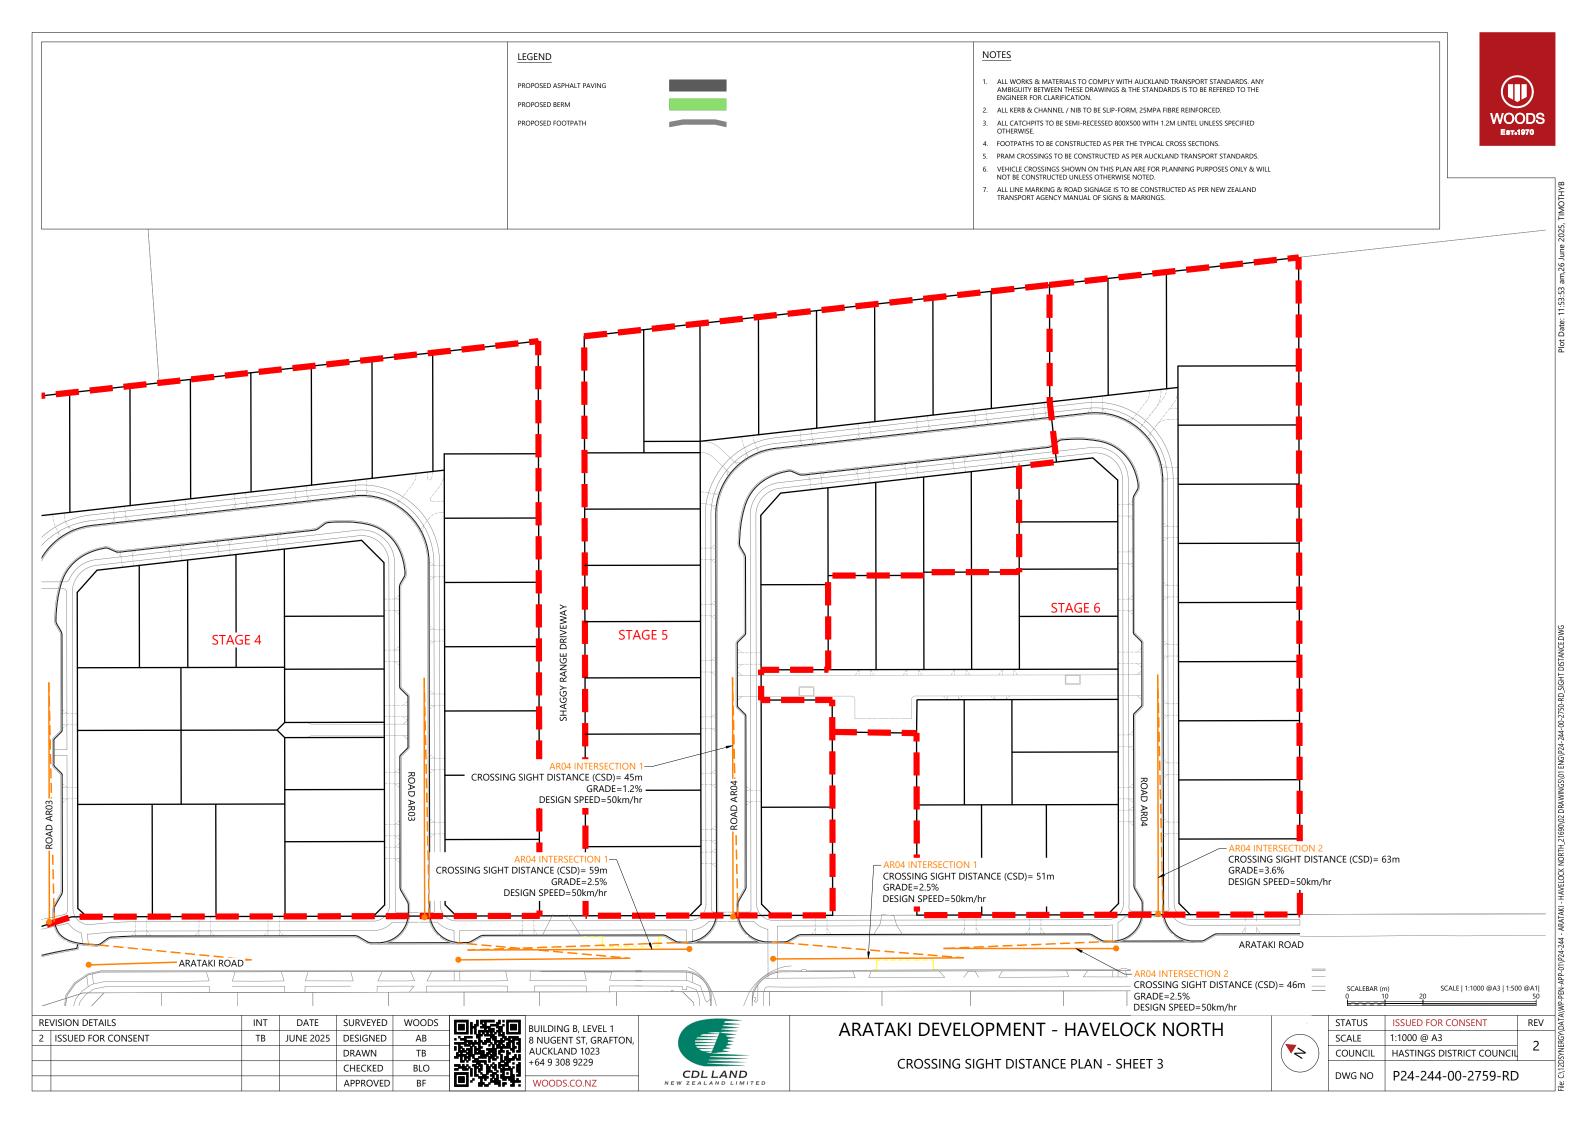

WOODS

TRIM Reference

VARIES. CONCRETE DEPTH 'D' (SEE TABLE BELOW) 4) KFRB & CHANNEL

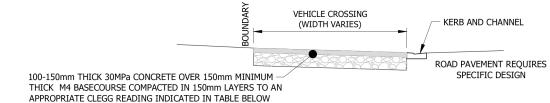


SECTION A-A

| Property D | escription | Min. Width 'W' | Max. Width 'W' | Concrete Depth 'D' | Mesh Reinforcing | Basecourse Thickness | Target Clegg Reading |
|--------------------------------|------------------------------|----------------|----------------|-----------------------|---------------------|-------------------------|-------------------------|
| | 1-2 Dwellings | 3m | 4.8m | 100mm | No | 150mm | 25 |
| Residential | 3-4 Dwellings | 4m | 4.8m | 125mm | No | 150mm 25 | 25 |
| | 5+ Dwellings | 6m | 6m | 150mm | 1 Layer 665 | 200mm | 35 |
| Light Comm (not requiring s | nercial specific design). | 4m | 6m | 150mm | 1 Layer 665 | 200mm | 35 |
| Industrial (not requiring s | specific design). | 6m | 9m | 150mm | 1 Layer 665 | 200mm | 35 |

- 1. DEPTH OF BASECOURSE WILL DEPEND ON SUBGRADE STRENGTH. THE DEPTHS SHOWN ASSUME A SUBGRADE CBR > 5%. BASECOURSE IS TO BE COMPACTED TO 95% STANDARD COMPACTION.
- 2. FOR SUBGRADE STRENGTH BELOW CBR 5% SPECIFIC DESIGNS ARE REQUIRED.
- 3. CONCRETE STRENGTH TO BE A MINIMUM OF 30MPA AT 28 DAYS.
- 4. WHERE MOUNTABLE KERBS ARE PRESENT THERE IS TO BE NO CUT DOWN AND THE VEHICLE CROSSING WILL TIE INTO THE TOP OF KERR I EVEL
- 5. REFER TO DRAWING C19A FOR DETAILS OF KERB AND CHANNEL PROFILE ADJACENT TO SHARED CYCLEWAY AND FOOTPATH.

| HASTINGS DISTRICT COUNCIL | HASTINGS DISTRICT COUNCIL | NOT TO SCALE |
|--|-------------------------------|--------------|
| © Copyright in this drawing is owned by the Hastings District Council. | MINIMUM STANDARDS FOR VEHICLE | C19 |
| Any unauthorised copying or adaption of the whole or substantial part of the work in two or three dimensions is an infringement of copyright | CROSSINGS ONTO URBAN ROADS | NOV 2018 |

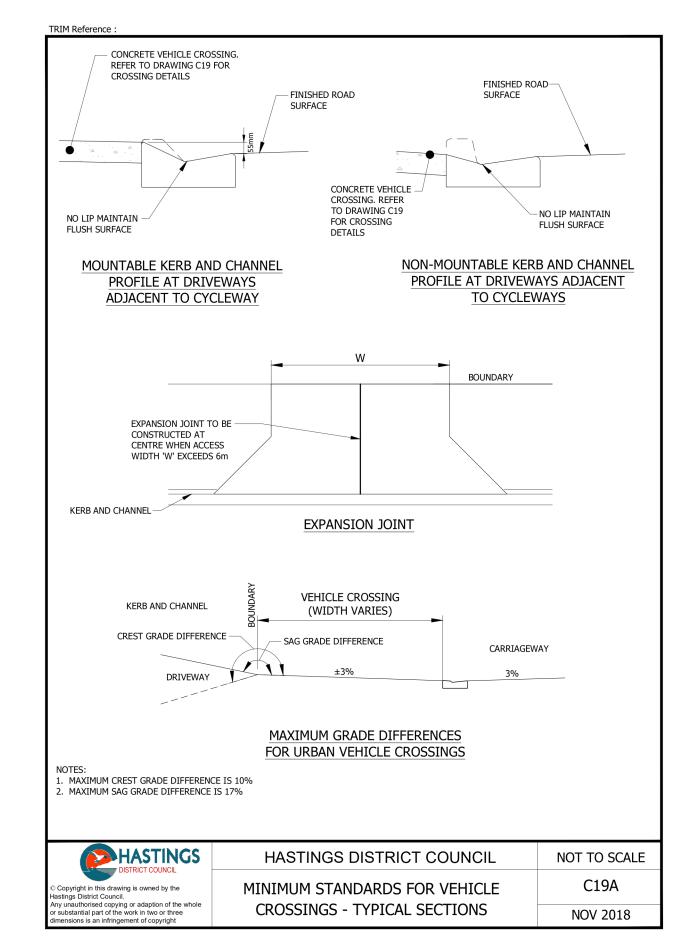

| REVISION DETAILS | | INT | DATE | SURVEYED | WOODS |
|------------------|---------------------|-----|-----------|----------|------------|
| 1 | ISSUED FOR APPROVAL | ТВ | MAY 2025 | DESIGNED | HASTINGSDC |
| 2 | ISSUED FOR CONSENT | ТВ | JUNE 2025 | DRAWN | ТВ |
| | | | | CHECKED | BLO |
| | | | | APPROVED | BF |




BUILDING B, LEVEL 1 8 NUGENT ST, GRAFTON AUCKLAND 1023 +64 9 308 9229 WOODS.CO.NZ



| ROAD DETAILS | |
|--------------------------|--|
| HDC ENG COP - C19 & C19A | |

| STATUS | ISSUED FOR CONSENT | REV | ΛDAT |
|---------|---------------------------|-----|----------|
| SCALE | NOT TO SCALE | 2 | RGY |
| COUNCIL | HASTINGS DISTRICT COUNCIL | | DSYNERGY |
| DWG NO | P24-244-00-2800-RD |) | P. C.\12 |



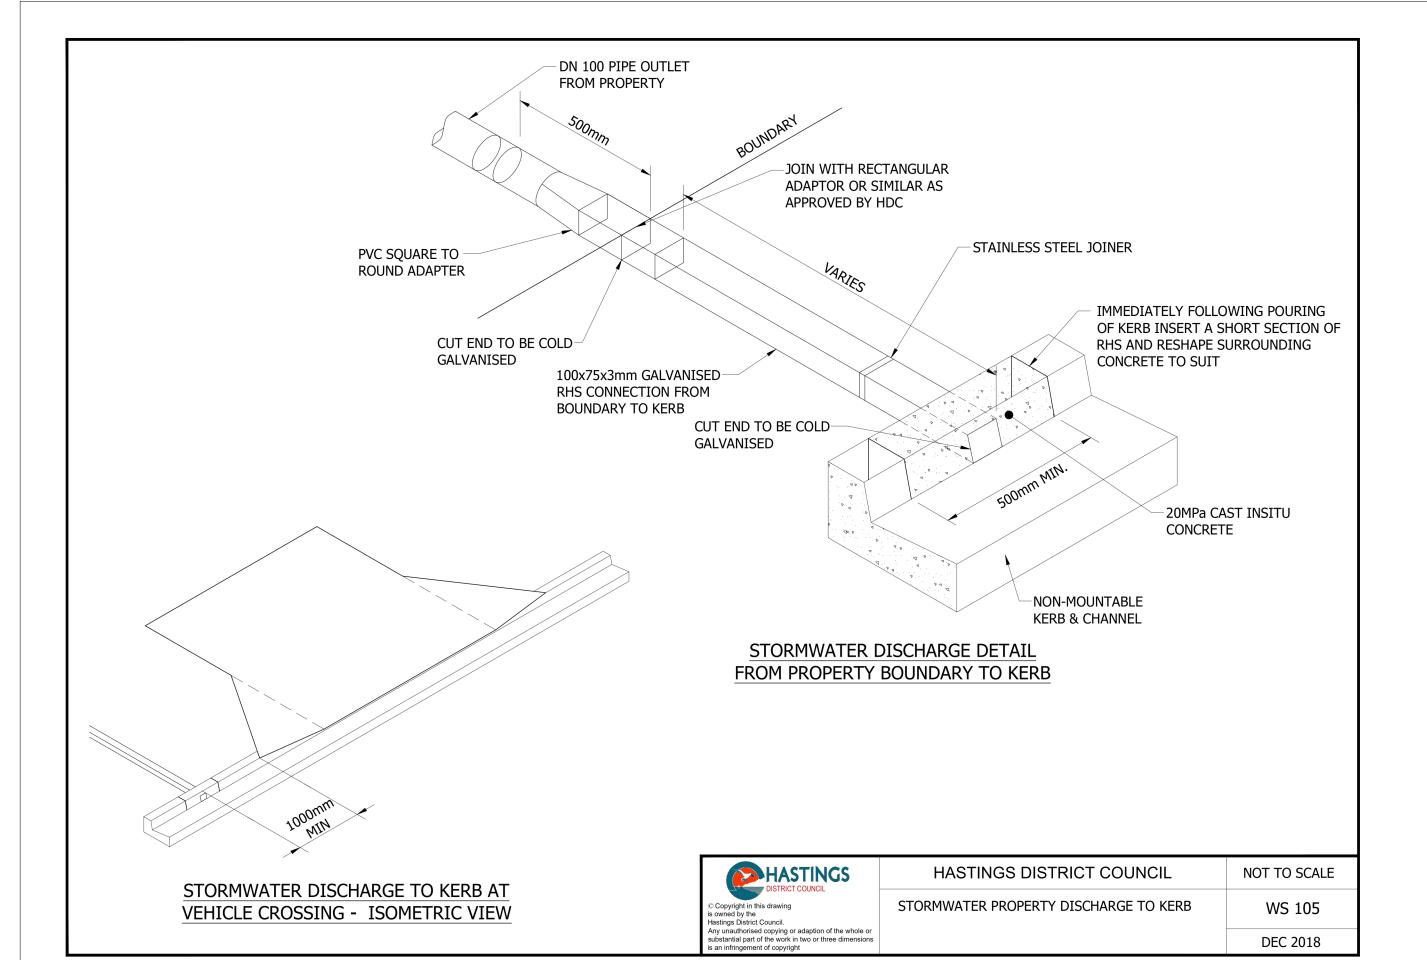

| REVISION DETAILS | | INT | DATE | SURVEYED | WOODS | |
|------------------|---|---------------------|------|-----------|----------|------------|
| | 1 | ISSUED FOR APPROVAL | ТВ | MAY 2025 | DESIGNED | HASTINGSDO |
| | 2 | ISSUED FOR CONSENT | ТВ | JUNE 2025 | DRAWN | ТВ |
| | | | | | CHECKED | BLO |
| | | | | | APPROVED | BF |




BUILDING B, LEVEL 1 8 NUGENT ST, GRAFTON, AUCKLAND 1023 +64 9 308 9229 WOODS.CO.NZ



| ROAD DETAILS | |
|----------------------|--|
| HDC ENG COP - WS 105 | |

| STATUS | ISSUED FOR CONSENT | REV |
|---------|---------------------------|-----|
| SCALE | NOT TO SCALE | 2 |
| COUNCIL | HASTINGS DISTRICT COUNCIL | |
| DWG NO | P24-244-00-2801-RD | |



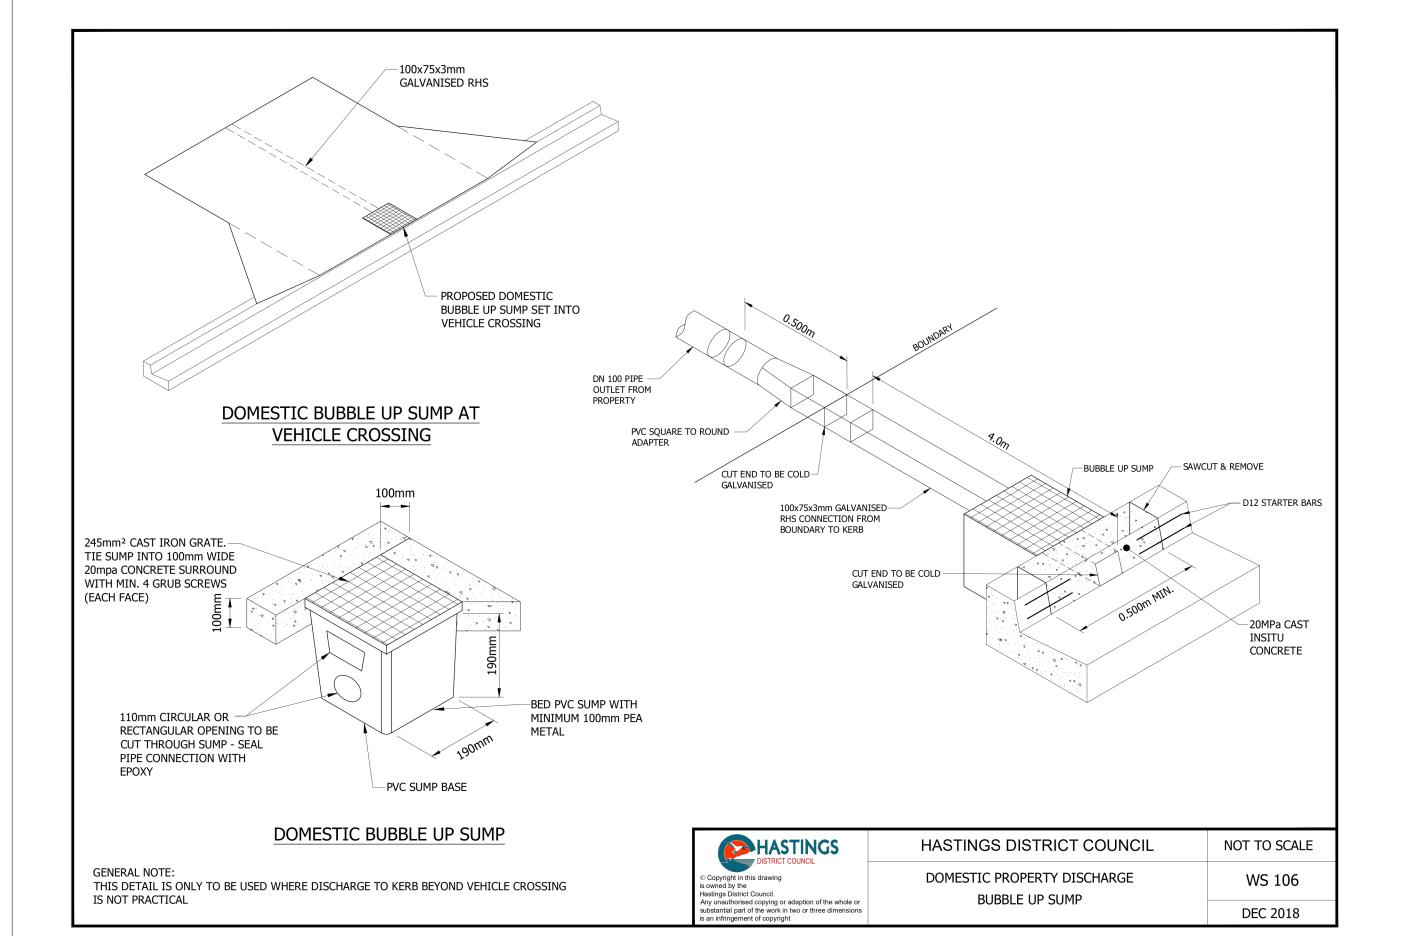

| RE | VISION DETAILS | INT | DATE | SURVEYED | WOODS |
|----|---------------------|-----|-----------|----------|-----------|
| 1 | ISSUED FOR APPROVAL | ТВ | MAY 2025 | DESIGNED | HASTINGSD |
| 2 | ISSUED FOR CONSENT | ТВ | JUNE 2025 | DRAWN | ТВ |
| | | | | CHECKED | BLO |
| | | | | APPROVED | BF |



BUILDING B, LEVEL 1 8 NUGENT ST, GRAFTON, AUCKLAND 1023 +64 9 308 9229 WOODS.CO.NZ





ARATAKI DEVELOPMENT - HAVELOCK NORTH


| ROAD DETAILS | |
|----------------------|--|
| HDC ENG COP - WS 106 | |


| STATUS | ISSUED FOR CONSENT | REV |
|---------|---------------------------|-----|
| SCALE | NOT TO SCALE | 2 |
| COUNCIL | HASTINGS DISTRICT COUNCIL | |
| DWG NO | P24-244-00-2802-RD | |

H 2169002 DRAWINGS\01 ENG\03-24-00-2800-RD ROAD DETAILS DWG

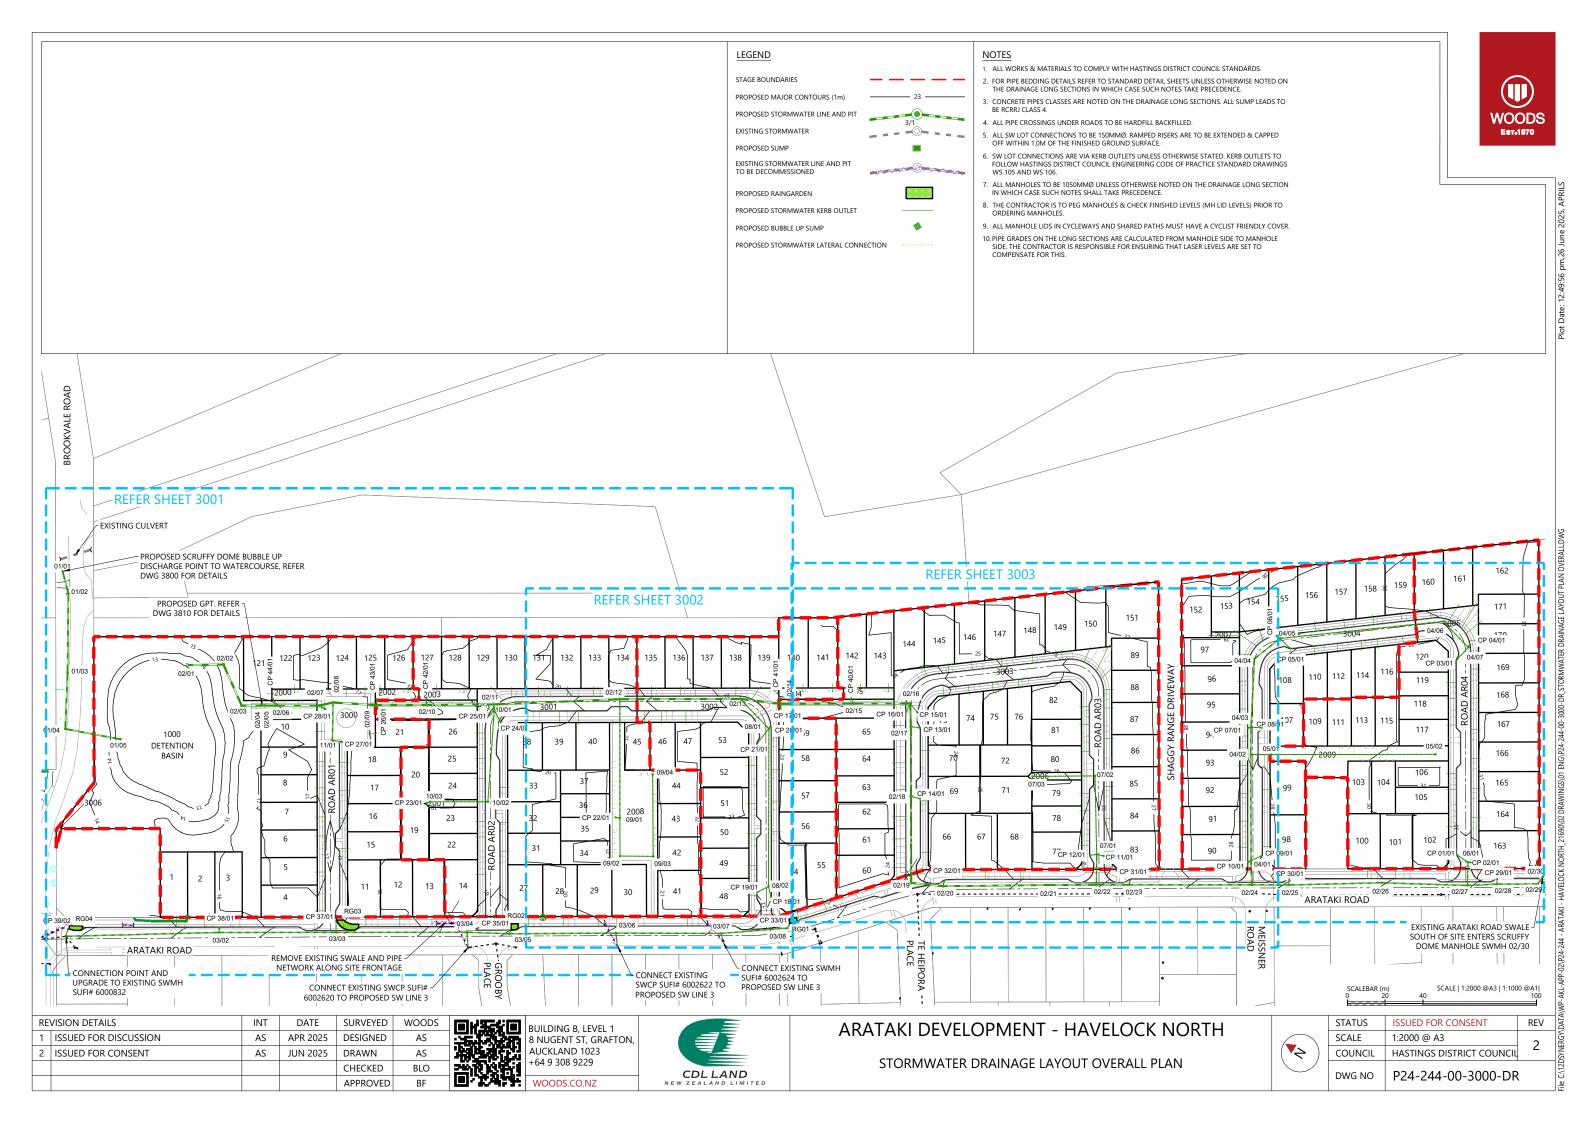

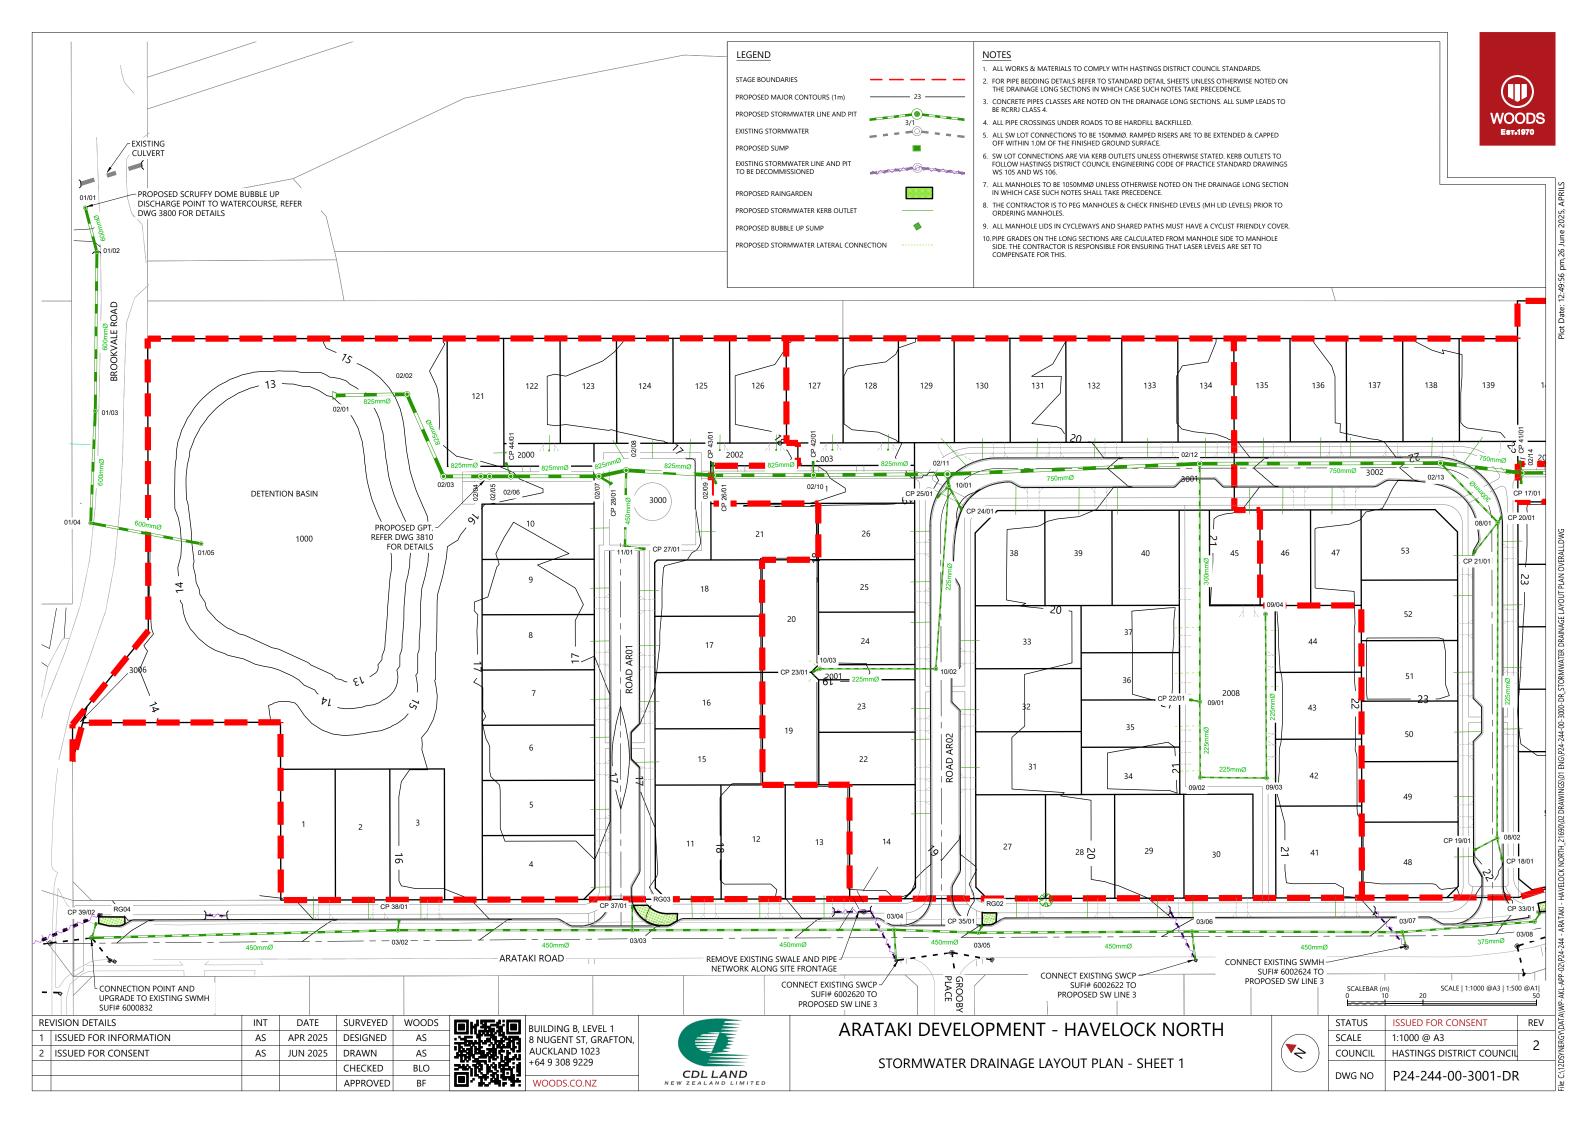

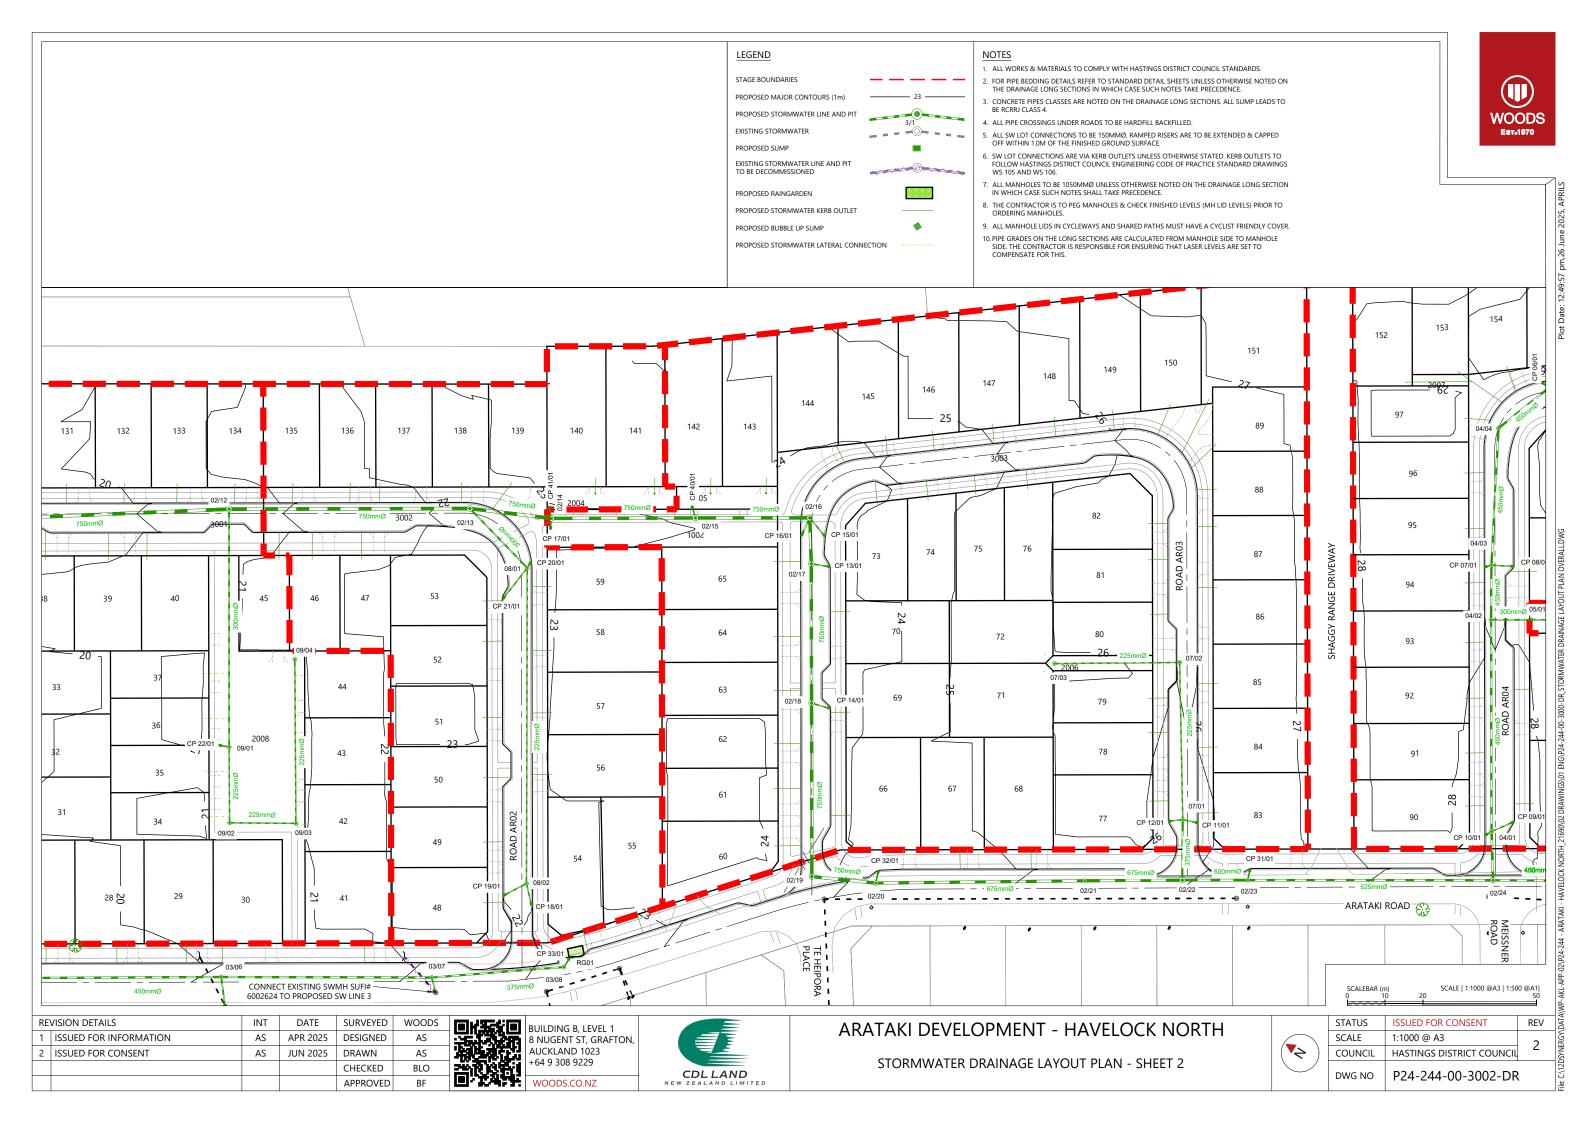

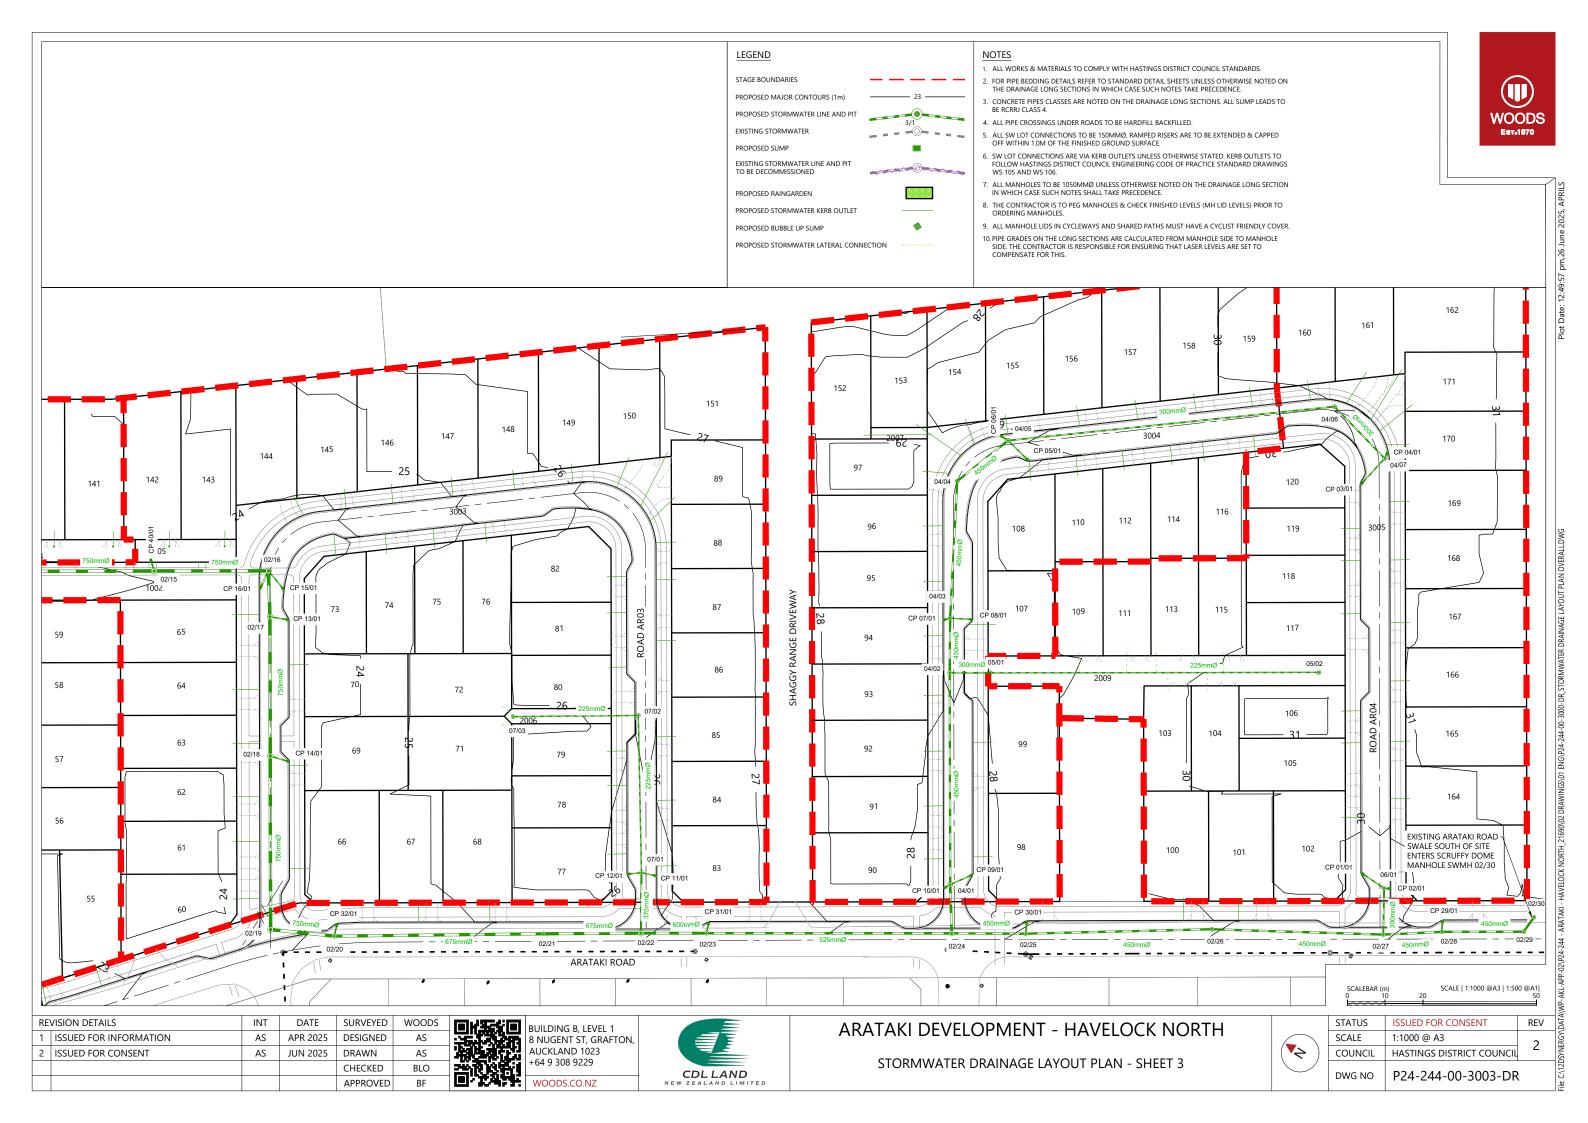

01/01 SDMH 1050)

PIPE DIAMETER

PIPE TYPE

PIPE GRADE

DATUM RL

DEPTH TO INVERT

MANHOLE LID LEVEL

CHAINAGE/ LENGTH

1% AEP STORM

REVISION DETAILS

1 ISSUED FOR DISCUSSION

2 ISSUED FOR CONSENT

HYDRAULIC PARAMETERS

INVERT LEVEL

6000

RCRRJ CLASS

2.00%

O 822 5 l/s

Qcap 868.9 l/s

V 3.49 m/s

12.09

INT

AS

AS

DATE

APR 2025

JUN 2025

SURVEYED

DESIGNED

CHECKED

APPROVED

DRAWN

WOODS

AS

AS

BLO

01

ബര

RCRRJ CLASS 4

2.00%

O 800 0 I/s

V 3.48 m/s

41.95

Qcap 868.7 l/s

SAFE TRENCHING NOTES:

- 1. THIS DIAGRAM SHOWS THE PREFERRED SAFE TRENCHING SOLUTION IN NORMAL GROUND CONDITIONS.
- 2. ALL TRENCH EXCAVATIONS MUST BE ASSESSED BY A 'COMPETENT PERSON' ON SITE IN ACCORDANCE WITH THE WORKSAFE GUIDELINES FOR EXCAVATION SAFETY.
- 3. IF THE PREFERRED TRENCHING SOLUTION IS NOT IMPLEMENTED THE CONTRACTOR MUST PROVIDE RECORDS OF THE SAFE TRENCHING ASSESSMENT COMPLETED BY THE $\underline{\text{'COMPETENT PERSON'}}$.
- 4. TABLES 1 AND 2 OF THE WORKSAFE GUIDELINES SETOUT THE RECOMMENDED COMPETENCIES FOR THE 'COMPETENT PERSON'.
- 5. GROUND CONDITIONS AS DEFINED IN TABLES 1 AND 2 OF THE WORKSAFE GUIDELINES:


NORMAL GROUND CONDITIONS: GENERALLY FLAT OPEN GROUND, WITH LITTLE OR NO SURCHARGE LOADING, FAVOURABLE GROUND CONDITIONS, OFF SET FROM NEARBY STRUCTURES AND SENSITIVE INFRASTRUCTURE. GROUNDWATER CAN BE CONTROLLED WITH SIMPLE METHODS. SUCH AS A SUMP PUMP ARRANGEMENT.

COMPLEX GROUND CONDITIONS:
THE GROUND CONDITIONS INCLUDE VERY WEAK OR SENSITIVE SOILS, GROUNDWATER THAT REQUIRES SPECIALIST
DEWATERING, OR LOCATIONS NEAR STRUCTURES AND SENSITIVE INFRASTRUCTURE. THESE CONDITIONS WOULD RESULT IN
AN ELEVATED RISK WHEN CONSTRUCTING THE EXCAVATION.

STORMWATER NOTES

COMPENSATE FOR THIS.

- 1. ALL WORKS & MATERIALS TO COMPLY WITH HASTINGS DISTRICT COUNCIL STANDARDS.
- FOR PIPE BEDDING DETAILS REFER TO STANDARD DETAIL SHEETS UNLESS OTHERWISE NOTED ON THE DRAINAGE LONG SECTIONS IN WHICH CASE SUCH NOTES TAKE PRECEDENCE.
- 3. CONCRETE PIPES CLASSES ARE NOTED ON THE DRAINAGE LONG SECTIONS. ALL SUMP LEADS TO
- 4. ALL PIPE CROSSINGS UNDER ROADS TO BE HARDFILL BACKFILLED.
- ALL SW LOT CONNECTIONS TO BE 150MMØ. RAMPED RISERS ARE TO BE EXTENDED & CAPPED OFF WITHIN 1.0M OF THE FINISHED GROUND SURFACE.
- FOLLOW HASTINGS DISTRICT COUNCIL ENGINEERING CODE OF PRACTICE STANDARD DRAWINGS WS 105 AND WS 106.
- 7. ALL MANHOLES TO BE 1050MMØ UNLESS OTHERWISE NOTED ON THE DRAINAGE LONG SECTION IN WHICH CASE SUCH NOTES SHALL TAKE PRECEDENCE.
- 8. THE CONTRACTOR IS TO PEG MANHOLES & CHECK FINISHED LEVELS (MH LID LEVELS) PRIOR TO ORDERING MANHOLES.
- 9. ALL MANHOLE LIDS IN CYCLEWAYS AND SHARED PATHS MUST HAVE A CYCLIST FRIENDLY COVER 10. PIPE GRADES ON THE LONG SECTIONS ARE CALCULATED FROM MANHOLE SIDE TO MANHOLE SIDE. THE CONTRACTOR IS RESPONSIBLE FOR ENSURING THAT LASER LEVELS ARE SET TO

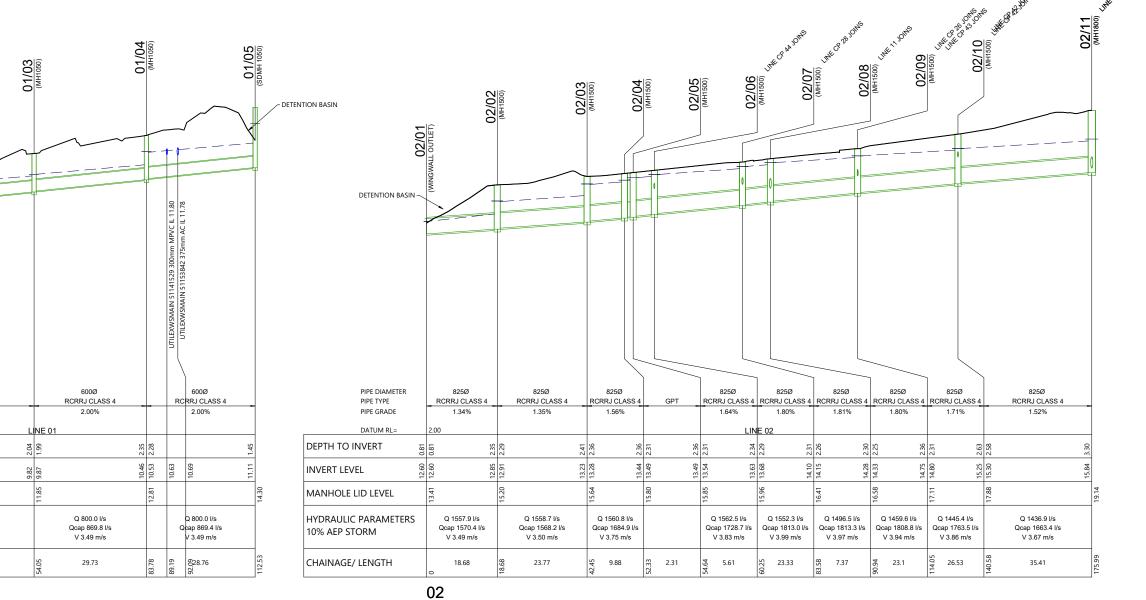

BUILDING B, LEVEL 1 8 NUGENT ST, GRAFTON, **AUCKLAND 1023** +64 9 308 9229 WOODS.CO.NZ



ARATAKI DEVELOPMENT - HAVELOCK NORTH STORMWATER LONGSECTIONS SHEET 1

| 3CALE 1.200 @A3 1.100 | | | | | | | |
|---------------------------|---------|-----------------------|-----|--|--|--|--|
| | STATUS | ISSUED FOR CONSENT | REV | | | | |
| | SCALE | H 1:1000 V 1:200 @ A3 | 2 | | | | |
| | COUNCIL | 2 | | | | | |
| | DWG NO | P24-244-00-3500-DR | • | | | | |

SCALEBAR (m)

HOR. VFRT

WOODS

SCALE | 1:1000 @A3 | 1:500 @A1|

- 1. ALL WORKS & MATERIALS TO COMPLY WITH HASTINGS DISTRICT COUNCIL STANDARDS.
- 2. FOR PIPE BEDDING DETAILS REFER TO STANDARD DETAIL SHEETS UNLESS OTHERWISE NOTED ON THE DRAINAGE LONG SECTIONS IN WHICH CASE SUCH NOTES TAKE PRECEDENCE.
- 3. CONCRETE PIPES CLASSES ARE NOTED ON THE DRAINAGE LONG SECTIONS. ALL SUMP LEADS TO BE RCRU CLASS 4.
- 4. ALL PIPE CROSSINGS UNDER ROADS TO BE HARDFILL BACKFILLED.
- ALL SW LOT CONNECTIONS TO BE 150MMØ. RAMPED RISERS ARE TO BE EXTENDED & CAPPED OFF WITHIN 1.0M OF THE FINISHED GROUND SURFACE.
- SW LOT CONNECTIONS ARE VIA KERB OUTLETS UNLESS OTHERWISE STATED. KERB OUTLETS TO FOLLOW HASTINGS DISTRICT COUNCIL ENGINEERING CODE OF PRACTICE STANDARD DRAWINGS WS 105 AND WS 106.
- 7. ALL MANHOLES TO BE 1050MMØ UNLESS OTHERWISE NOTED ON THE DRAINAGE LONG SECTION IN WHICH CASE SUCH NOTES SHALL TAKE PRECEDENCE.
- 8. THE CONTRACTOR IS TO PEG MANHOLES & CHECK FINISHED LEVELS (MH LID LEVELS) PRIOR TO ORDERING MANHOLES.
- 9. ALL MANHOLE LIDS IN CYCLEWAYS AND SHARED PATHS MUST HAVE A CYCLIST FRIENDLY COVER.
- 10. PIPE GRADES ON THE LONG SECTIONS ARE CALCULATED FR SIDE. THE CONTRACTOR IS RESPONSIBLE FOR ENSURING TH COMPENSATE FOR THIS.



| ON THE LONG SECTIONS ARE CALC NTRACTOR IS RESPONSIBLE FOR EN E FOR THIS. | CULATED FROM MANHOLE SIDE TO MANI NSURING THAT LASER LEVELS ARE SET TO | HOLE | | 02/13 (MH1500) (MH1500) (MH1500) (MH1500) (MH1500) | Control of the Contro | Link of ho John's | 02/16 (MH1500) (MH1500) (MH1500) (MH1500) (MH1500) | gers Junes | 8 60 Per Ca Targe | 12/19 MH1500) 02/20 |
|--|---|--------------------------|-------------------------------|---|--|---|---|-------------------------------|-------------------------------|-------------------------------------|
| | Jule of Other | 02/12 (MH1500) | Life Bardes | 02/13 (MH1500) (MH1500) (MH1500) (MH1500) (MH1500) | V | 02/15 (MH1500) (MH2500) (MH2500) (MH2500) (MH2500) | (MH150 (MH150 | | 02/18 (MH1500) | 02/19 (MH1500) |
| | (WH11800) | 0 | | 0 | | | 0 0 | | • | 12134 |
| | 0 | | | | | | B 148mm IL 20.5 | | | A 148 mm II |
| | | | | | | | | | | |
| DIDE DIAMETER | | | 7707 | 7500 | 750Ø | 7500 | 7500 | 7700 | 7500 | 750Ø |
| PIPE DIAMETER PIPE TYPE | RCR | 750Ø RJ CLASS 4 | 750Ø RCRRJ CLASS 4 | RCRRJ CLASS 4 | RCRRJ CLASS 4 | 750Ø RCRRJ CLASS 4 | RCRRJ CLASS 4 | 750Ø RCRRJ CLASS 4 | RCRRJ CLASS 4 | RCRRJ CLASS 4 |
| PIPE GRADE DATUM RL= | 6.00 | 2.35% | 2.20% | 2.20% | 2.20% | 2.00% | 0.71% | 0.82% | 0.64% | 0.97% |
| | 3.23 | - 19 | | 89 | LINE 02 | 3 8 | 24 | | 20 | 39 22 |
| | 15.92 | 48 3.11 3.06 | | 18.93 330 18.98 3.25 19.46 3.23 | | 20.35 2.78 20.40 2.73 | 21.01 2.37 21.07 2.31 21.08 21.16 2.24 21.21 2.19 | | 21.51 2.07 21.56 2.02 | 85 86 1.95 92 1.89 09 2.11 |
| | 15.1 | 17.48 | | | | | 21.0 | | | 21.85 21.86 21.92 22.09 |
| ANHOLE LID LEVEL | 19.1. | 208 | | 22.24 | | 23.13 | 23.38 | | 23.58 | 23.81 |
| | ٥ | 1211.5 l/s | Q 1158.1 l/s | Q 1075.6 l/s Qcap 1652.1 l/s | Q 1047.9 l/s Qcap 1652.9 l/s | Q 1029.4 l/s Qcap 1575.9 l/s | Q 848.5 l/s Qcap 872.1 l/s | Q 835.8 l/s Qcap 936.6 l/s | Q 815.3 l/s Qcap 831.0 l/s | Q 818.0 l/s Qcap 1098.6 l/s |
| 'DRAULIC PARAMETERS % AEP STORM | Qca | p 1587.6 l/s 4.18 m/s | Qcap 1652.0 l/s V 4.05 m/s | V 3.98 m/s | V 3.96 m/s | V 3.80 m/s | V 2.37 m/s | V 2.53 m/s | V 2.26 m/s | V 2.72 m/s |
| | Qca V | | | | | V 3.80 m/s | | V 2.53 m/s 36.85 | | |

02

| 750Ø RJ CLASS 4 0.64% | | _ | RC | 750Ø CRRJ CLASS 4 0.97% | 4 | | (WP-AKL-APP-02)P24-244 - ARATAKI - HAVELOCK NORTH_21690(02 DRAWINGS)(01 ENG\P24-244-00-3500-DR_STORMWATER LONGSECTIONS.DWG |
|---|--------|-------|--------|---|-------|--------------------------|--|
| | | 1.95 | 1.89 | - | 7.11 | | 00-3500 |
| | 21.85 | 21.86 | 21.92 | | 55.09 | | 24-244- |
| | | | 23.81 | | | 24.19 | 01 ENG\F |
| Q 815.3 l/s ap 831.0 l/s / 2.26 m/s | | | Q | Q 818.0 l/s cap 1098.6 l/s V 2.72 m/s | | | 2 DRAWINGS\ |
| 45.87 | 489.56 | | 491.48 | 16.96 | | 508.44 | _21690\0 |
| | | | | | | | ARATAKI - HAVELOCK NORTH |
| SCALEBAR (m) HOR. 0 10 VERT. 2 | | 20 | | SCALE 1:10 | 100 | 0 @A3 1:500 @A1 50 | 4KL-APP-02\P24-244 - |
| Z Z | | 4 | | SCALE 1:20 | 00 | @A3 1:100 @A1 | /WP-¢ |

| REVISION DETAILS | | | DATE | SURVEYED | WOODS |
|------------------|---|--|----------|----------|-------|
| 1 | 1 ISSUED FOR DISCUSSION 2 ISSUED FOR CONSENT | | APR 2025 | DESIGNED | AS |
| 2 | | | JUN 2025 | DRAWN | AS |
| | | | | CHECKED | BLO |
| | | | | APPROVED | BF |



BUILDING B, LEVEL 1 8 NUGENT ST, GRAFTC AUCKLAND 1023 +64 9 308 9229 WOODS.CO.NZ 8 NUGENT ST, GRAFTON,



| ARATAKI DEVELOPMENT - HAVELOCK NORTH |
|--------------------------------------|
| STORMWATER LONGSECTIONS |
| SHEET 2 |

| | WAI | W | | |
|--|---------|---------------------------|-----|-------------------|
| | STATUS | ISSUED FOR CONSENT | REV | 2DSYNERGY\DATA\WP |
| | SCALE | H 1:1000 V 1:200 @ A3 | 2 | RGY |
| | COUNCIL | HASTINGS DISTRICT COUNCIL | 2 | SYNE |
| | DWG NO | P24-244-00-3501-DR | | e: C:\12E |

- 1. ALL WORKS & MATERIALS TO COMPLY WITH HASTINGS DISTRICT COUNCIL STANDARDS.
- 2. FOR PIPE BEDDING DETAILS REFER TO STANDARD DETAIL SHEETS UNLESS OTHERWISE NOTED ON THE DRAINAGE LONG SECTIONS IN WHICH CASE SUCH NOTES TAKE PRECEDENCE.
- 3. CONCRETE PIPES CLASSES ARE NOTED ON THE DRAINAGE LONG SECTIONS. ALL SUMP LEADS TO BE RCRU CLASS 4.
- 4. ALL PIPE CROSSINGS UNDER ROADS TO BE HARDFILL BACKFILLED.
- ALL SW LOT CONNECTIONS TO BE 150MMØ. RAMPED RISERS ARE TO BE EXTENDED & CAPPED OFF WITHIN 1.0M OF THE FINISHED GROUND SURFACE.
- SW LOT CONNECTIONS ARE VIA KERB OUTLETS UNLESS OTHERWISE STATED. KERB OUTLETS TO FOLLOW HASTINGS DISTRICT COUNCIL ENGINEERING CODE OF PRACTICE STANDARD DRAWINGS WS 105 AND WS 106.
- 7. ALL MANHOLES TO BE 1050MMØ UNLESS OTHERWISE NOTED ON THE DRAINAGE LONG SECTION IN WHICH CASE SUCH NOTES SHALL TAKE PRECEDENCE.
- 8. THE CONTRACTOR IS TO PEG MANHOLES & CHECK FINISHED LEVELS (MH LID LEVELS) PRIOR TO ORDERING MANHOLES.
- 9. ALL MANHOLE LIDS IN CYCLEWAYS AND SHARED PATHS MUST HAVE A CYCLIST FRIENDLY COVER.
- 10. PIPE GRADES ON THE LONG SECTIONS ARE CALCULATED FROM MANHOLE SIDE TO MANHOLE SIDE. THE CONTRACTOR IS RESPONSIBLE FOR ENSURING THAT LASER LEVELS ARE SET TO COMPENSATE FOR THIS.



Plot Date: 2:39:13 pm,17 June 2025, APRILS

| NES ON THE LOWS SECTIONS ARE CALCULAL CONTRACTOR IS RESPONSIBLE FOR ENSURI ATE FOR THIS. | NG THAT LASER LEVELS ARE SET TO | (MH1060) (MH1060) | 02//23 (MH1050) | meta 3 tone | 02/24 (MH1400) (MH1400) (MH1400) (MH1400) (MH1400) (MH1400) | The Constitution of the Co | (WH1050) | (MH1050) (MH1050) (MH1050) (MH1050) (MH1050) | THE CO. | (MH 1050) (MH 1050) (SDMH 1050) |
|--|---|---|---|---|---|--|---|--|---|---|
| PIPE DIAMETER | 675Ø | 675Ø | 600Ø | 525Ø | 450Ø | 4 50Ø | 450 Ø | 450Ø | 450Ø | 450Ø |
| PIPE TYPE PIPE GRADE | RCRRJ CLASS 4 1.00% | RCRRJ CLASS 4 1.00% | 2.33% | RCRRJ CLASS 4 3.00% | RCRRJ CLASS 4 4.51% | RCRRJ CLASS 4 1.78% | RCRRJ CLASS 4 1.10% | RCRRJ CLASS 4 4.30% | RCRRJ CLASS 4 1.96% | RCRRJ CLASS 4 1.67% |
| DATUM RL= | 12.00 | | | | LINE 02 | | | | | |
| DEPTH TO INVERT | 2 | 2.63 | | | 2 2.17 2 2.10 2.10 3 1.57 | 26.1 5.7 | 1.52 | 1.91 | 1.56 | 7 1.54 |
| INVERT LEVEL | | 22.76 | | | 25.52 25.60 25.48 | | | 28.01 | | 29.20 |
| MANHOLE LID LEVEL | 24.19 | 25.40 | 26.32 | | 27.70 | 78.05 | 28.98 | 29.91 | 30.28 | 30.72 |
| HYDRAULIC PARAMETERS 10% AEP STORM | Q 796.4 l/s Qcap 841.1 l/s V 2.67 m/s | Q 800.3 l/s Qcap 841.0 l/s V 2.67 m/s | Q 688.9 l/s Qcap 937.9 l/s V 3.62 m/s | Q 681.9 l/s Qcap 745.2 l/s V 3.90 m/s | Q 319.3 l/s Qcap 605.9 l/s V 3.86 m/s | Q 275.6 Vs Qcap 380.2 Vs V 2.60 m/s | Q 278.5 l/s Qcap 299.5 l/s V 2.14 m/s | Q 218.4 l/s Qcap 591.2 l/s V 3.44 m/s | Q 215.0 l/s Qcap 399.3 l/s V 2.56 m/s | Q 215.2 l/s Qcap 368.8 l/s V 2.41 m/s |
| CHAINAGE/ LENGTH | 80 4 55.38 | 25.7 E99 | 17.33 | 64.93 | 82: 19.61 63: 19.61 | 49.14 60 | £5.43 | 96: 15.48 282 | 4. 21.69 | 823.13 827.79 |
| | 02 | | | | | | | | | |

02

| SCALE | BAR (m) | | SCALE 1:1000 @A3 1:500 @A1 |
|--------|---------|----|-------------------------------------|
| HOR. 0 | 10 | 20 | 50 |
| VERT. | 2 | 4 | 10 SCALE 1:200 @A3 1:100 @A1 |

| RE' | VISION DETAILS | INT | DATE | SURVEYED | WOODS |
|-------------------------|----------------------|-----|----------|----------|-------|
| 1 ISSUED FOR DISCUSSION | | | APR 2025 | DESIGNED | AS |
| 2 | 2 ISSUED FOR CONSENT | | JUN 2025 | DRAWN | AS |
| | | | | CHECKED | BLO |
| | | | | APPROVED | BF |



BUILDING B, LEVEL 1
8 NUGENT ST, GRAFTC
AUCKLAND 1023
+64 9 308 9229

WOODS.CO.NZ 8 NUGENT ST, GRAFTON,



| ARATAKI DEVELOPMENT - HAVELOCK NORTH |
|--------------------------------------|
| STORMWATER LONGSECTIONS |
| SHEET 3 |

| STATUS | ISSUED FOR CONSENT | REV |
|---------|---------------------------|-----|
| SCALE | H 1:1000 V 1:200 @ A3 | 2 |
| COUNCIL | HASTINGS DISTRICT COUNCIL | 2 |
| DWG NO | P24-244-00-3502-DR | |

- 1. ALL WORKS & MATERIALS TO COMPLY WITH HASTINGS DISTRICT COUNCIL STANDARDS.
- 2. FOR PIPE BEDDING DETAILS REFER TO STANDARD DETAIL SHEETS UNLESS OTHERWISE NOTED ON THE DRAINAGE LONG SECTIONS IN WHICH CASE SUCH NOTES TAKE PRECEDENCE.
- 3. CONCRETE PIPES CLASSES ARE NOTED ON THE DRAINAGE LONG SECTIONS. ALL SUMP LEADS TO BE RCRIJ CLASS 4.
- 4. ALL PIPE CROSSINGS UNDER ROADS TO BE HARDFILL BACKFILLED.
- ALL SW LOT CONNECTIONS TO BE 150MMØ. RAMPED RISERS ARE TO BE EXTENDED & CAPPED OFF WITHIN 1.0M OF THE FINISHED GROUND SURFACE.
- SW LOT CONNECTIONS ARE VIA KERB OUTLETS UNLESS OTHERWISE STATED. KERB OUTLETS TO FOLLOW HASTINGS DISTRICT COUNCIL ENGINEERING CODE OF PRACTICE STANDARD DRAWINGS WS 105 AND WS 106.
- 7. ALL MANHOLES TO BE 1050MMØ UNLESS OTHERWISE NOTED ON THE DRAINAGE LONG SECTION IN WHICH CASE SUCH NOTES SHALL TAKE PRECEDENCE.
- 8. THE CONTRACTOR IS TO PEG MANHOLES & CHECK FINISHED LEVELS (MH LID LEVELS) PRIOR TO ORDERING MANHOLES.
- 9. ALL MANHOLE LIDS IN CYCLEWAYS AND SHARED PATHS MUST HAVE A CYCLIST FRIENDLY COVER.
- 10.PIPE GRADES ON THE LONG SECTIONS ARE CALCULATED FROM MANHOLE SIDE TO MANHOLE SIDE. THE CONTRACTOR IS RESPONSIBLE FOR ENSURING THAT LASER LEVELS ARE SET TO COMPENSATE FOR THIS.



| 70,00 | (MH1400) (MH1400) (MH1040) (MH1040) (MH1040) | July of the control o | 04/02 (MH1050) (MH1050) (MH1050) | g grade | 04/04 (MH1050) (MH1050) (MH1200) | | 04/06 (MH1050) | 04/02 (MH1050) (MH1050) (MH1050) (MH1050) |
|--|--|--|---|---|--|---|---|---|
| | A 148mm IL 24.96 | | | | C 148mm IL 26.37 C 148mm IL 26.57 | | P 148mm IL 28.90 | C 148mm IL 25.71 |
| PIPE DIAMETER PIPE TYPE PIPE GRADE DATUM RL= | \$2500 RCRRJ CLASS 4 1.21% 13.00 | 450Ø RCRRJ CLASS 4 1.19% | 450Ø RCRRJ CLASS 4 0.93% | 450Ø RCRRJ CLASS 4 1.12% | 45000 RGRRJ CLASS 4 0.96% LINE 04 LINE 04 LINE 22 22 22 22 22 23 24 25 27 27 27 27 27 27 27 27 27 27 27 27 27 | 300Ø RCRRJ CLASS 4 0.89% | 300Ø RCRRJ CLASS 4 0.56% 172 78 34 172 78 43 172 | 85. 14.00INE 02 80.0000 80.000 80.000 80.00000 |
| | 25.52 | | 26.54 26.54 26.54 26.67 | | 27.13 27.22 27.22 27.35 27.35 | | 28.27 28.32 28.34 28.34 | 26.49 26.64 26.65 26.65 26.70 |
| MANHOLE LID LEVEL | 27.70 | 27.39 | 28.07 | | 28.72 | | 30.18 | 28.07 |
| HYDRAULIC PARAMETERS 10% AEP STORM | Q 374.5 l/s Qcap 472.4 l/s V 2.42 m/s | Q 295.7 l/s Qcap 310.7 l/s V 2.22 m/s | Q 254.7 l/s Qcap 274.9 l/s V 1.96 m/s | Q 197.1 l/s Qcap 302.1 l/s V 2.02 m/s | Q 197.1 l/s Qcap 279.2 l/s V 1.90 m/s | Q 59.3 l/s Qcap 91.3 l/s V 1.37 m/s | Q 59.3 l/s Qcap 72.1 l/s V 1.14 m/s | Q 41.0 l/s Qcap 70.4 l/s V 1.03 m/s |
| CHAINAGE/ LENGTH | 13:02 | 56.04 56.04 | 14.43 69.07 | 36.28 | 77. 123. 66. 12.35 48. 13. 13. 13. 13. 13. 13. 13. 13. 13. 13 | 86.83 | 223.83 227.08 60.61 242.92 | 10.76 0 73 |
| | 04 | | , , | | | | | 05 |

| RE' | VISION DETAILS | INT | DATE | SURVEYED | WOODS |
|-----|-----------------------|-----|----------|----------|-------|
| 1 | ISSUED FOR DISCUSSION | AS | APR 2025 | DESIGNED | AS |
| 2 | ISSUED FOR CONSENT | AS | JUN 2025 | DRAWN | AS |
| | | | | CHECKED | BLO |



APPROVED

BF

BUILDING B, LEVEL 1 8 NUGENT ST, GRAFTO AUCKLAND 1023 +64 9 308 9229 WOODS.CO.NZ 8 NUGENT ST, GRAFTON,



ARATAKI DEVELOPMENT - HAVELOCK NORTH STORMWATER LONGSECTIONS SHEET 4

| STATUS | ISSUED FOR CONSENT | REV |
|---------|---------------------------|-----|
| SCALE | H 1:1000 V 1:200 @ A3 | 2 |
| COUNCIL | HASTINGS DISTRICT COUNCIL | 2 |
| DWG NO | P24-244-00-3503-DR | |

SCALEBAR (m)


HOR. 0

SCALE | 1:1000 @A3 | 1:500 @A1|

SCALE | 1:200 @A3 | 1:100 @A1|

- 1. ALL WORKS & MATERIALS TO COMPLY WITH HASTINGS DISTRICT COUNCIL STANDARDS.
- 2. FOR PIPE BEDDING DETAILS REFER TO STANDARD DETAIL SHEETS UNLESS OTHERWISE NOTED ON THE DRAINAGE LONG SECTIONS IN WHICH CASE SUCH NOTES TAKE PRECEDENCE.
- 3. CONCRETE PIPES CLASSES ARE NOTED ON THE DRAINAGE LONG SECTIONS. ALL SUMP LEADS TO BE RCRU CLASS 4.
- 4. ALL PIPE CROSSINGS UNDER ROADS TO BE HARDFILL BACKFILLED.
- ALL SW LOT CONNECTIONS TO BE 150MMØ. RAMPED RISERS ARE TO BE EXTENDED & CAPPED OFF WITHIN 1.0M OF THE FINISHED GROUND SURFACE.
- 6. SW LOT CONNECTIONS ARE VIA KERB OUTLETS UNLESS OTHERWISE STATED. KERB OUTLETS TO FOLLOW HASTINGS DISTRICT COUNCIL ENGINEERING CODE OF PRACTICE STANDARD DRAWINGS WS 105 AND WS 106.
- 7. ALL MANHOLES TO BE 1050MMØ UNLESS OTHERWISE NOTED ON THE DRAINAGE LONG SECTION IN WHICH CASE SUCH NOTES SHALL TAKE PRECEDENCE.
- 8. THE CONTRACTOR IS TO PEG MANHOLES & CHECK FINISHED LEVELS (MH LID LEVELS) PRIOR TO ORDERING MANHOLES.
- 9. ALL MANHOLE LIDS IN CYCLEWAYS AND SHARED PATHS MUST HAVE A CYCLIST FRIENDLY COVER.
- 10. PIPE GRADES ON THE LONG SECTIONS ARE CALCULATED FROM MANHOLE SIDE TO MANHOLE SIDE. THE CONTRACTOR IS RESPONSIBLE FOR ENSURING THAT LASER LEVELS ARE SET TO COMPENSATE FOR THIS.



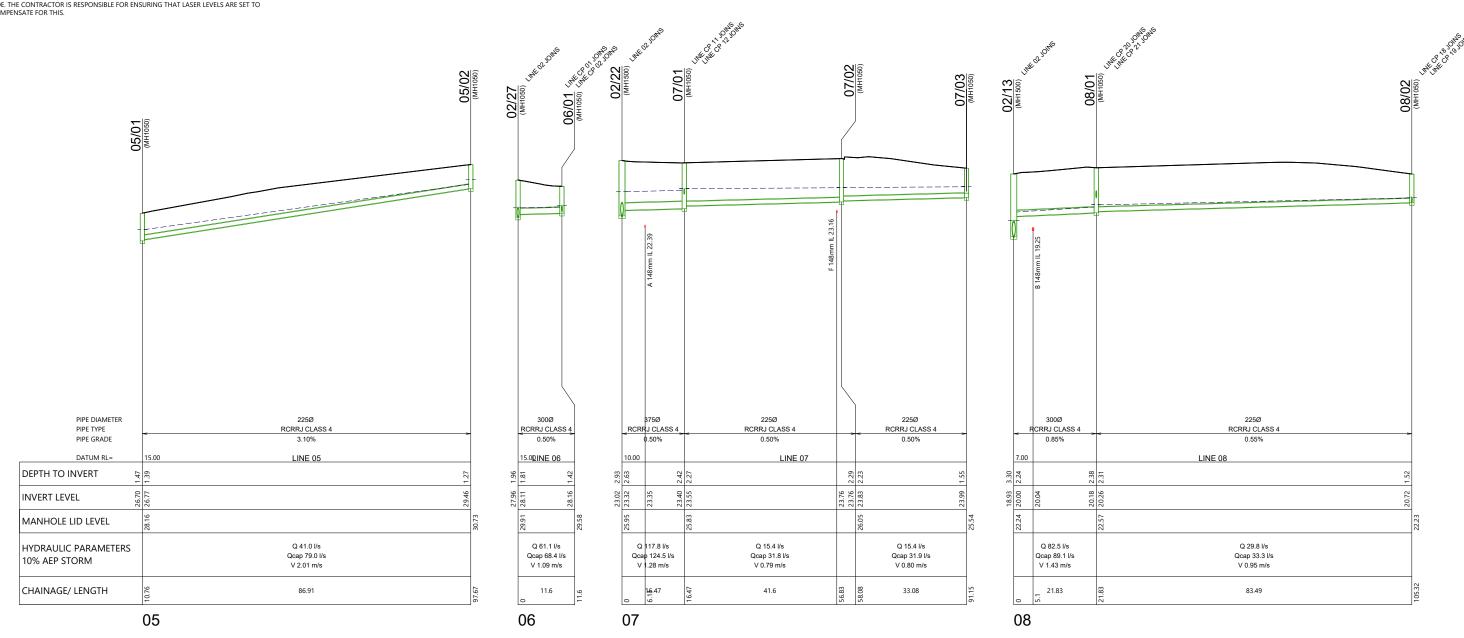

| REVISION DETAILS | | INT | DATE | SURVEYED | WOODS |
|------------------|-----------------------|-----|----------|----------|-------|
| 1 | ISSUED FOR DISCUSSION | AS | APR 2025 | DESIGNED | AS |
| 2 | ISSUED FOR CONSENT | AS | JUN 2025 | DRAWN | AS |
| | | | | CHECKED | BLO |



APPROVED

BF

BUILDING B, LEVEL 1 8 NUGENT ST, GRAFTON, AUCKLAND 1023 +64 9 308 9229 WOODS.CO.NZ



| ARATAKI DEVELOPMENT - HAVELOCK NORTH |
|--------------------------------------|
| STORMWATER LONGSECTIONS |
| SHEET 5 |

| STATUS | ISSUED FOR CONSENT | REV |
|---------|---------------------------|-----|
| SCALE | H 1:1000 V 1:200 @ A3 | 2 |
| COUNCIL | HASTINGS DISTRICT COUNCIL | 2 |
| DWG NO | P24-244-00-3504-DR | |


SCALE | 1:1000 @A3 | 1:500 @A1|

SCALE | 1:200 @A3 | 1:100 @A1

SCALEBAR (m) 10

HOR. (VERT

- 1. ALL WORKS & MATERIALS TO COMPLY WITH HASTINGS DISTRICT COUNCIL STANDARDS.
- 2. FOR PIPE BEDDING DETAILS REFER TO STANDARD DETAIL SHEETS UNLESS OTHERWISE NOTED ON THE DRAINAGE LONG SECTIONS IN WHICH CASE SUCH NOTES TAKE PRECEDENCE.
- 3. CONCRETE PIPES CLASSES ARE NOTED ON THE DRAINAGE LONG SECTIONS. ALL SUMP LEADS TO BE RCRU CLASS 4.
- 4. ALL PIPE CROSSINGS UNDER ROADS TO BE HARDFILL BACKFILLED.
- 5. ALL SW LOT CONNECTIONS TO BE 150MMØ, RAMPED RISERS ARE TO BE EXTENDED & CAPPED OFF WITHIN 1.0M OF THE FINISHED GROUND SURFACE.
- 6. SW LOT CONNECTIONS ARE VIA KERB OUTLETS UNLESS OTHERWISE STATED. KERB OUTLETS TO FOLLOW HASTINGS DISTRICT COUNCIL ENGINEERING CODE OF PRACTICE STANDARD DRAWINGS WS 105 AND WS 106.
- 7. ALL MANHOLES TO BE 1050MMØ UNLESS OTHERWISE NOTED ON THE DRAINAGE LONG SECTION IN WHICH CASE SUCH NOTES SHALL TAKE PRECEDENCE.
- 8. THE CONTRACTOR IS TO PEG MANHOLES & CHECK FINISHED LEVELS (MH LID LEVELS) PRIOR TO ORDERING MANHOLES.
- 9. ALL MANHOLE LIDS IN CYCLEWAYS AND SHARED PATHS MUST HAVE A CYCLIST FRIENDLY COVER.
- 10. PIPE GRADES ON THE LONG SECTIONS ARE CALCULATED FROM MANHOLE SIDE TO MANHOLE SIDE. THE CONTRACTOR IS RESPONSIBLE FOR ENSURING THAT LASER LEVELS ARE SET TO COMPENSATE FOR THIS.

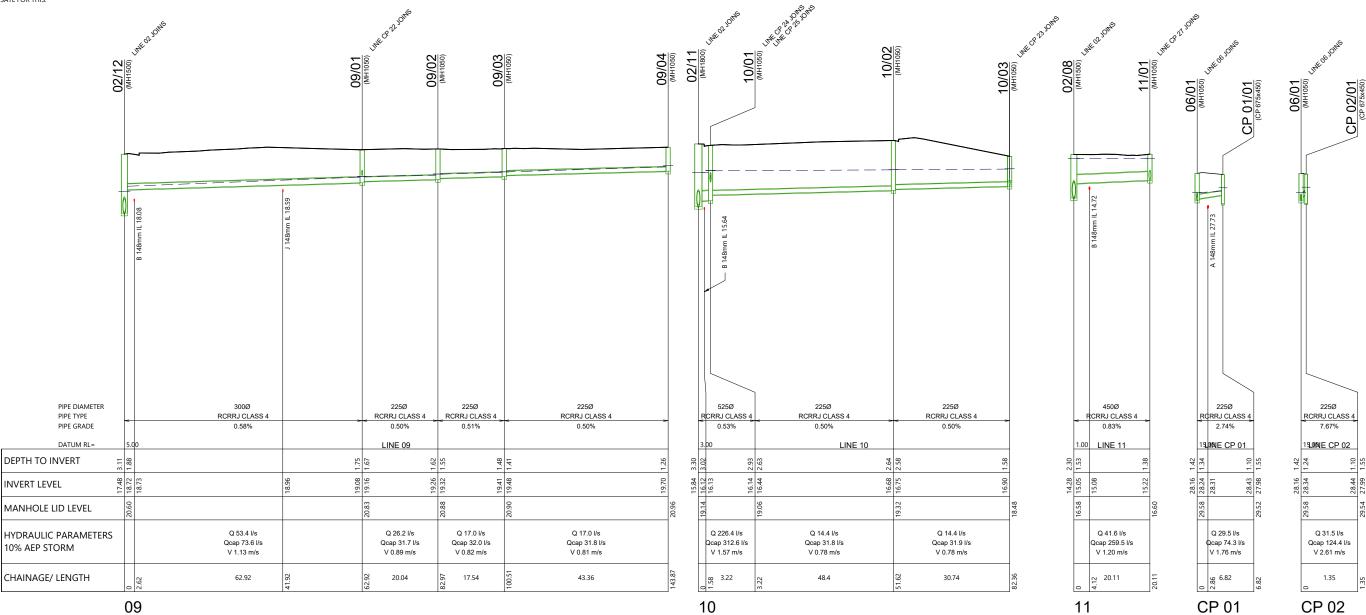

| l | | | | | | | |
|-----|-----------------------|----|----------|----------|-------|--|--|
| RE' | REVISION DETAILS | | DATE | SURVEYED | WOODS | | |
| 1 | ISSUED FOR DISCUSSION | AS | APR 2025 | DESIGNED | AS | | |
| 2 | ISSUED FOR CONSENT | AS | JUN 2025 | DRAWN | AS | | |
| | | | | CHECKED | BLO | | |



APPROVED

BF

BUILDING B, LEVEL 1 8 NUGENT ST, GRAFTON, AUCKLAND 1023 +64 9 308 9229 WOODS.CO.NZ



| ARATAKI DEVELOPMENT - HAVELOCK NO |)RTH |
|------------------------------------|------|
| STORMWATER LONGSECTIONS SHEFT 6 | |
| SHEET 0 | |

| | SCALE 1:200 @A3 1:100 @A1 | | | | |
|-----------------------------|-------------------------------|---------------------------|-----|--|--|
| | STATUS | ISSUED FOR CONSENT | REV | | |
| SCALE H 1:1000 V 1:200 @ A3 | | 2 | | | |
| | COUNCIL | HASTINGS DISTRICT COUNCIL | 2 | | |
| | DWG NO | NO P24-244-00-3505-DR | | | |


SCALE | 1:1000 @A3 | 1:500 @A1|

SCALEBAR (m)

HOR. (VFRT

WOODS

- 1. ALL WORKS & MATERIALS TO COMPLY WITH HASTINGS DISTRICT COUNCIL STANDARDS.
- 2. FOR PIPE BEDDING DETAILS REFER TO STANDARD DETAIL SHEETS UNLESS OTHERWISE NOTED ON THE DRAINAGE LONG SECTIONS IN WHICH CASE SUCH NOTES TAKE PRECEDENCE.
- 3. CONCRETE PIPES CLASSES ARE NOTED ON THE DRAINAGE LONG SECTIONS. ALL SUMP LEADS TO
- 4. ALL PIPE CROSSINGS UNDER ROADS TO BE HARDFILL BACKFILLED.
- ALL SW LOT CONNECTIONS TO BE 150MMØ. RAMPED RISERS ARE TO BE EXTENDED & CAPPED OFF WITHIN 1.0M OF THE FINISHED GROUND SURFACE.
- 6. SW LOT CONNECTIONS ARE VIA KERB OUTLETS UNLESS OTHERWISE STATED. KERB OUTLETS TO FOLLOW HASTINGS DISTRICT COUNCIL ENGINEERING CODE OF PRACTICE STANDARD DRAWINGS WS 105 AND WS 106.
- 7. ALL MANHOLES TO BE 1050MMØ UNLESS OTHERWISE NOTED ON THE DRAINAGE LONG SECTION IN WHICH CASE SUCH NOTES SHALL TAKE PRECEDENCE.
- 8. THE CONTRACTOR IS TO PEG MANHOLES & CHECK FINISHED LEVELS (MH LID LEVELS) PRIOR TO ORDERING MANHOLES.
- 9. ALL MANHOLE LIDS IN CYCLEWAYS AND SHARED PATHS MUST HAVE A CYCLIST FRIENDLY COVER.
- 10. PIPE GRADES ON THE LONG SECTIONS ARE CALCULATED FROM MANHOLE SIDE TO MANHOLE SIDE. THE CONTRACTOR IS RESPONSIBLE FOR ENSURING THAT LASER LEVELS ARE SET TO COMPENSATE FOR THIS.

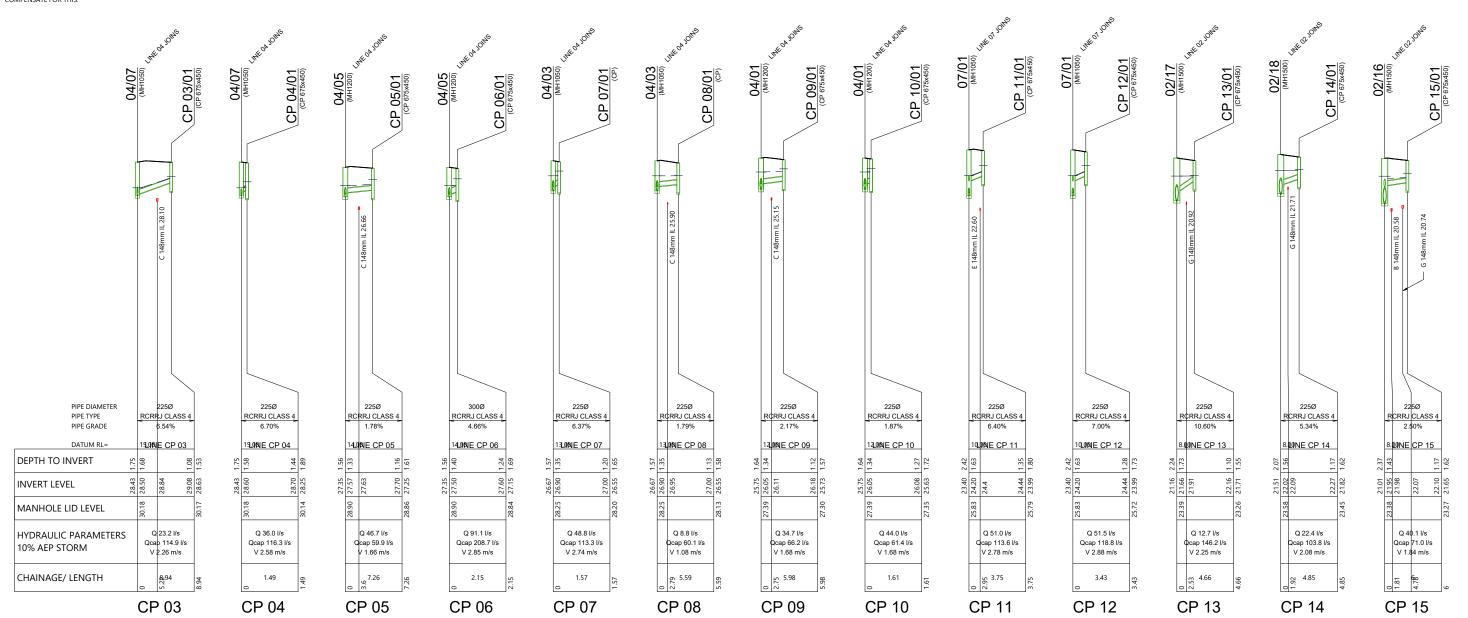

| l | | | | | |
|-----|-----------------------|-----|----------|----------|-------|
| RE' | VISION DETAILS | INT | DATE | SURVEYED | WOODS |
| 1 | ISSUED FOR DISCUSSION | AS | APR 2025 | DESIGNED | AS |
| 2 | ISSUED FOR CONSENT | AS | JUN 2025 | DRAWN | AS |
| | | | | CHECKED | BLO |
| | | | | APPROVED | RF |



BUILDING B, LEVEL 1 8 NUGENT ST, GRAFTON, AUCKLAND 1023 +64 9 308 9229



| ARATAKI DEVELOPMENT - HAVELOCK NORTH |
|--------------------------------------|
| STORMWATER LONGSECTIONS |
| SHEET 7 |

| SCALE 1:200 @A3 1:100 @A1 | | | | | |
|-------------------------------|---------------------------|-----|---------------|--|--|
| STATUS | ISSUED FOR CONSENT | REV | DATA | | |
| SCALE | H 1:1000 V 1:200 @ A3 | 2 | 2DSYNERGY/DAT | | |
| COUNCIL | HASTINGS DISTRICT COUNCIL | | SYNE | | |
| DWG NO | P24-244-00-3506-DR | | le: C:\12E | | |


SCALE | 1:1000 @A3 | 1:500 @A1|

SCALEBAR (m)

HOR. VERT. WOODS Est.1970

ER LONGSECTIONS.DWG Plot Date: 2:39:51 pm,17 Jun

- 1. ALL WORKS & MATERIALS TO COMPLY WITH HASTINGS DISTRICT COUNCIL STANDARDS.
- 2. FOR PIPE BEDDING DETAILS REFER TO STANDARD DETAIL SHEETS UNLESS OTHERWISE NOTED ON THE DRAINAGE LONG SECTIONS IN WHICH CASE SUCH NOTES TAKE PRECEDENCE.
- 3. CONCRETE PIPES CLASSES ARE NOTED ON THE DRAINAGE LONG SECTIONS. ALL SUMP LEADS TO
- 4. ALL PIPE CROSSINGS UNDER ROADS TO BE HARDFILL BACKFILLED.
- ALL SW LOT CONNECTIONS TO BE 150MMØ. RAMPED RISERS ARE TO BE EXTENDED & CAPPED OFF WITHIN 1.0M OF THE FINISHED GROUND SURFACE.
- 6. SW LOT CONNECTIONS ARE VIA KERB OUTLETS UNLESS OTHERWISE STATED. KERB OUTLETS TO FOLLOW HASTINGS DISTRICT COUNCIL ENGINEERING CODE OF PRACTICE STANDARD DRAWINGS WS 105 AND WS 106.
- ALL MANHOLES TO BE 1050MMØ UNLESS OTHERWISE NOTED ON THE DRAINAGE LONG SECTION IN WHICH CASE SUCH NOTES SHALL TAKE PRECEDENCE.
- 8. THE CONTRACTOR IS TO PEG MANHOLES & CHECK FINISHED LEVELS (MH LID LEVELS) PRIOR TO ORDERING MANHOLES.
- 9. ALL MANHOLE LIDS IN CYCLEWAYS AND SHARED PATHS MUST HAVE A CYCLIST FRIENDLY COVER.
- 10. PIPE GRADES ON THE LONG SECTIONS ARE CALCULATED FROM MANHOLE SIDE TO MANHOLE SIDE. THE CONTRACTOR IS RESPONSIBLE FOR ENSURING THAT LASER LEVELS ARE SET TO COMPENSATE FOR THIS.

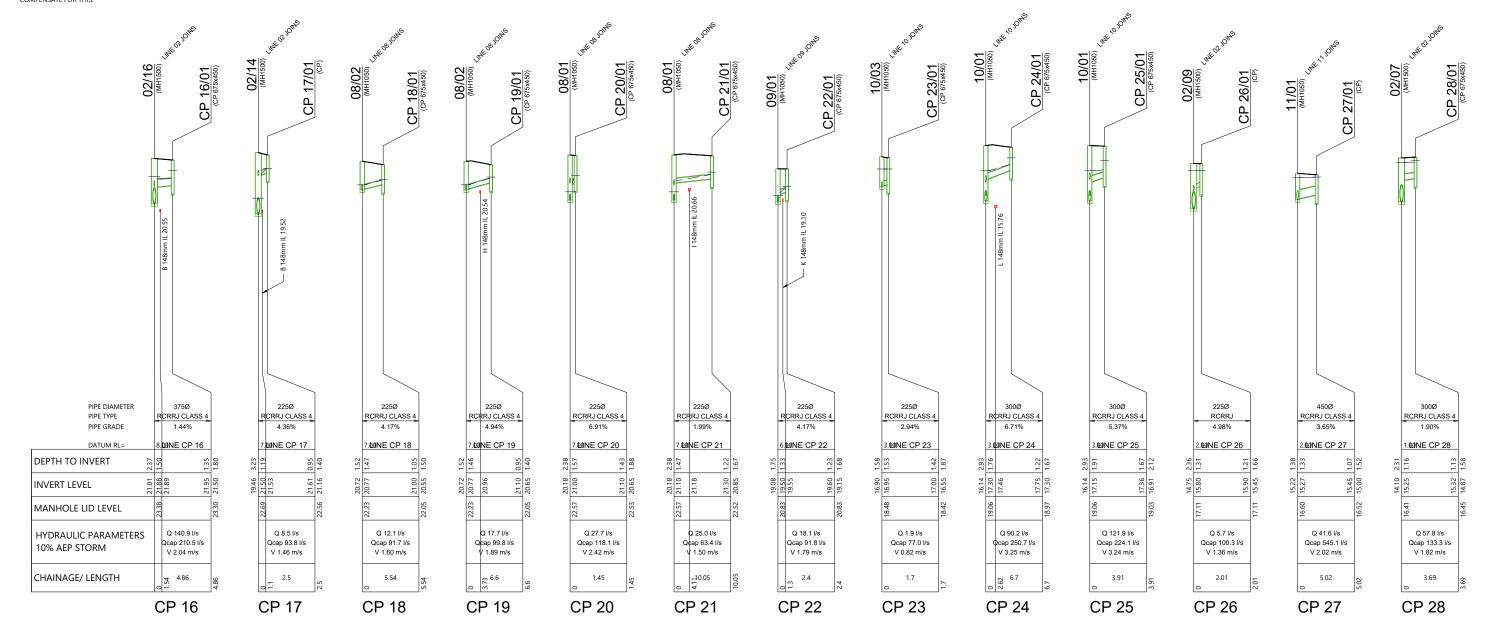

| REVISION DETAILS | | INT | DATE | SURVEYED | WOODS |
|------------------|-----------------------|-----|----------|----------|-------|
| 1 | ISSUED FOR DISCUSSION | AS | APR 2025 | DESIGNED | AS |
| 2 | ISSUED FOR CONSENT | AS | JUN 2025 | DRAWN | AS |
| | | | | CHECKED | BLO |
| | | | | APPROVED | BF |



BUILDING B, LEVEL 1 8 NUGENT ST, GRAFTON, AUCKLAND 1023 +64 9 308 9229 WOODS.CO.NZ



| ARATAKI DEVELOPMENT - HAVELOCK NORTH |
|--------------------------------------|
| STORMWATER LONGSECTIONS |
| SHEET 8 |

| | 3CAEE 1.200 @A3 1.100 | @AII | 1/// |
|---------|---------------------------|------|--------------------------|
| STATUS | ISSUED FOR CONSENT | REV | TANA TANA TANA TANA TANA |
| SCALE | H 1:1000 V 1:200 @ A3 | 2 | 2 |
| COUNCIL | HASTINGS DISTRICT COUNCIL | 2 | 1 |
| DWG NO | P24-244-00-3507-DR | | - C117 |

SCALE | 1:1000 @A3 | 1:500 @A1|


SCALE | 1:200 @A3 | 1:100 @A1

SCALEBAR (m)

HOR. VERT. WOODS EST.1970

- 1. ALL WORKS & MATERIALS TO COMPLY WITH HASTINGS DISTRICT COUNCIL STANDARDS.
- 2. FOR PIPE BEDDING DETAILS REFER TO STANDARD DETAIL SHEETS UNLESS OTHERWISE NOTED ON THE DRAINAGE LONG SECTIONS IN WHICH CASE SUCH NOTES TAKE PRECEDENCE.
- 3. CONCRETE PIPES CLASSES ARE NOTED ON THE DRAINAGE LONG SECTIONS. ALL SUMP LEADS TO BE RCRRJ CLASS 4.
- 4. ALL PIPE CROSSINGS UNDER ROADS TO BE HARDFILL BACKFILLED.
- ALL SW LOT CONNECTIONS TO BE 150MMØ. RAMPED RISERS ARE TO BE EXTENDED & CAPPED OFF WITHIN 1.0M OF THE FINISHED GROUND SURFACE.
- 6. SW LOT CONNECTIONS ARE VIA KERB OUTLETS UNLESS OTHERWISE STATED. KERB OUTLETS TO FOLLOW HASTINGS DISTRICT COUNCIL ENGINEERING CODE OF PRACTICE STANDARD DRAWINGS WS 105 AND WS 106.
- 7. ALL MANHOLES TO BE 1050MMØ UNLESS OTHERWISE NOTED ON THE DRAINAGE LONG SECTION IN WHICH CASE SUCH NOTES SHALL TAKE PRECEDENCE.
- 8. THE CONTRACTOR IS TO PEG MANHOLES & CHECK FINISHED LEVELS (MH LID LEVELS) PRIOR TO ORDERING MANHOLES.
- 9. ALL MANHOLE LIDS IN CYCLEWAYS AND SHARED PATHS MUST HAVE A CYCLIST FRIENDLY COVER.
- 10. PIPE GRADES ON THE LONG SECTIONS ARE CALCULATED FROM MANHOLE SIDE TO MANHOLE SIDE. THE CONTRACTOR IS RESPONSIBLE FOR ENSURING THAT LASER LEVELS ARE SET TO COMPENSATE FOR THIS.



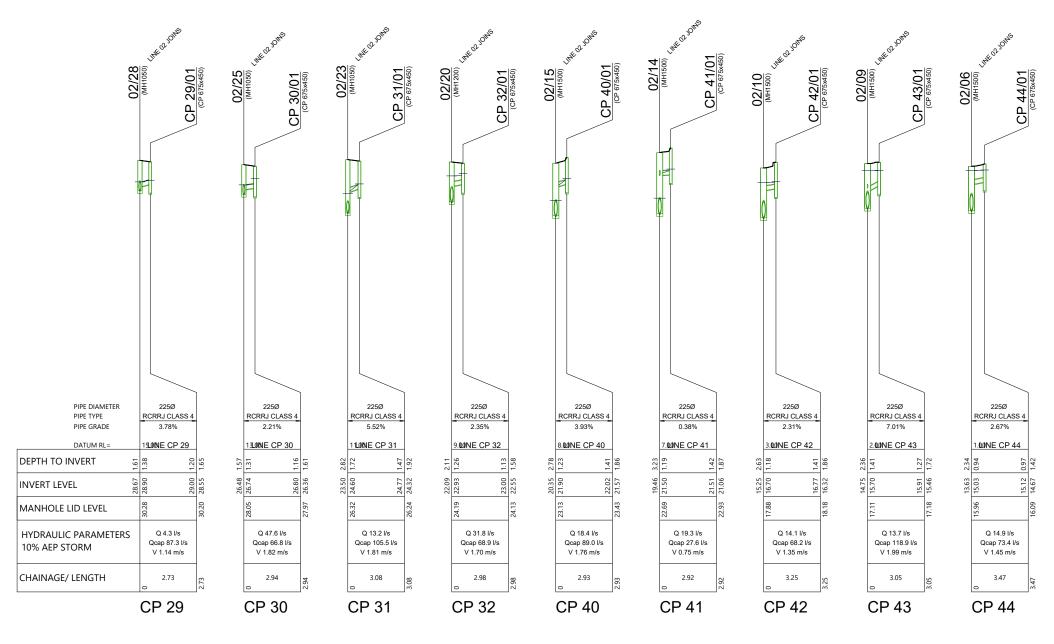

| SCAL | EBAR (m) | | SCALE 1:1000 @A3 1:500 @A1 |
|--------|----------|----|-------------------------------------|
| HOR. 0 | 10 | 20 | 50 |
| VERT. | 2 | 4 | 10 SCALE 1:200 @A3 1:100 @A1 |

| _ | | T | | | |
|----|-----------------------|-----|----------|----------|-------|
| RE | VISION DETAILS | INT | DATE | SURVEYED | WOODS |
| 1 | ISSUED FOR DISCUSSION | AS | APR 2025 | DESIGNED | AS |
| 2 | ISSUED FOR CONSENT | AS | JUN 2025 | DRAWN | AS |
| | | | | CHECKED | BLO |
| | | | | APPROVED | BF |





| ARATAKI DEVELOPMENT - HAVELOCK NORTH |
|--------------------------------------|
| STORMWATER LONGSECTIONS |
| SHEET 9 |

| STATUS | ISSUED FOR CONSENT | REV |
|---------|---------------------------|-----|
| SCALE | H 1:1000 V 1:200 @ A3 | 2 |
| COUNCIL | HASTINGS DISTRICT COUNCIL | |
| DWG NO | P24-244-00-3508-DR | |

- 1. ALL WORKS & MATERIALS TO COMPLY WITH HASTINGS DISTRICT COUNCIL STANDARDS.
- 2. FOR PIPE BEDDING DETAILS REFER TO STANDARD DETAIL SHEETS UNLESS OTHERWISE NOTED ON THE DRAINAGE LONG SECTIONS IN WHICH CASE SUCH NOTES TAKE PRECEDENCE.
- 3. CONCRETE PIPES CLASSES ARE NOTED ON THE DRAINAGE LONG SECTIONS. ALL SUMP LEADS TO BE RCRU CLASS 4.
- 4. ALL PIPE CROSSINGS UNDER ROADS TO BE HARDFILL BACKFILLED.
- ALL SW LOT CONNECTIONS TO BE 150MMØ. RAMPED RISERS ARE TO BE EXTENDED & CAPPED OFF WITHIN 1.0M OF THE FINISHED GROUND SURFACE.
- SW LOT CONNECTIONS ARE VIA KERB OUTLETS UNLESS OTHERWISE STATED. KERB OUTLETS TO FOLLOW HASTINGS DISTRICT COUNCIL ENGINEERING CODE OF PRACTICE STANDARD DRAWINGS WS 105 AND WS 106.
- 7. ALL MANHOLES TO BE 1050MMØ UNLESS OTHERWISE NOTED ON THE DRAINAGE LONG SECTION IN WHICH CASE SUCH NOTES SHALL TAKE PRECEDENCE.
- 8. THE CONTRACTOR IS TO PEG MANHOLES & CHECK FINISHED LEVELS (MH LID LEVELS) PRIOR TO ORDERING MANHOLES.
- 9. ALL MANHOLE LIDS IN CYCLEWAYS AND SHARED PATHS MUST HAVE A CYCLIST FRIENDLY COVER.
- 10. PIPE GRADES ON THE LONG SECTIONS ARE CALCULATED FROM MANHOLE SIDE TO MANHOLE SIDE. THE CONTRACTOR IS RESPONSIBLE FOR ENSURING THAT LASER LEVELS ARE SET TO



| EXISTING SWMH SUFI# 6000832 | A 148mm IL 12.46 A 148mm IL 12.46 | 23/02 (MH1060) (MH106 | COXOO (WH1050) (WH105 | 03/05 (MH1050) (MH1050) (MH1050) | 03/06 (MH1050) | Little Co. A. Daniel. |
|---|---|---|--|--|---|--------------------------------|
| PIPE DIAMETER PIPE TYPE PIPE GRADE | 450Ø RCRRJ CLASS 4 1.88% | 450Ø RCRRJ CLASS 4 1.97% | 450Ø RCRRJ CLASS 4 2.14% | 450Ø RCRRJ CLASS 4 2.00% | 450Ø RCRRJ CLASS 4 2.00% | 450Ø RCRRJ CLASS 4 2.05% |
| | 00 | 7.7 | LINE 03 | 2,5 | 9.5 | |
| DEPTH TO INVERT 59 21 42 92 1 | | 14.17 1.27 | 15.70 1.50 | 16.95 1.61 16.95 1.61 17.54 1.62 17.59 1.57 | 1828 150 1863 145 | |
| 3.88 State of the | | 14 14 14 14 14 14 14 14 14 14 14 14 14 1 | 7.20 15 | 16 8.57 16 71 71 9.16 | 008 | 19 |
| VIAIVIOLE LID LEVEL IN | | | - | | 0.440.01/ | Q 50.1 Vs |
| HYDRAULIC PARAMETERS 20% AEP STORM | Q 353.2 l/s Qcap 391.1 l/s V 2.78 m/s | Q 309.2 l/s Qcap 400.6 l/s V 2.78 m/s | Q 258.5 l/s Qcap 417.0 l/s V 2.76 m/s | Q 177.0 l/s Qcap 403.6 l/s V 2.45 m/s | Q 116.0 l/s Qcap 403.8 l/s V 2.19 m/s | Qcap 408.6 l/s V 1.74 m/s |

| 450Ø RCRRJ CLASS 4 2.05% | | A CYCHANATH I ONCTOTANE DUIN | (WP-AKL-APP-02/P24-244 - ARATAKI - HAVELOCK NOKIH, 21690/02 DRAWINGS/01 ENG/P24-244-00-3500-DR, STORMWATER LONGSECTIONS.DWG |
|--|--------------------|---|---|
| | 1.40 | 0000 | -00-3500-I |
| | 19.77 | 200 | /P24-244- |
| | | 21.18 | (01 ENG |
| Q 50.1 l/s Qcap 408.6 l/s V 1.74 m/s | | S A S A S A S A S A S A S A S A S A S A | JZ DRAWINGS |
| 55.75 | | 346.68 | /UE3169U/ |
| | | ECIVAL DELIVER - | I - HAVELOCK NOKI |
| | | i i | - AKA I Ak |
| SCALEBAR (m) HOR: 0 10 20 | SCALE 1:1000 @A3 | 1:500 @A1 50 | APP-02\P24-244 |
| VERT. 2 4 | SCALE 1:200 @A3 | 10 1:100 @A1 | \WP-AKL-, |

| REVISION DETAILS | | INT | DATE | SURVEYED | WOODS |
|------------------|-----------------------|-----|----------|----------|-------|
| 1 | ISSUED FOR DISCUSSION | AS | APR 2025 | DESIGNED | AS |
| 2 | ISSUED FOR CONSENT | AS | JUN 2025 | DRAWN | AS |
| | | | | CHECKED | BLO |
| | | | | APPROVED | BF |






| ARATAKI DEVELOPMENT - HAVELOCK NORTH |
|--------------------------------------|
| STORMWATER LONGSECTIONS |
| SHEET 10 |

| | | | | . 7 |
|--------------------------|---------|---------------------------|-----|---------|
| | STATUS | ISSUED FOR CONSENT | REV | \DAT/ |
| | SCALE | H 1:1000 V 1:200 @ A3 | 2 | 3 |
| | COUNCIL | HASTINGS DISTRICT COUNCIL | | DSYNE |
| DWG NO P24-244-00-3509-I | | P24-244-00-3509-DR | | e CV12D |

- 1. ALL WORKS & MATERIALS TO COMPLY WITH HASTINGS DISTRICT COUNCIL STANDARDS.
- 2. FOR PIPE BEDDING DETAILS REFER TO STANDARD DETAIL SHEETS UNLESS OTHERWISE NOTED ON THE DRAINAGE LONG SECTIONS IN WHICH CASE SUCH NOTES TAKE PRECEDENCE.
- 3. CONCRETE PIPES CLASSES ARE NOTED ON THE DRAINAGE LONG SECTIONS. ALL SUMP LEADS TO BE RCRU CLASS 4.
- 4. ALL PIPE CROSSINGS UNDER ROADS TO BE HARDFILL BACKFILLED.
- ALL SW LOT CONNECTIONS TO BE 150MMØ, RAMPED RISERS ARE TO BE EXTENDED & CAPPED OFF WITHIN 1.0M OF THE FINISHED GROUND SURFACE.
- SW LOT CONNECTIONS ARE VIA KERB OUTLETS UNLESS OTHERWISE STATED. KERB OUTLETS TO FOLLOW HASTINGS DISTRICT COUNCIL ENGINEERING CODE OF PRACTICE STANDARD DRAWINGS WS 105 AND WS 106.
- 7. ALL MANHOLES TO BE 1050MMØ UNLESS OTHERWISE NOTED ON THE DRAINAGE LONG SECTION IN WHICH CASE SUCH NOTES SHALL TAKE PRECEDENCE.
- 8. THE CONTRACTOR IS TO PEG MANHOLES & CHECK FINISHED LEVELS (MH LID LEVELS) PRIOR TO ORDERING MANHOLES.
- 9. ALL MANHOLE LIDS IN CYCLEWAYS AND SHARED PATHS MUST HAVE A CYCLIST FRIENDLY COVER.
- 10. PIPE GRADES ON THE LONG SECTIONS ARE CALCULATED FROM MANHOLE SIDE TO MANHOLE SIDE. THE CONTRACTOR IS RESPONSIBLE FOR ENSURING THAT LASER LEVELS ARE SET TO COMPENSATE FOR THIS.



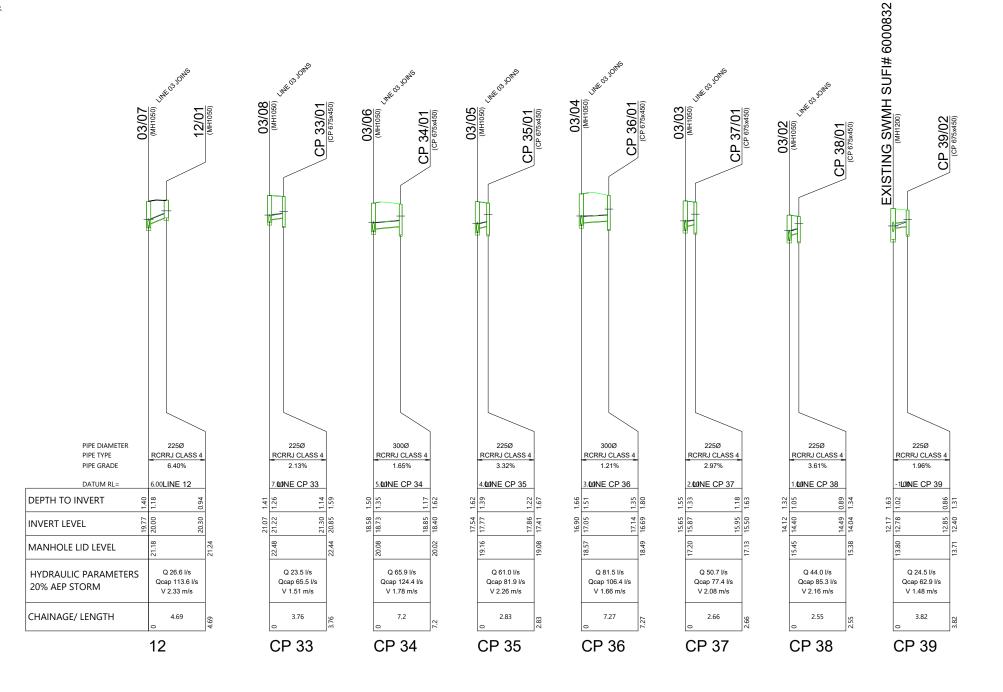

| SCAL | EBAR (m) | | SCALE 1:1000 @A3 1:500 @A1 |
|--------|----------|----|-------------------------------------|
| HOR. 0 | 10 | 20 | 50 |
| VERT. | 2 | 4 | 10 SCALE 1:200 @A3 1:100 @A1 |


| REVISION DETAILS | | INT | DATE | SURVEYED | WOODS |
|------------------|--------------|-----|----------|------------------------|----------------|
| ISSUED FO | R DISCUSSION | AS | APR 2025 | DESIGNED | AS |
| ISSUED FO | CONSENT | AS | JUN 2025 | DRAWN | AS |
| | | | | CHECKED | BLO |
| | | | | APPROVED | BF |
| ISSUED FO | R DISCUSSION | AS | APR 2025 | DESIGNED DRAWN CHECKED | AS AS BL |







| ARATAKI DEVELOPMENT - HAVELOCK NORTH |
|--------------------------------------|
| STORMWATER LONGSECTIONS SHEET 11 |

| STATUS | ISSUED FOR CONSENT | REV |
|---------|---------------------------|-----|
| SCALE | H 1:1000 V 1:200 @ A3 | 2 |
| COUNCIL | HASTINGS DISTRICT COUNCIL | 2 |
| DWG NO | P24-244-00-3510-DR | |

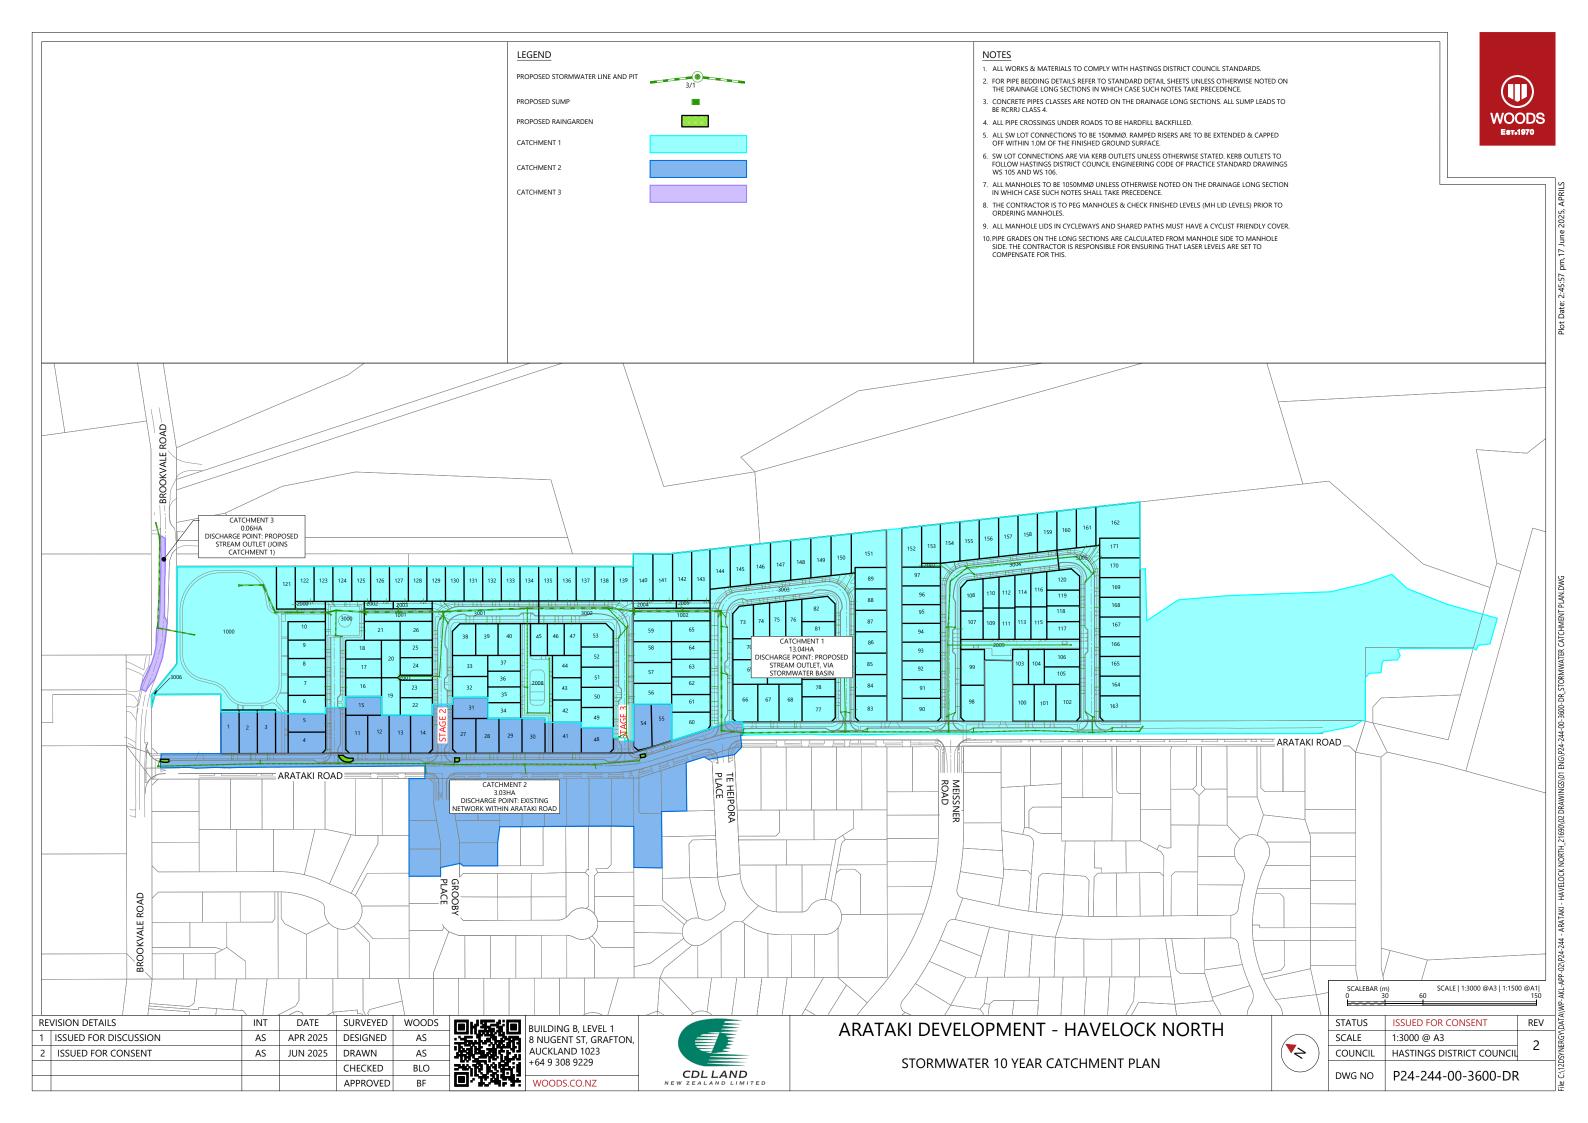

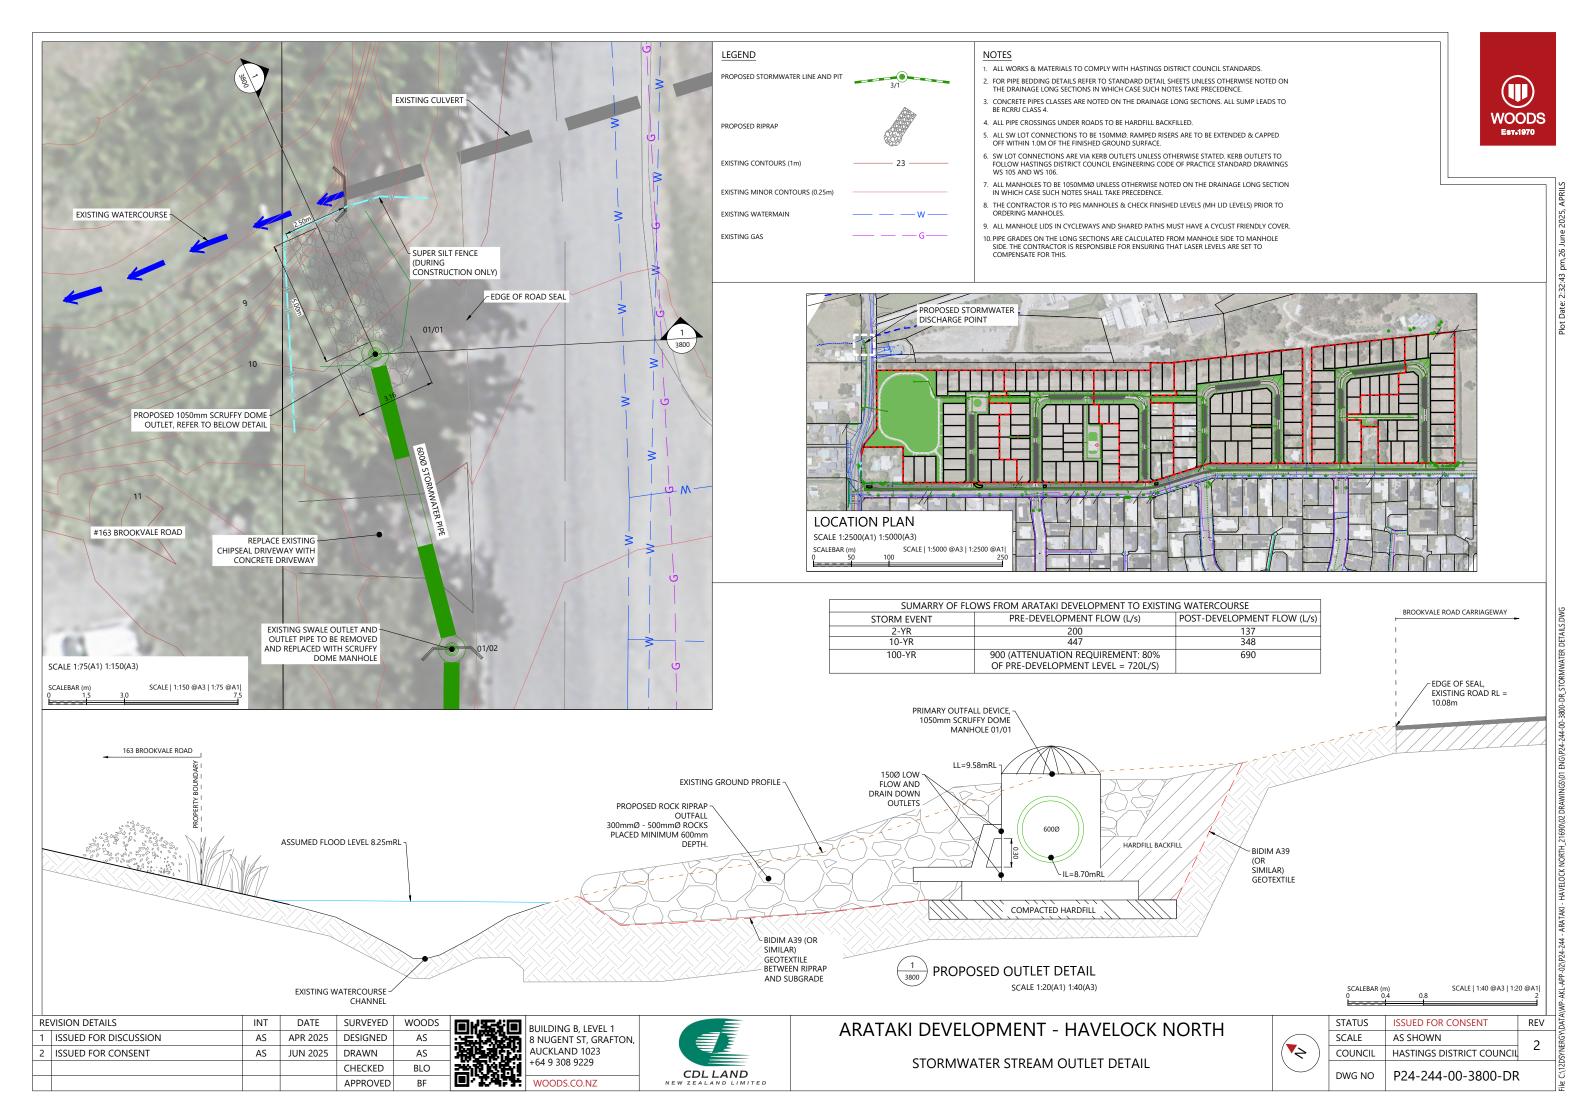

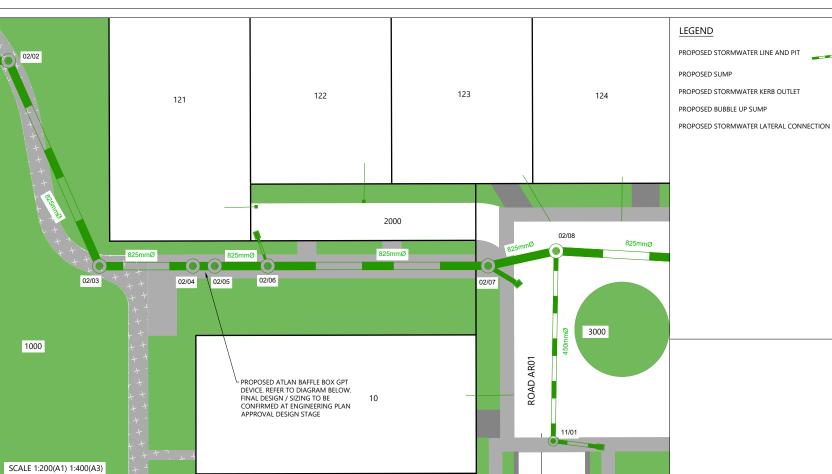




- ALL WORKS & MATERIALS TO COMPLY WITH HASTINGS DISTRICT COUNCIL STANDARDS.
- FOR PIPE BEDDING DETAILS REFER TO STANDARD DETAIL SHEETS UNLESS OTHERWISE NOTED ON
- CONCRETE PIPES CLASSES ARE NOTED ON THE DRAINAGE LONG SECTIONS. ALL SUMP LEADS TO BE RCRRJ CLASS 4.
- 4. ALL PIPE CROSSINGS UNDER ROADS TO BE HARDFILL BACKFILLED.

- 5. ALL SW LOT CONNECTIONS TO BE 150MMØ. RAMPED RISERS ARE TO BE EXTENDED & CAPPED OFF WITHIN 1.0M OF THE FINISHED GROUND SURFACE.
- SW LOT CONNECTIONS ARE VIA KERB OUTLETS UNLESS OTHERWISE STATED. KERB OUTLETS TO
 FOLLOW HASTINGS DISTRICT COUNCIL ENGINEERING CODE OF PRACTICE STANDARD DRAWINGS
 WS 105 AND WS 106.
- 7. ALL MANHOLES TO BE 1050MMØ UNLESS OTHERWISE NOTED ON THE DRAINAGE LONG SECTION IN WHICH CASE SUCH NOTES SHALL TAKE PRECEDENCE.
- 8. THE CONTRACTOR IS TO PEG MANHOLES & CHECK FINISHED LEVELS (MH LID LEVELS) PRIOR TO ORDERING MANHOLES.
- 9. ALL MANHOLE LIDS IN CYCLEWAYS AND SHARED PATHS MUST HAVE A CYCLIST FRIENDLY COVER.
- 10. PIPE GRADES ON THE LONG SECTIONS ARE CALCULATED FROM MANHOLE SIDE TO MANHOLE SIDE. THE CONTRACTOR IS RESPONSIBLE FOR ENSURING THAT LASER LEVELS ARE SET TO COMPENSATE FOR THIS.



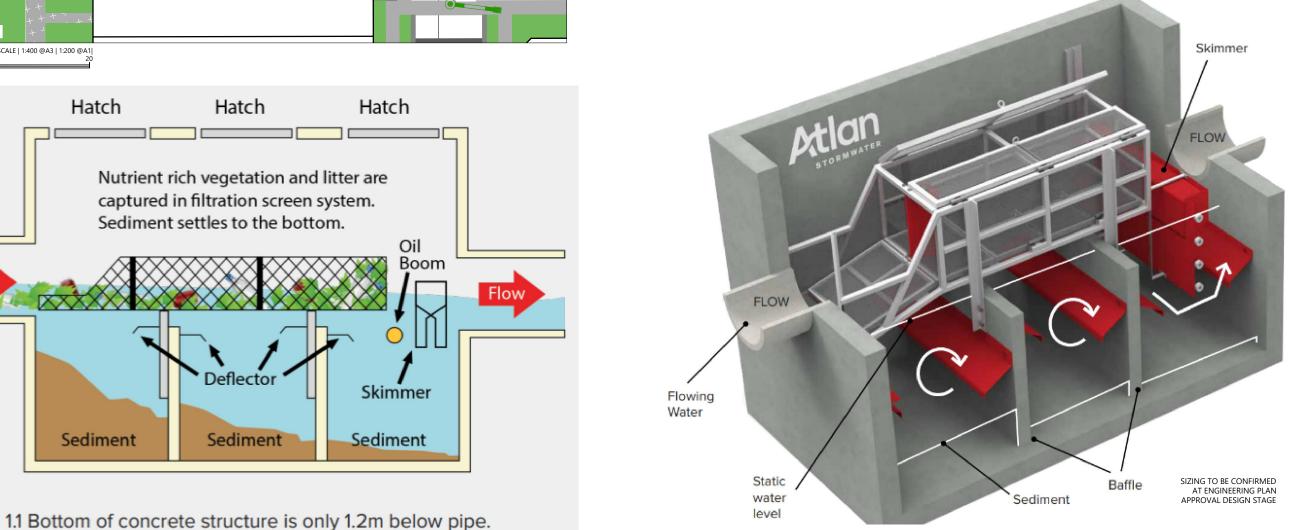

| REVISION DETAILS | | | DATE | SURVEYED | WOODS |
|------------------|-----------------------|----|----------|----------|-------|
| 1 | ISSUED FOR DISCUSSION | AS | APR 2025 | DESIGNED | AS |
| 2 | ISSUED FOR CONSENT | AS | JUN 2025 | DRAWN | AS |
| | | | | CHECKED | BLO |

Sediment

SCALEBAR (m)

SCALE | 1:400 @A3 | 1:200 @A1|

Hatch



APPROVED

BUILDING B, LEVEL 1 8 NUGENT ST, GRAFTON, AUCKLAND 1023 +64 9 308 9229 WOODS.CO.NZ




ARATAKI DEVELOPMENT - HAVELOCK NORTH

STORMWATER GPT DETAIL


NOT TO SCALE


| | SIATUS |
|--------|--------|
| | SCALE |
| (<>) | COUNC |
| | DWG N |

| | | | | 3 |
|---|---------|---------------------------|-----|--------------|
| | STATUS | ISSUED FOR CONSENT | REV | |
| \ | SCALE | 1:400 @ A3 | 2 | POCYNERGYOAT |
|) | COUNCIL | HASTINGS DISTRICT COUNCIL | | SVAIC |
| / | DWG NO | P24-244-00-3810-DR | | In C.13P |

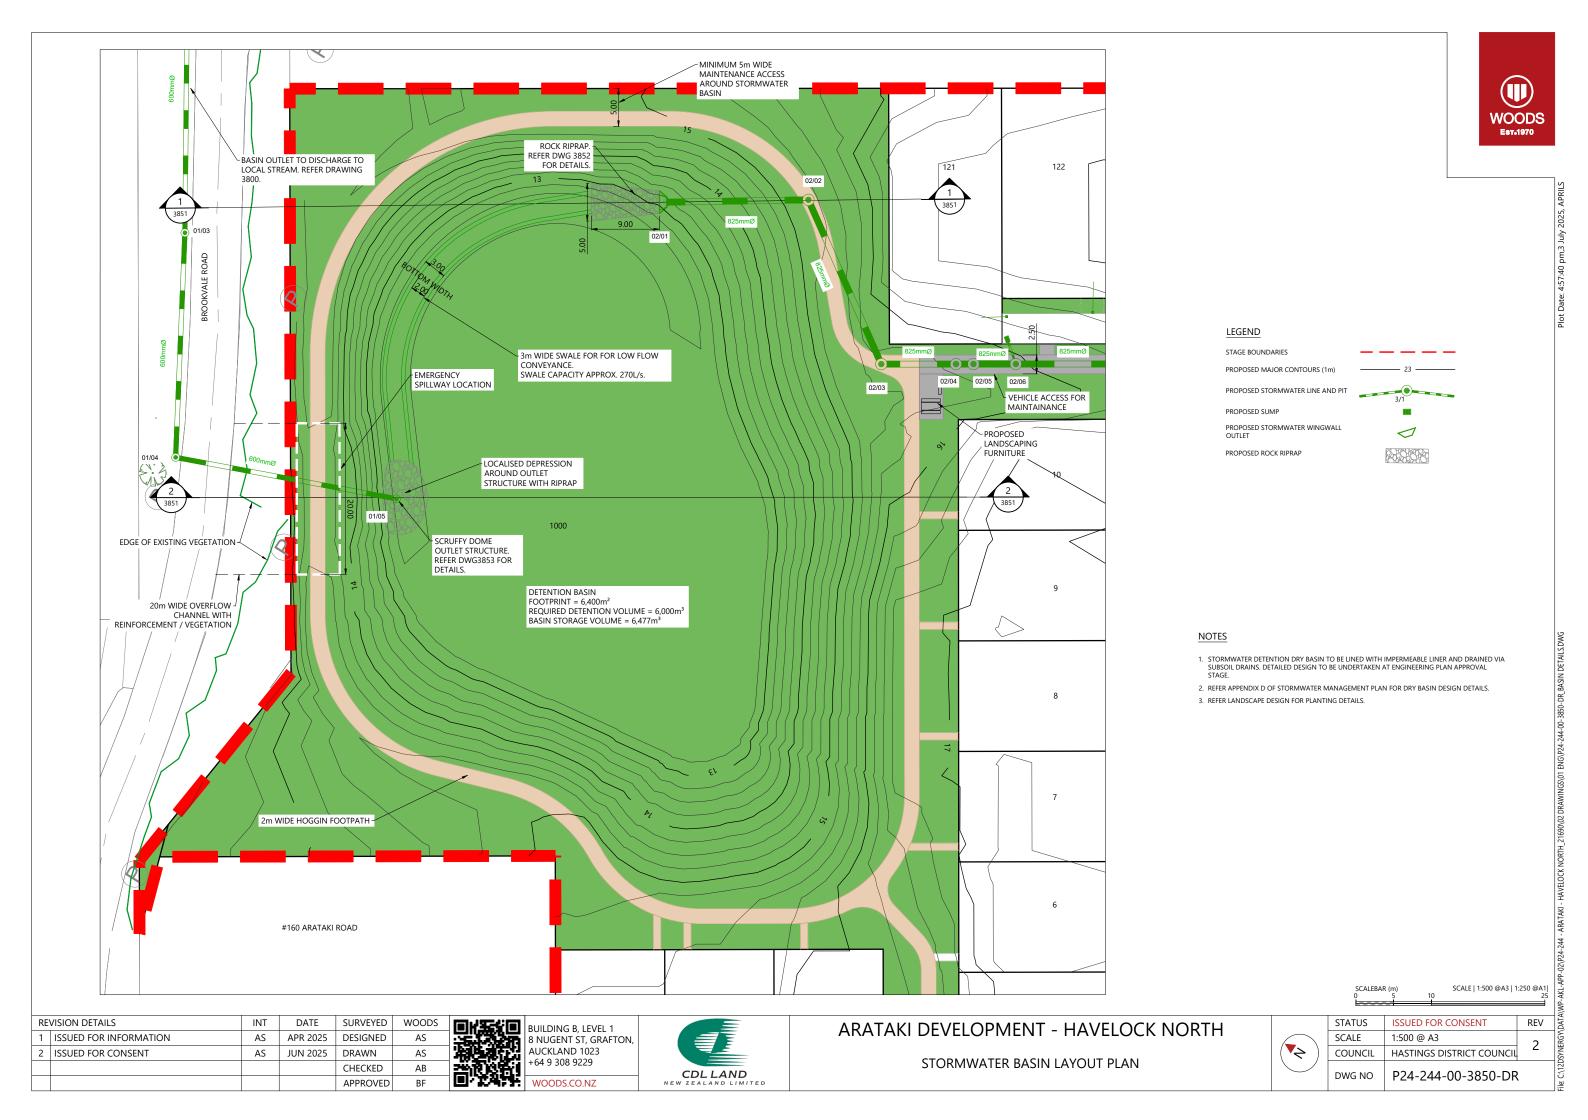



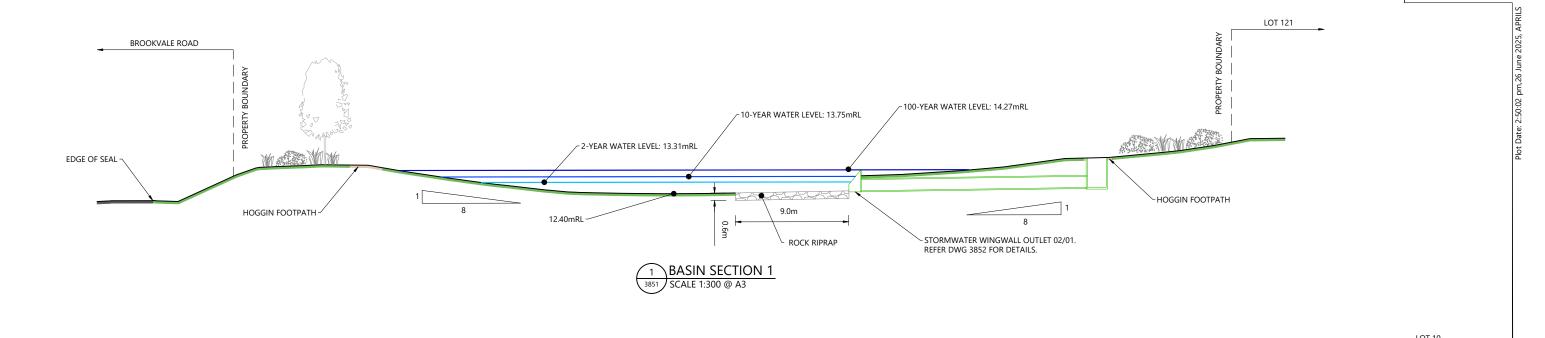

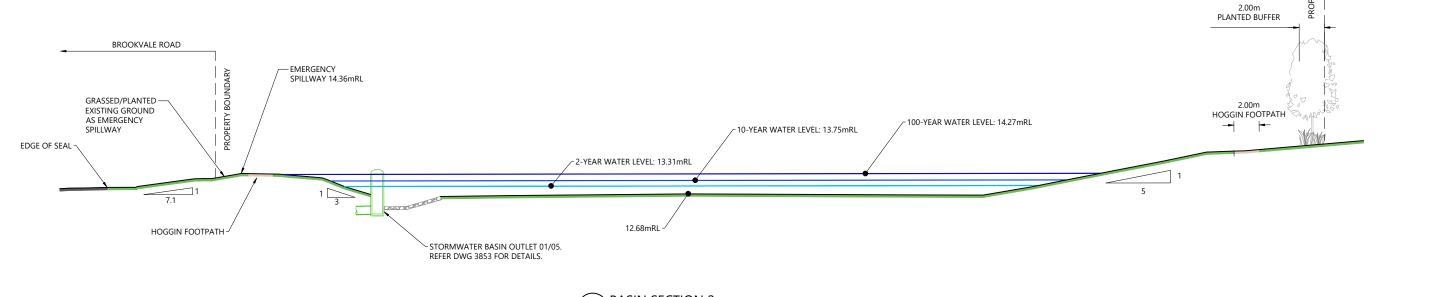

BASIN SECTION 2
SCALE 1:300 @ A3

| 1 | | | | | |
|------------------|------------------------|----|----------|----------|-------|
| REVISION DETAILS | | | DATE | SURVEYED | WOODS |
| 1 | ISSUED FOR INFORMATION | AS | APR 2025 | DESIGNED | AS |
| 2 | ISSUED FOR CONSENT | AS | JUN 2025 | DRAWN | AS |
| | | | | CHECKED | AB |
| | | | | APPROVED | RF |




BUILDING B, LEVEL 1 8 NUGENT ST, GRAFTON, AUCKLAND 1023 +64 9 308 9229 WOODS.CO.NZ





ARATAKI DEVELOPMENT - HAVELOCK NORTH STORMWATER BASIN SECTIONS

| STATUS | ISSUED FOR CONSENT | REV |
|---------|---------------------------|-----|
| SCALE | 1:300 @ A3 | 2 |
| COUNCIL | HASTINGS DISTRICT COUNCIL | |
| DWG NO | P24-244-00-3851-DR | |



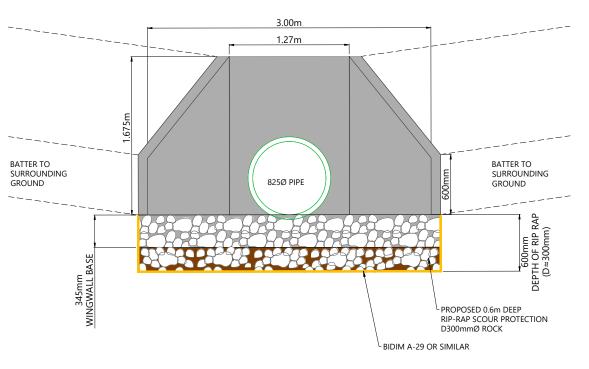

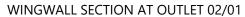

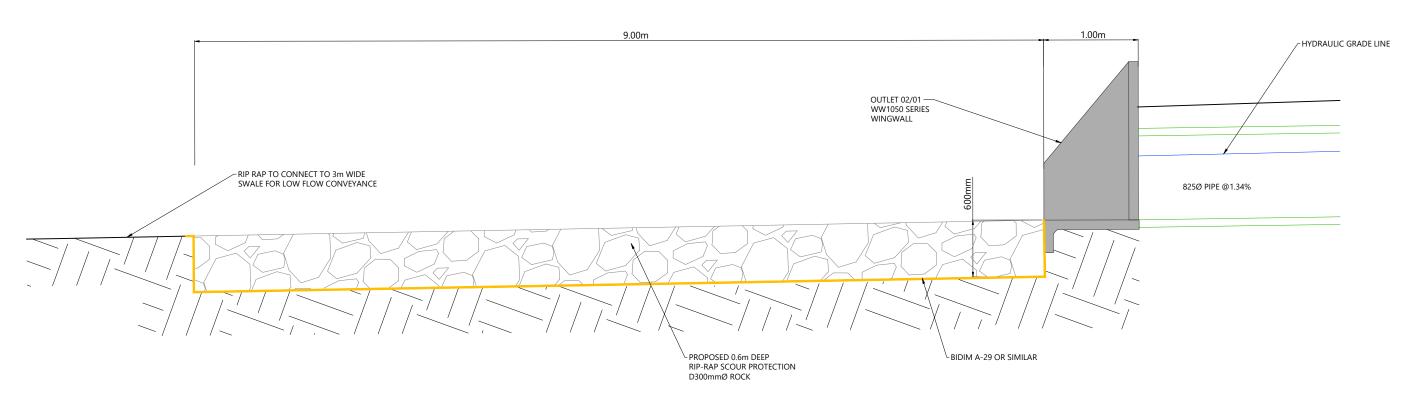

RIPRAP SECTION AT OUTLET 02/01

| | | | | | | | SCALEE 0 L===== | 0.4 0.8 | PAS 1:20 @A1 2 7 7 7 7 7 7 7 7 | |
|------------------------|-----|----------|----------|-------|---------------------|--|-----------------------|--------------------|---|---|
| VISION DETAILS | INT | DATE | SURVEYED | WOODS | BUILDING B, LEVEL 1 | ARATAKI DEVELOPMENT - HAVELOCK NORTH | STATUS | ISSUED FOR CONSENT | REV A | Š |
| ISSUED FOR INFORMATION | ۸ς | ADR 2025 | DESIGNED | ۸ς | BUILDING B, LEVEL I | ARATARI DEVELOPIVIENT - HAVELOCK NORTH | SCALE | 1·40 @ A3 | 5 | ń |

| RE | VISION DETAILS | INT | DATE | SURVEYED | WOODS |
|----|------------------------|-----|----------|----------|-------|
| 1 | ISSUED FOR INFORMATION | AS | APR 2025 | DESIGNED | AS |
| 2 | ISSUED FOR CONSENT | AS | JUN 2025 | DRAWN | AS |
| | | | | CHECKED | AB |
| | | | | APPROVED | BF |







| ARATAKI DEVELOPMENT - HAVELOCK NORTI | ARATA | AKI DEV | ELOPMEN | T - HA\ | /ELOCK | NORTH |
|--------------------------------------|-------|---------|---------|---------|--------|-------|
|--------------------------------------|-------|---------|---------|---------|--------|-------|

| WINGWALL OUTLET 02/01 | DETAILS |
|---|--------------|
| *************************************** | 2 2 17 11 23 |


| STATUS | ISSUED FOR CONSENT | REV |
|---------|---------------------------|-----|
| SCALE | 1:40 @ A3 | 2 |
| COUNCIL | HASTINGS DISTRICT COUNCIL | |
| DWG NO | P24-244-00-3852-DR | |

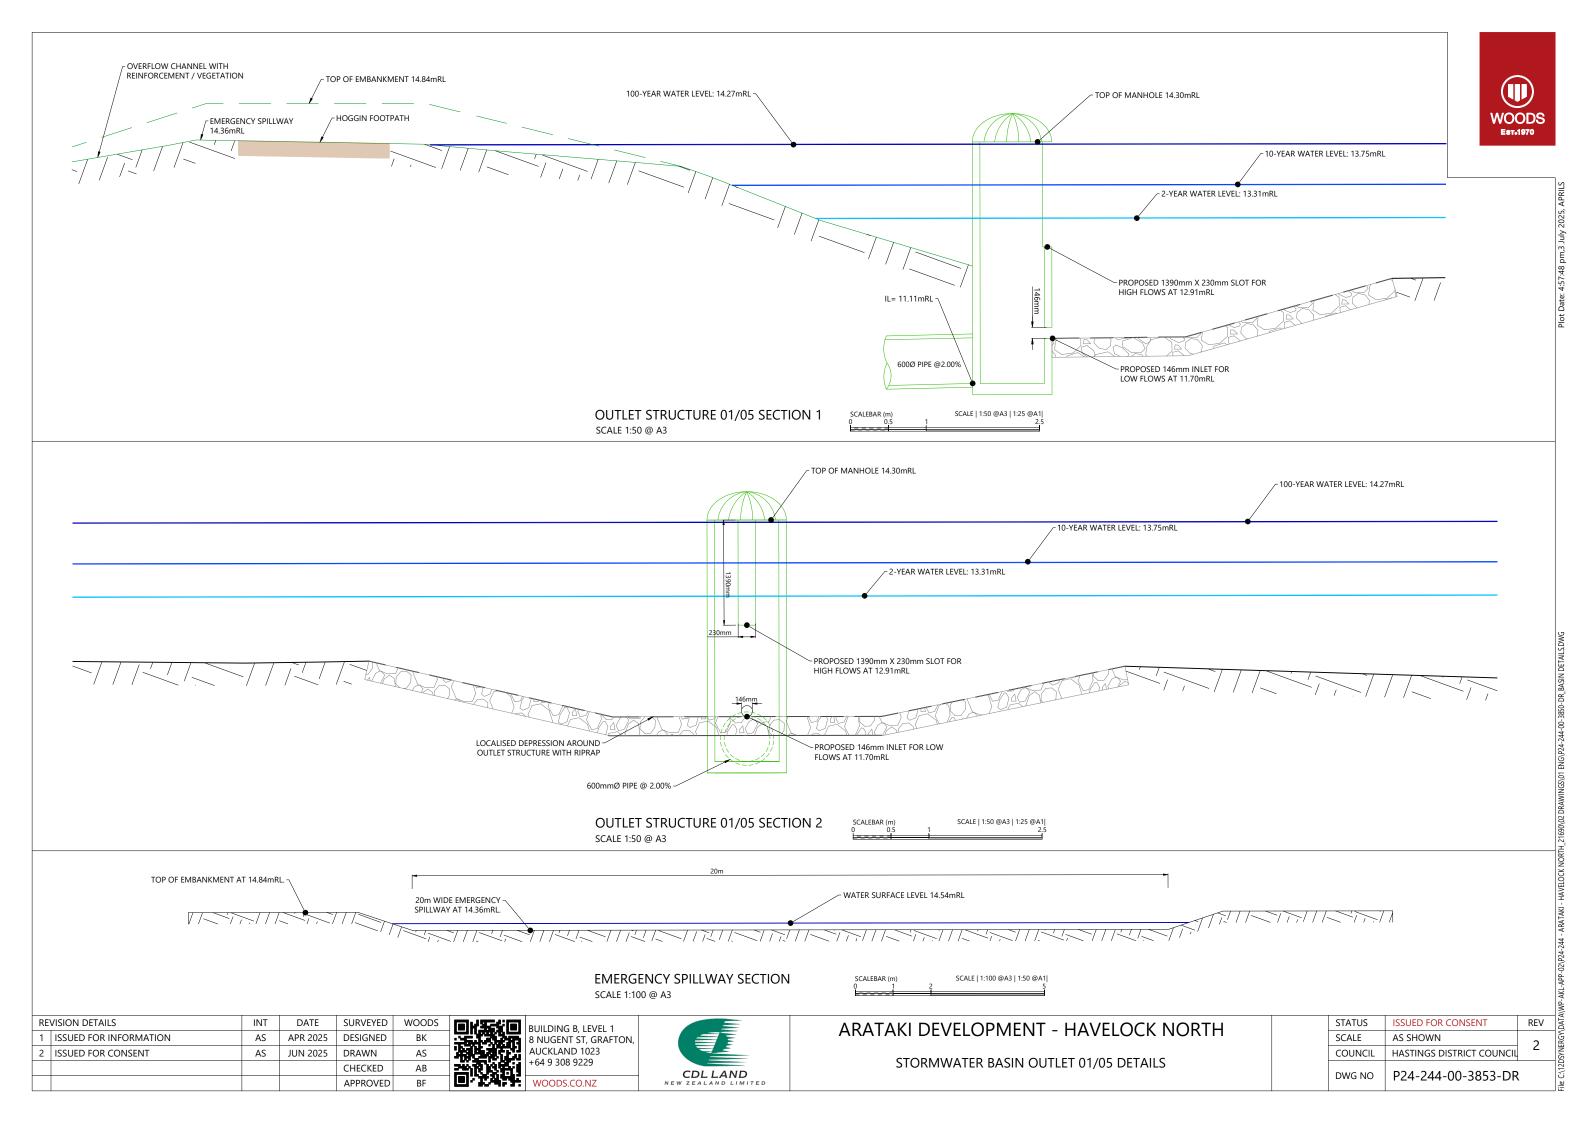


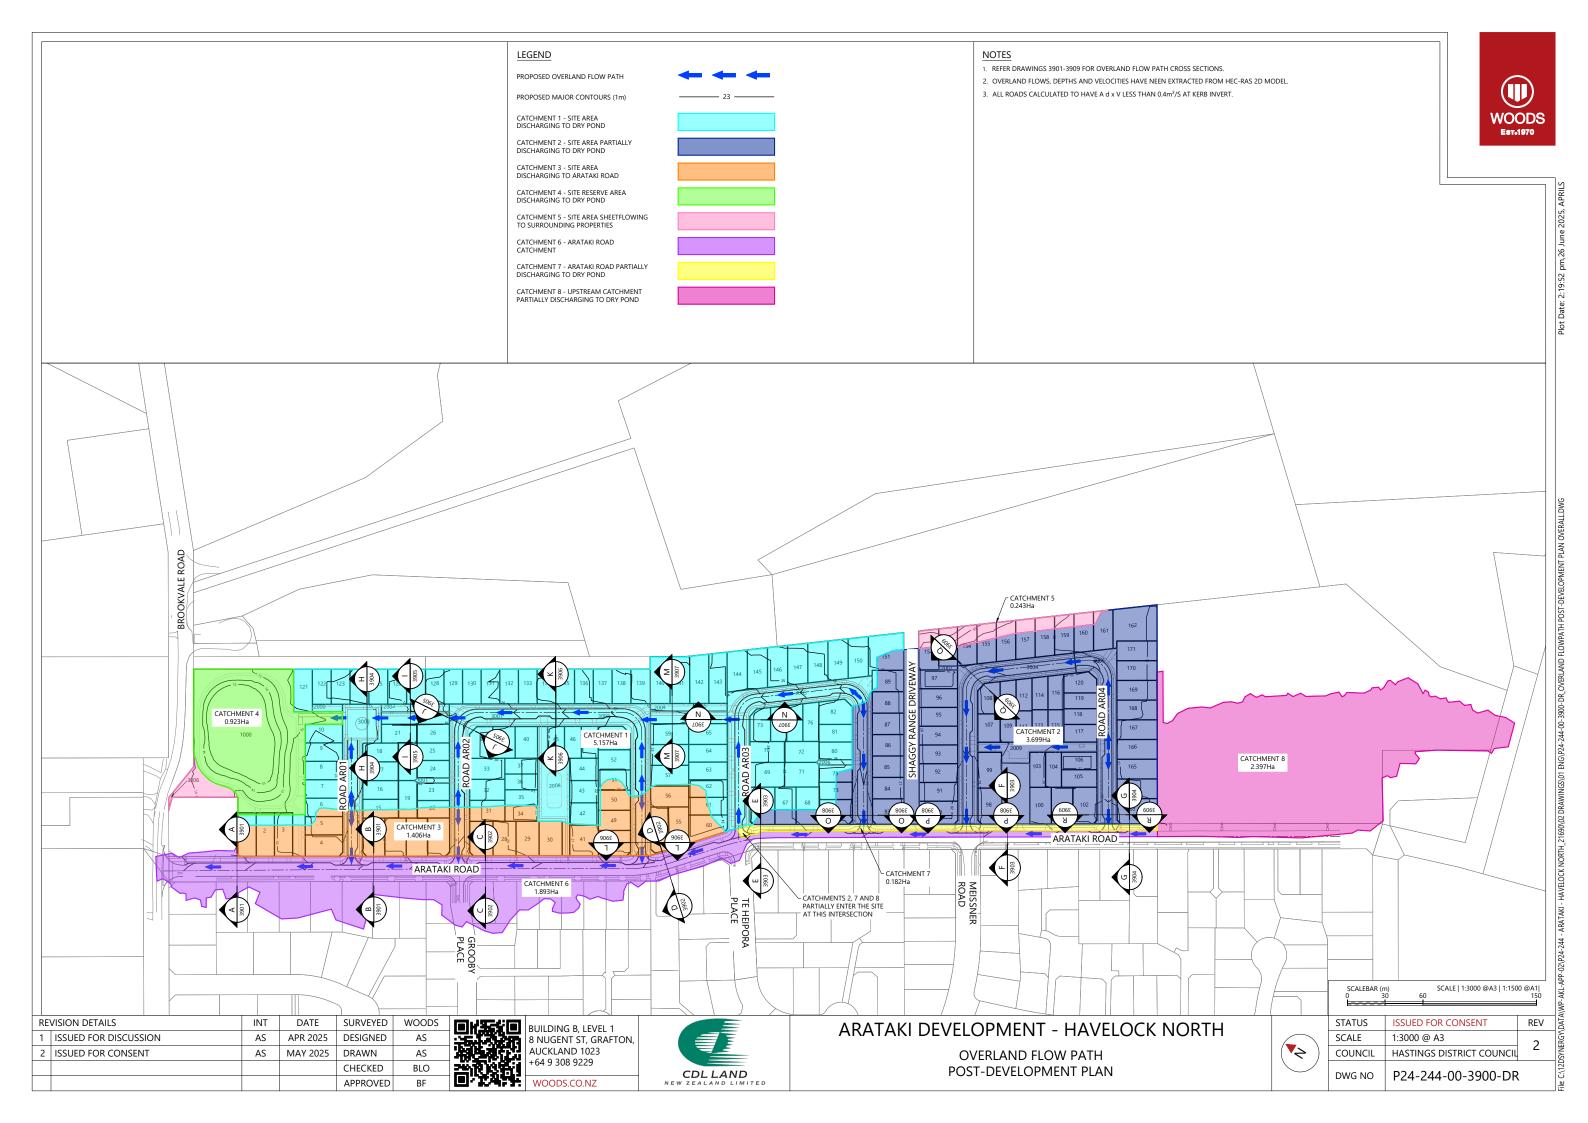

OVERLAND FLOWS, DEPTHS AND VELOCITIES HAVE NEEN EXTRACTED FROM HEC-RAS 2D MODEL.

ALL ROADS CALCULATED TO HAVE A d x V LESS THAN 0.4m²/S AT KERB INVERT.

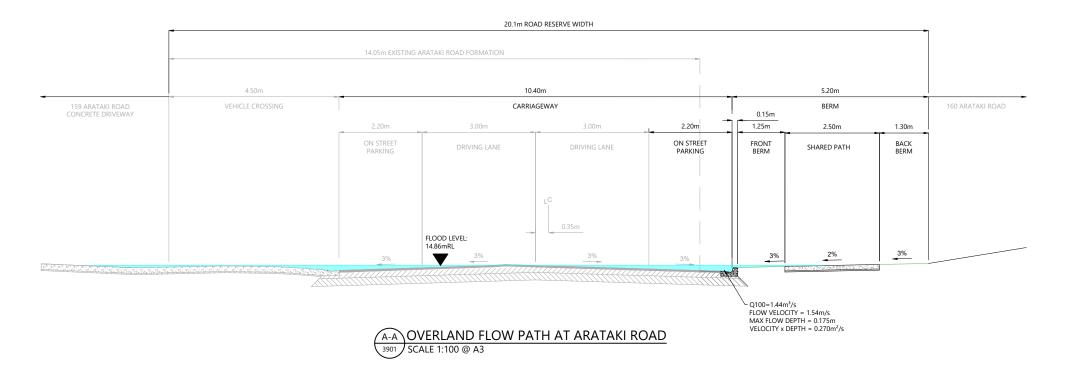

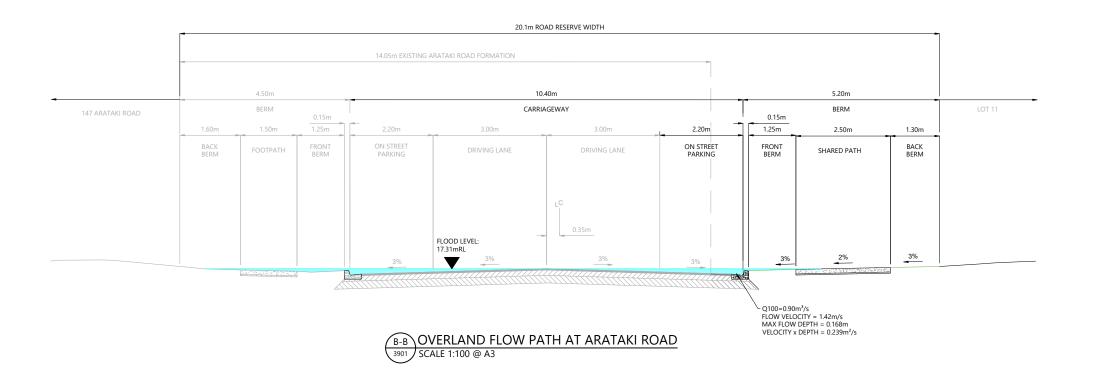

SCALEBAR (m) SCALE | 1:100 @A3 | 1:50 @A1|

| RE | VISION DETAILS | INT | DATE | SURVEYED | WOODS |
|----|------------------------|-----|----------|----------|-------|
| 1 | ISSUED FOR INFORMATION | AS | APR 2025 | DESIGNED | AS |
| 2 | ISSUED FOR CONSENT | AS | JUN 2025 | DRAWN | AS |
| | | | | CHECKED | BLO |
| | | | | APPROVED | BF |



BUILDING B, LEVEL 1
8 NUGENT ST, GRAFTON,
AUCKLAND 1023
+64 9 308 9229

WOODS.CO.NZ





ARATAKI DEVELOPMENT - HAVELOCK NORTH

| STATUS | ISSUED FOR CONSENT | REV |
|---------|---------------------------|-----|
| SCALE | 1:100 @ A3 | 2 |
| COUNCIL | HASTINGS DISTRICT COUNCIL | |
| DWG NO | P24-244-00-3901-DR | |

 OVERLAND FLOWS, DEPTHS AND VELOCITIES HAVE NEEN EXTRACTED FROM HEC-RAS 2D MODEL.

 ALL ROADS CALCULATED TO HAVE A d x V LESS THAN 0.4m²/S AT KERB INVERT.

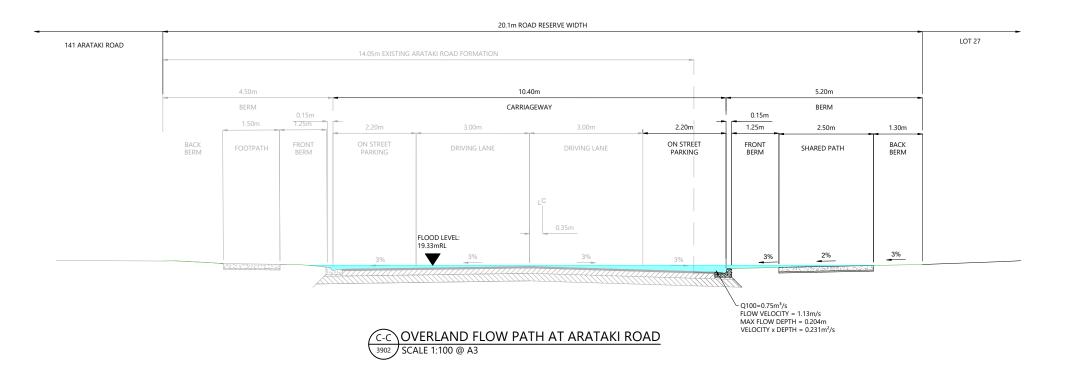

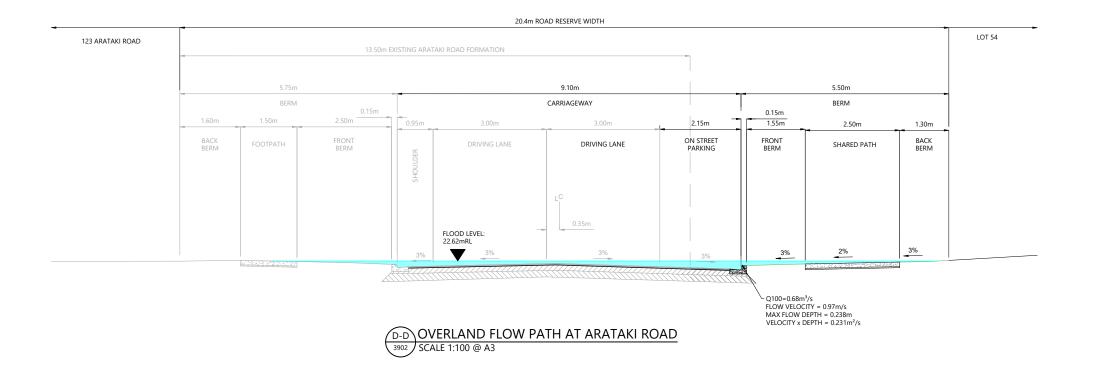

SCALEBAR (m) SCALE | 1:100 @A3 | 1:50 @A1 | 0 1 2 5

| RE | VISION DETAILS | INT | DATE | SURVEYED | WOODS |
|----|------------------------|-----|----------|----------|-------|
| 1 | ISSUED FOR INFORMATION | AS | APR 2025 | DESIGNED | AS |
| 2 | ISSUED FOR CONSENT | AS | JUN 2025 | DRAWN | AS |
| | | | | CHECKED | BLO |
| | | | | APPROVED | BF |



BUILDING B, LEVEL 1
8 NUGENT ST, GRAFTON,
AUCKLAND 1023
+64 9 308 9229

WOODS.CO.NZ




ARATAKI DEVELOPMENT - HAVELOCK NORTH


OVERLAND FLOW SECTIONS

| STATUS | ISSUED FOR CONSENT | REV |
|---------|---------------------------|-----|
| SCALE | 1:100 @ A3 | 2 |
| COUNCIL | HASTINGS DISTRICT COUNCIL | |
| DWG NO | P24-244-00-3902-DR | |

 OVERLAND FLOWS, DEPTHS AND VELOCITIES HAVE NEEN EXTRACTED FROM HEC-RAS 2D MODEL.

 ALL ROADS CALCULATED TO HAVE A d x V LESS THAN 0.4m²/S AT KERB INVERT.

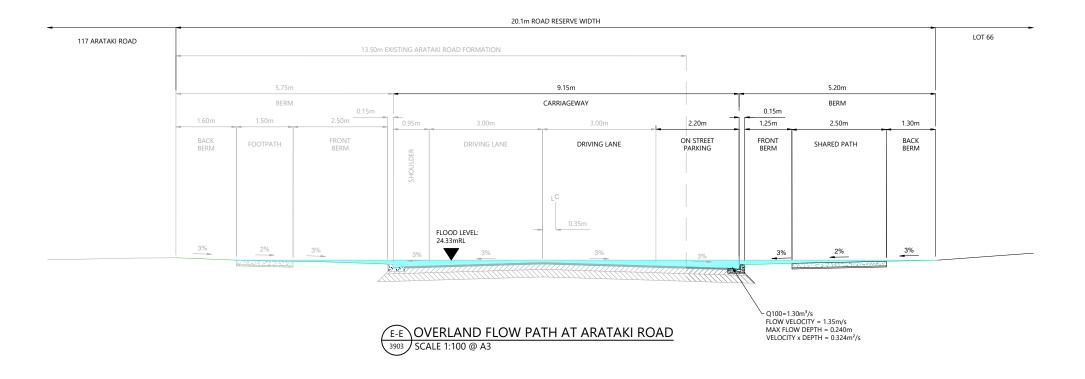

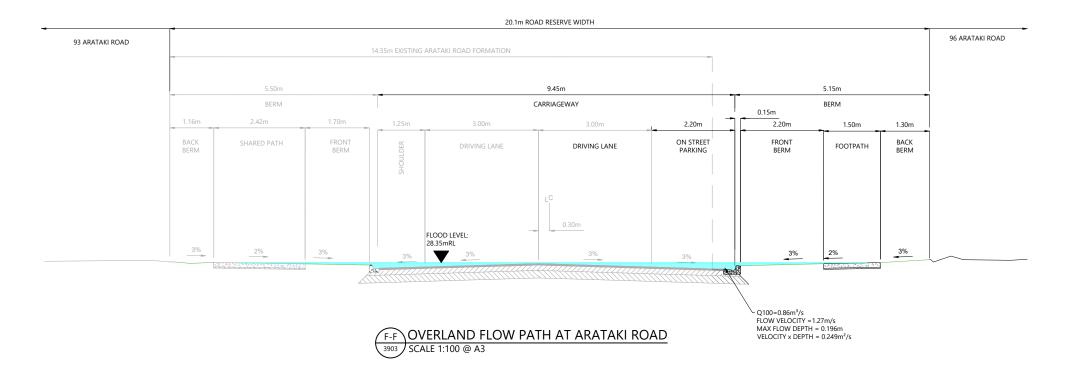

| ı | | | | | |
|------------------|------------------------|-----|----------|----------|-------|
| REVISION DETAILS | | INT | DATE | SURVEYED | WOODS |
| 1 | ISSUED FOR INFORMATION | AS | APR 2025 | DESIGNED | AS |
| 2 | ISSUED FOR CONSENT | AS | JUN 2025 | DRAWN | AS |
| | | | | CHECKED | BLO |
| | | | | APPROVED | BF |



BUILDING B, LEVEL 1
8 NUGENT ST, GRAFTON,
AUCKLAND 1023
+64 9 308 9229
WOODS.CO.NZ



ARATAKI DEVELOPMENT - HAVELOCK NORTH

OVERLAND FLOW SECTIONS


| STATUS | ISSUED FOR CONSENT | REV |
|---------|---------------------------|-----|
| SCALE | 1:100 @ A3 | 2 |
| COUNCIL | HASTINGS DISTRICT COUNCIL | |
| DWG NO | P24-244-00-3903-DR | |



OVERLAND FLOWS, DEPTHS AND VELOCITIES HAVE NEEN EXTRACTED FROM HEC-RAS 2D MODEL.

ALL ROADS CALCULATED TO HAVE A d x V LESS THAN 0.4m²/S AT KERB INVERT.

20.1m ROAD RESERVE WIDTH 85A ARATAKI ROAD CONCRETE DRIVEWAY LOT 163 9.45m BERM CARRIAGEWAY BERM 0.15m 1.65m 0.15m 2.50m 2.20m 1.50m 1.30m ON STREET PARKING BACK BERM FRONT BERM DRIVING LANE FOOTPATH FLOOD LEVEL: 30.38mRL 3% \blacksquare CQ100=0.66m³/S FLOW VELOCITY =1.13m/s MAX FLOW DEPTH =0.214m VELOCITY x DEPTH =0.242m²/s G-G OVERLAND FLOW PATH AT ARATAKI ROAD

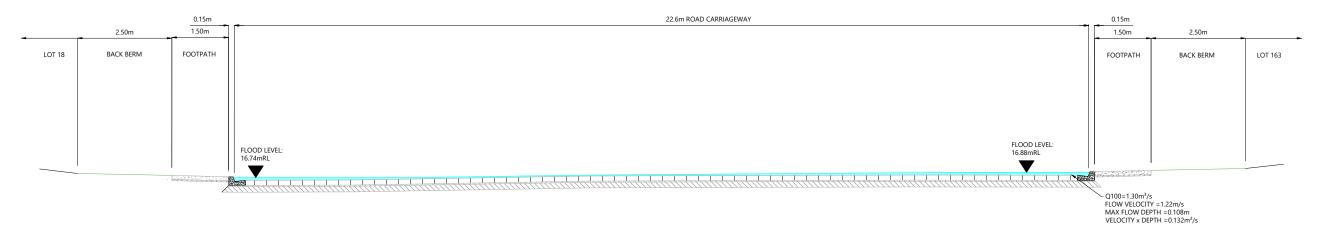

OVERLAND FLOW PATH AT ROAD AR01
SCALE 1:100 @ A3

| SCALEBA | R (m) | | SCALE 1:100 @A3 1:50 |) @A1 |
|---------|-------|---|--------------------------|-------|
| 0 | 1 | 2 | | 5 |
| | _ | | | |
| | | | | |

| RE' | REVISION DETAILS | | DATE | SURVEYED | WOODS |
|-----|------------------------|----|----------|----------|-------|
| 1 | ISSUED FOR INFORMATION | AS | APR 2025 | DESIGNED | AS |
| 2 | ISSUED FOR CONSENT | AS | JUN 2025 | DRAWN | AS |
| | | | | CHECKED | BLO |
| | | | | APPROVED | BF |



BUILDING B, LEVEL 1
8 NUGENT ST, GRAFTON,
AUCKLAND 1023
+64 9 308 9229

WOODS.CO.NZ




3904 | SCALE 1:100 @ A3

ARATAKI DEVELO


| EVELOPMENT - HAVELOCK NORTH | | STATUS | ISSUED FOR CONSENT | REV |
|-----------------------------|--|---------|---------------------------|-----|
| | | SCALE | 1:100 @ A3 | 2 |
| OVERLAND ELOW CECTIONS | | COUNCIL | HASTINGS DISTRICT COUNCIL | ۷ |
| OVERLAND FLOW SECTIONS | | DWG NO | P24-244-00-3904-DR | |



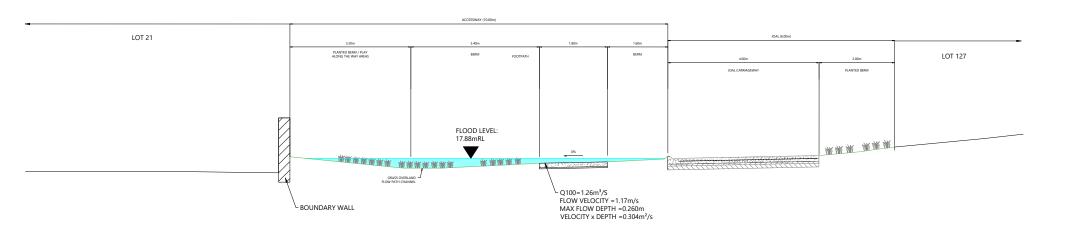

- OVERLAND FLOWS, DEPTHS AND VELOCITIES HAVE NEEN EXTRACTED FROM HEC-RAS 2D MODEL.
- ALL ROADS CALCULATED TO HAVE A d x V LESS THAN 0.4m²/S AT KERB INVERT.

OVERLAND FLOW PATH AT ACCESSWAY LOT 1001 SCALE 1:100 @ A3

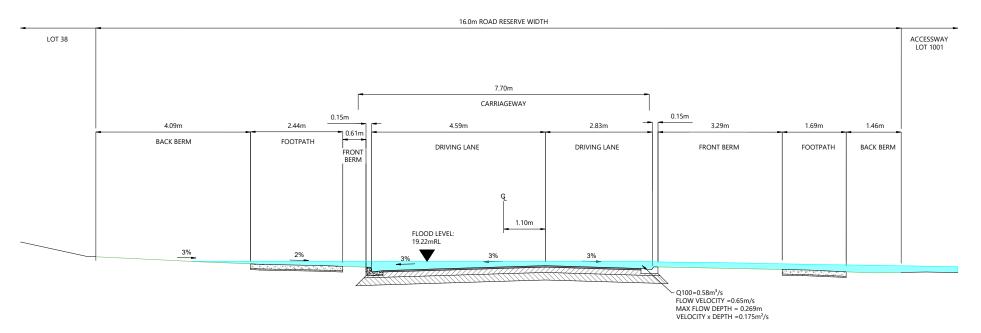

OVERLAND FLOW PATH AT ROAD AR02

3905 SCALE 1:100 @ A3

| SCALEB | AR (m) | | SCALE 1:100 @A3 1:50 @A1 |
|--------|--------|---|------------------------------|
| 0 | 1 | 2 | 5 |
| | | | |

| REVISION DETAILS | | INT | DATE | SURVEYED | WOODS |
|------------------|------------------------|-----|----------|----------|-------|
| 1 | ISSUED FOR INFORMATION | AS | APR 2025 | DESIGNED | AS |
| 2 | ISSUED FOR CONSENT | AS | JUN 2025 | DRAWN | AS |
| | | | | CHECKED | BLO |
| | | | | APPROVED | BF |







| ARATAKI DEVELOPMENT - HAVELOCK NORTH |
|--------------------------------------|
| OVERLAND FLOW SECTIONS |

| STATUS | ISSUED FOR CONSENT | REV |
|---------|---------------------------|-----|
| SCALE | 1:100 @ A3 | 2 |
| COUNCIL | HASTINGS DISTRICT COUNCIL | ۷ |
| DWG NO | P24-244-00-3905-DR | |



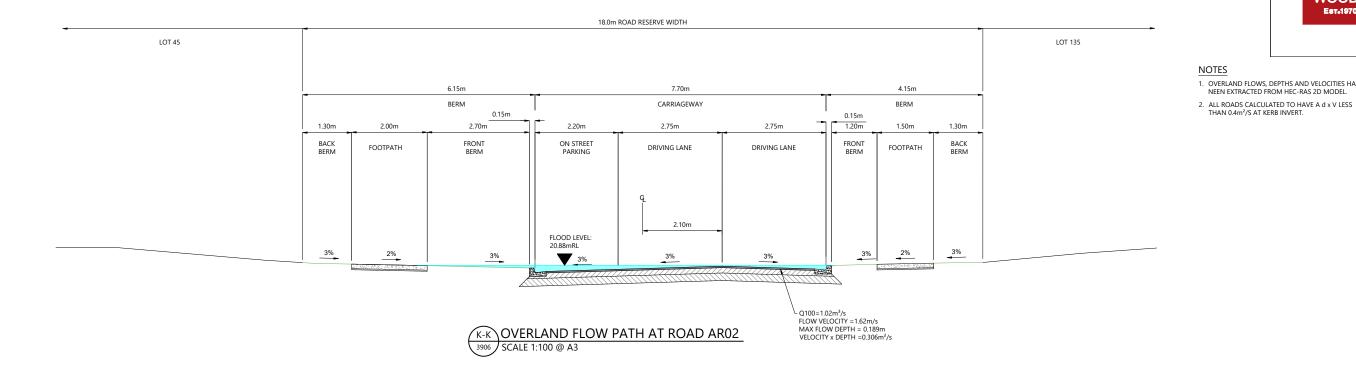

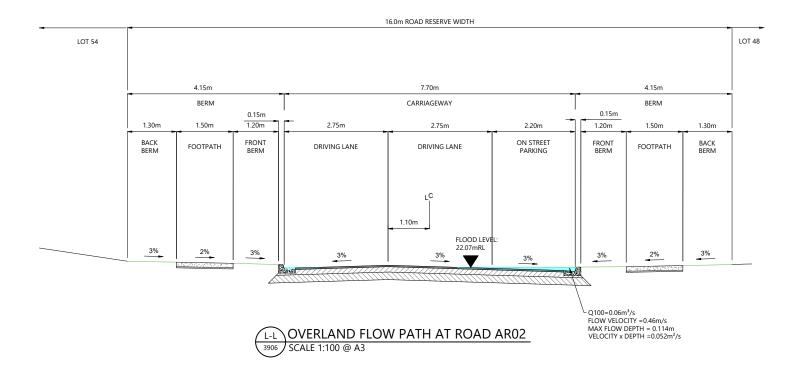

SCALEBAR (m) SCALE | 1:100 @A3 | 1:50 @A1|

| REVISION DETAILS | | INT | DATE | SURVEYED | WOODS |
|------------------|------------------------|-----|----------|-----------|-------|
| 1 | ISSUED FOR INFORMATION | AS | APR 2025 | DESIGNED | AS |
| 2 | ISSUED FOR CONSENT | AS | JUN 2025 | DRAWN | AS |
| | | | | CHECKED | BLO |
| | | | | A DDDOVED | RΕ |



BUILDING B, LEVEL 1 8 NUGENT ST, GRAFTON, AUCKLAND 1023 +64 9 308 9229 WOODS.CO.NZ




ARATAKI DEVELOPMENT - HAVELOCK NORTH **OVERLAND FLOW SECTIONS**

| STATUS | ISSUED FOR CONSENT | REV |
|---------|---------------------------|-----|
| SCALE | 1:100 @ A3 | |
| COUNCIL | HASTINGS DISTRICT COUNCIL | |
| DWG NO | P24-244-00-3906-DR | |


OVERLAND FLOWS, DEPTHS AND VELOCITIES HAVE NEEN EXTRACTED FROM HEC-RAS 2D MODEL.



- OVERLAND FLOWS, DEPTHS AND VELOCITIES HAVE NEEN EXTRACTED FROM HEC-RAS 2D MODEL.
- ALL ROADS CALCULATED TO HAVE A d x V LESS THAN 0.4m²/S AT KERB INVERT.

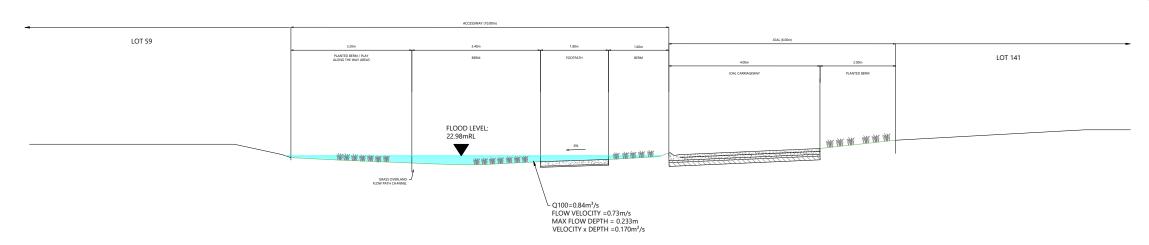

M-M OVERLAND FLOW PATH AT ACCESSWAY LOT 1002 3907 | SCALE 1:100 @ A3

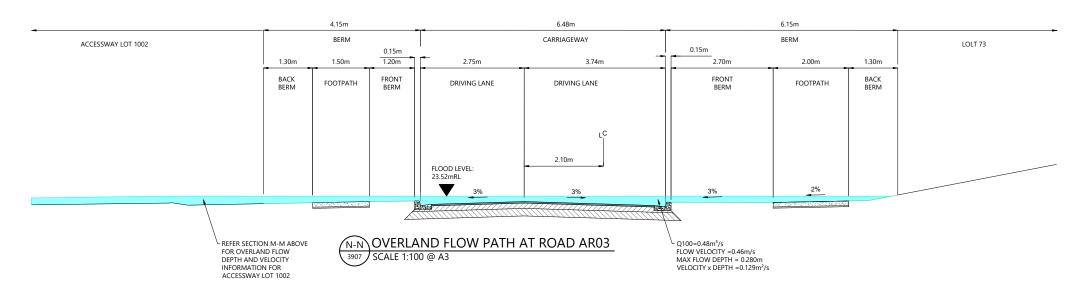

SCALEBAR (m) SCALE | 1:100 @A3 | 1:50 @A1|

| REVISION DETAILS | | INT | DATE | SURVEYED | WOODS |
|------------------|------------------------|-----|----------|------------|-------|
| 1 | ISSUED FOR INFORMATION | AS | APR 2025 | DESIGNED | AS |
| 2 | ISSUED FOR CONSENT | AS | JUN 2025 | DRAWN | AS |
| | | | | CHECKED | BLO |
| | | | | ∧ DDDO\\ED | DE |




BUILDING B, LEVEL 1
8 NUGENT ST, GRAFTON,
AUCKLAND 1023
+64 9 308 9229


WOODS.CO.NZ



ARATAKI DEVELOPMENT - HAVELOCK NORTH **OVERLAND FLOW SECTIONS**

| STATUS | ISSUED FOR CONSENT | REV |
|---------|---------------------------|-----|
| SCALE | 1:100 @ A3 | |
| COUNCIL | HASTINGS DISTRICT COUNCIL | |
| DWG NO | P24-244-00-3907-DR | |

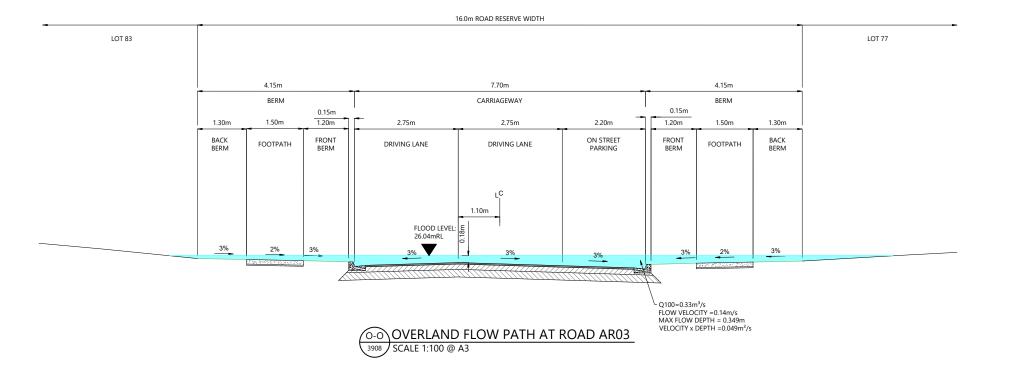

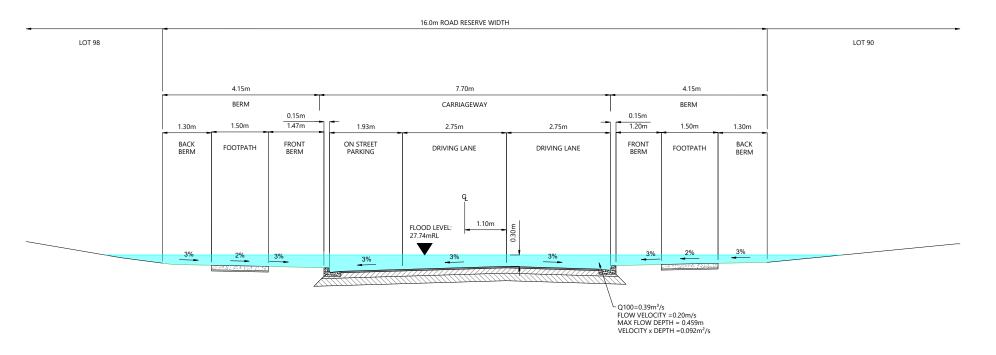

OVERLAND FLOW PATH AT ROAD AR04

SCALE 1:100 @ A3

| SCALEBAR (m) | | SCALE 1:100 @A3 1:50 @A1 |
|--------------|---|------------------------------|
| 0 1 | 2 | 5 |
| | | |

| RE | REVISION DETAILS | | DATE | SURVEYED | WOODS |
|----|------------------------|----|----------|----------|-------|
| 1 | ISSUED FOR INFORMATION | AS | APR 2025 | DESIGNED | AS |
| 2 | ISSUED FOR CONSENT | AS | JUN 2025 | DRAWN | AS |
| | | | | CHECKED | BLO |
| | | | | APPROVED | BF |



BUILDING B, LEVEL 1
8 NUGENT ST, GRAFTON,
AUCKLAND 1023
+64 9 308 9229

WOODS.CO.NZ



| ARATAKI DEVELOPMENT - HAVELOCK NORTH | 1 |
|--------------------------------------|---|
| OVERLAND FLOW SECTIONS | |


| STATUS | ISSUED FOR CONSENT | REV |
|---------|---------------------------|----------|
| SCALE | 1:100 @ A3 | 2 |
| COUNCIL | HASTINGS DISTRICT COUNCIL | |
| DWG NO | P24-244-00-3908-DR | <u>.</u> |


NOTES

OVERLAND FLOWS, DEPTHS AND VELOCITIES HAVE NEEN EXTRACTED FROM HEC-RAS 2D MODEL.

ALL ROADS CALCULATED TO HAVE A d x V LESS THAN 0.4m²/S AT KERB INVERT.



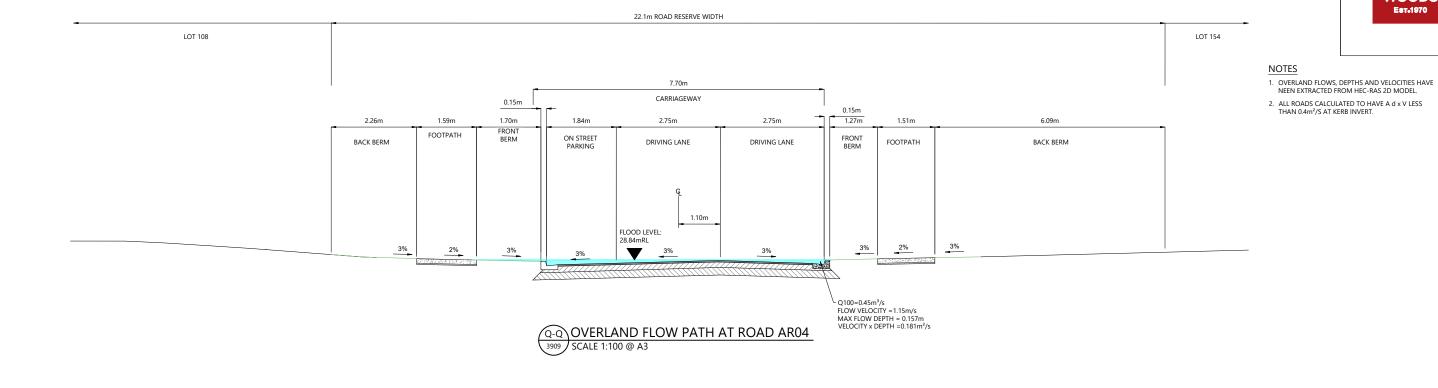

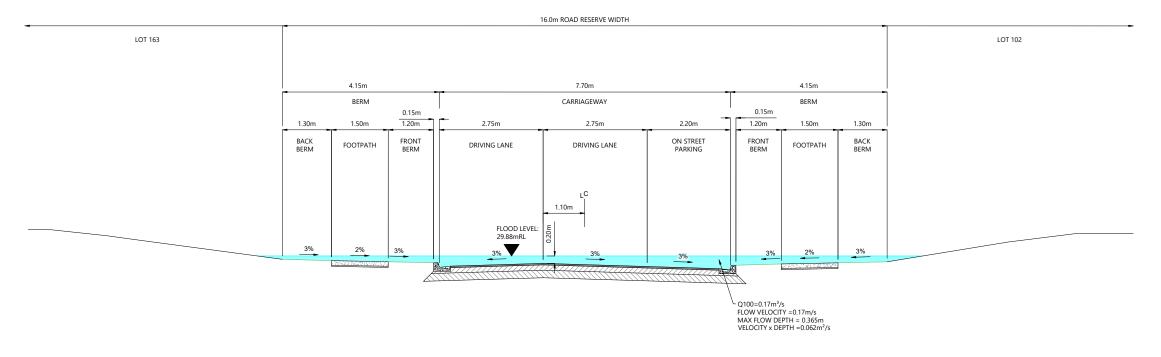

R-R OVERLAND FLOW PATH AT ROAD AR04
SCALE 1:100 @ A3

| SCALEBAR (m) | | SCALE 1:100 @A3 1:50 @A1 |
|--------------|---|------------------------------|
| 0 1 | 2 | 5 |
| | | |

| REVISION DETAILS | | INT | DATE | SURVEYED | WOODS |
|------------------|------------------------|-----|----------|-----------|-------|
| 1 | ISSUED FOR INFORMATION | AS | APR 2025 | DESIGNED | AS |
| 2 | ISSUED FOR CONSENT | AS | JUN 2025 | DRAWN | AS |
| | | | | CHECKED | BLO |
| | | | | A DDDOVED | DE |






| ARATAKI DEVELOPMENT - HAVELOCK NORTH | 1 |
|--------------------------------------|---|
| OVERLAND FLOW SECTIONS | |

| STATUS | ISSUED FOR CONSENT | REV |
|---------|---------------------------|-----|
| SCALE | 1:100 @ A3 | 2 |
| COUNCIL | HASTINGS DISTRICT COUNCIL | |
| DWG NO | o P24-244-00-3909-DR | |

GENERAL NOTES

- ALL WORKS AND MATERIALS SHALL COMPLY WITH HASTINGS DISTRICT COUNCIL STANDARDS FOR ENGINEERING DESIGN AND CONSTRUCTION. ANY AMBIGUITY BETWEEN THESE DRAWINGS AND COUNCIL STANDARDS SHALL BE REFERRED TO THE ENGINEER FOR CLARIFICATION.
- 2. ALL RAINGARDEN CONNECTIONS TO BE CCTV'D AND ASBUILTED.
- ALL RAINGARDEN CONNECTIONS TO BE CONSTRUCTED TO PUBLIC DRAINAGE STANDARDS. CONNECTIONS CROSSING UNDER ROADS TO BE HARDFILL BACKFILLED WITH MINIMUM IM COVER.
- 4. THE CONTRACTOR IS RESPONSIBLE TO SUPPLY WOODS ENGINEERS WITH THREE IMAGES OF EACH RAINGARDEN WITH THE IDENTIFYING NUMBER CLEARLY SHOWN AS FOLLOWS:
 - POST EXCAVATION WITH ALL PLUMBING IN PLACE
 - POST PLACEMENT OF DRAINAGE AGGREGATE; POST PLACEMENT OF TRANSITION LAYER.
- 5. TRANSITION LAYER IS TO CONSIST OF 50MM #3 SAND
- 6. A MINIMUM OF 50MM BEDDING LAYER IS TO BE PROVIDED FOR THE UNDER DRAIN PIPE AND THE UNDER DRAIN MEDIA IS TO BE SAP20/7".

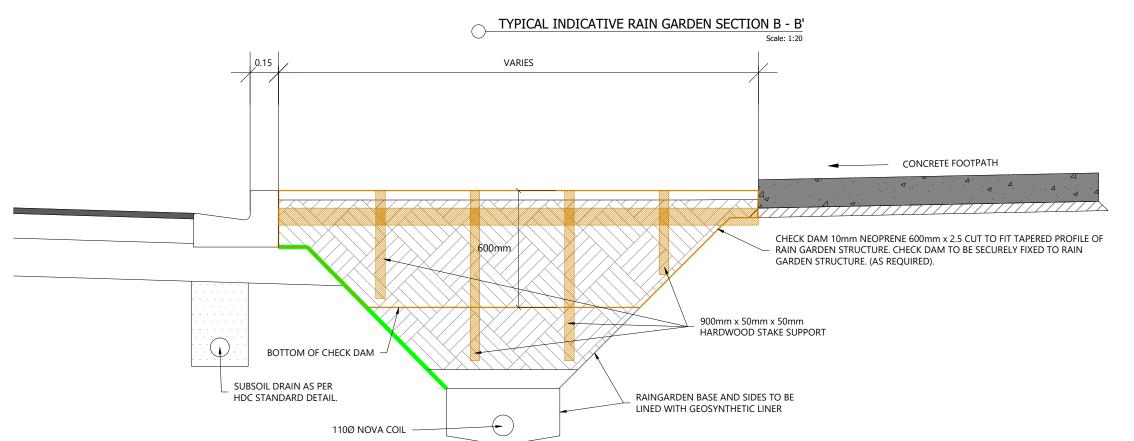

SCALEBAR (m) 0 0.2 SCALE | 1:20 @A3 | 1:10 @A1|

REVISION DETAILS INT DATE SURVEYED WOODS
2 ISSUED FOR CONSENT TB JUNE 2025 DESIGNED TB
DRAWN TB
CHECKED BLO
APPROVED BF

BUILDING B, LEVEL 1 8 NUGENT ST, GRAFTON, AUCKLAND 1023 +64 9 308 9229 WOODS.CO.NZ




TYPICAL INDICATIVE RAIN GARDEN SECTION C - C'


ARATAKI DEVELOPMENT - HAVELOCK NORTH


TYPICAL RAINGARDEN DETAILS
CROSS SECTIONS


| STATUS | ISSUED FOR CONSENT | REV |
|---------|-----------------------------------|-----|
| SCALE | AS SHOWN | 2 |
| COUNCIL | COUNCIL HASTINGS DISTRICT COUNCIL | |
| DWG NO | P24-244-00-3951-DR | |


DETAILS.D.W.G

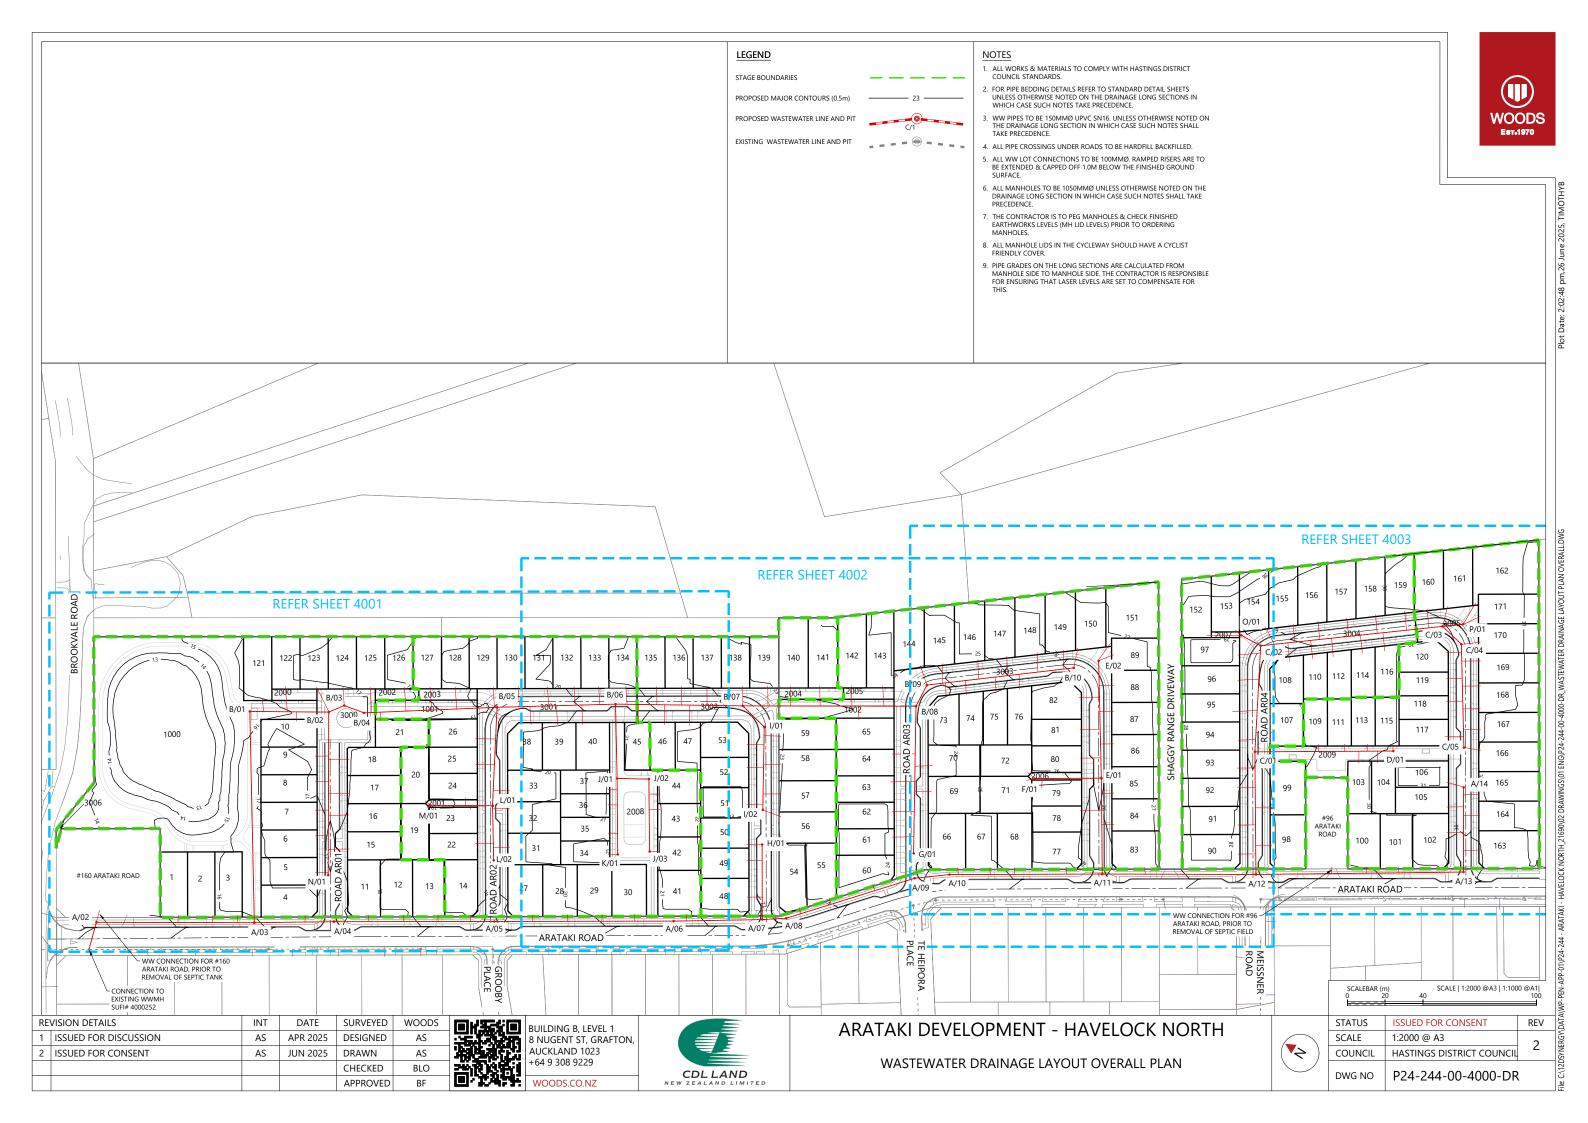

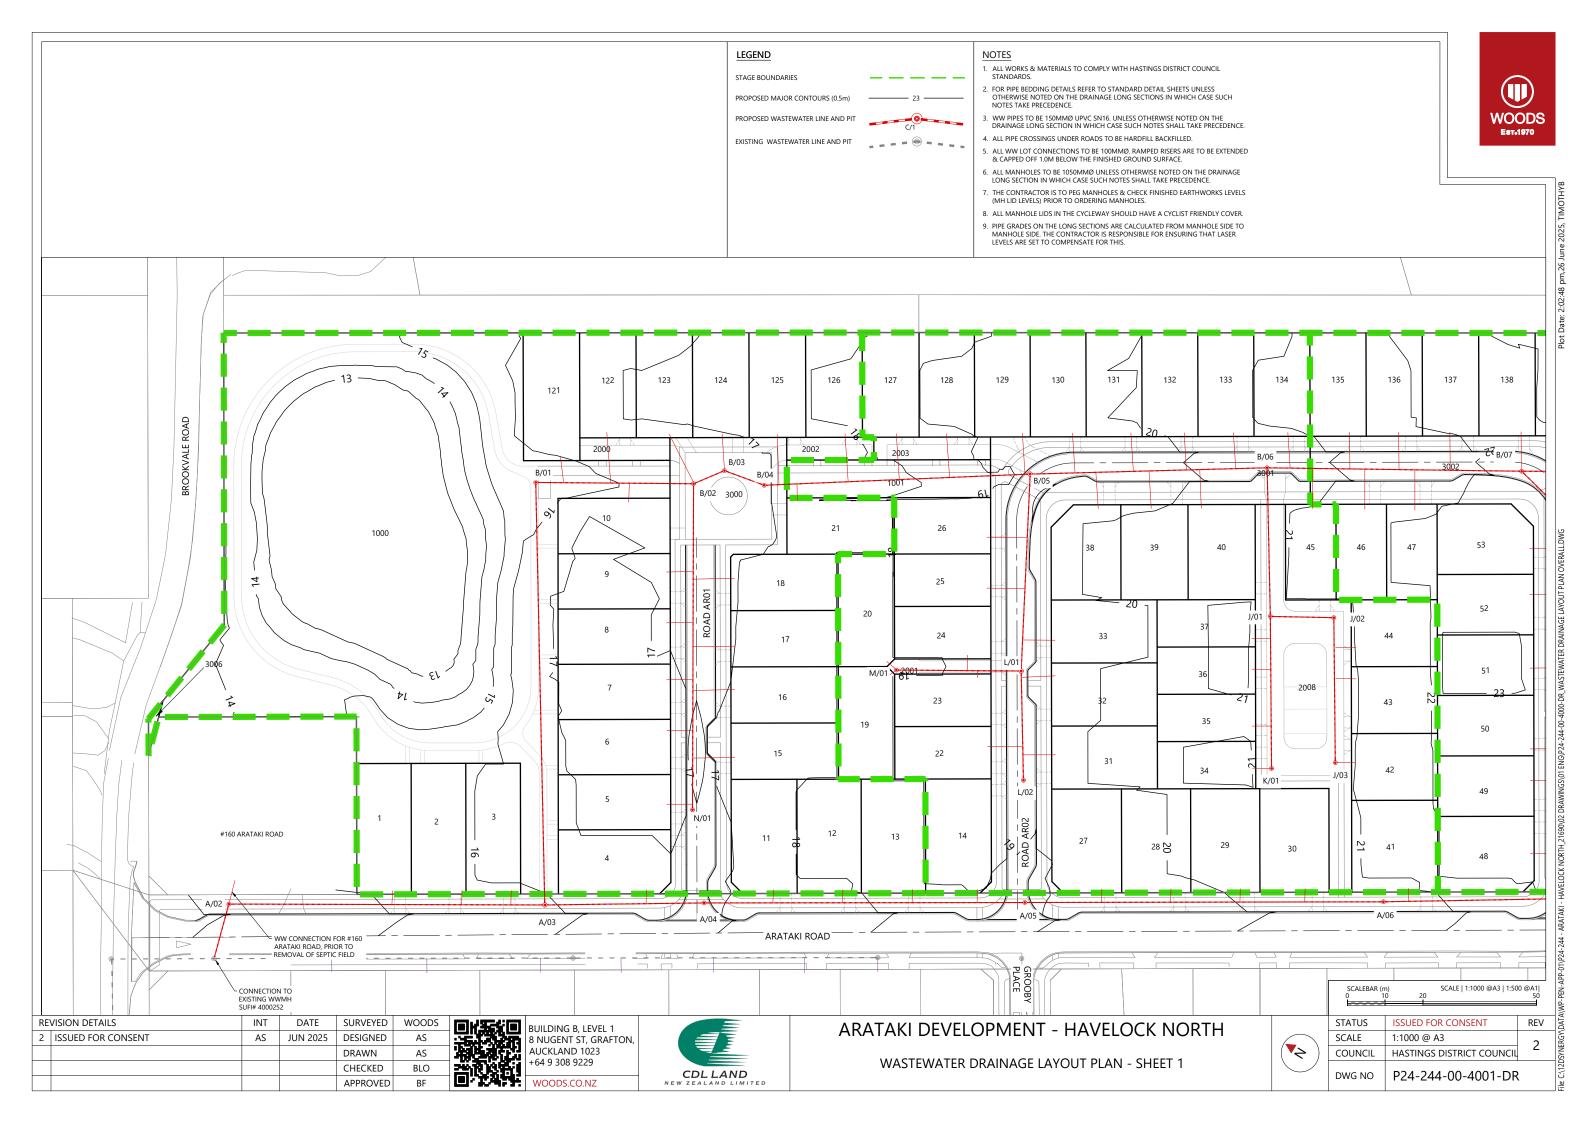

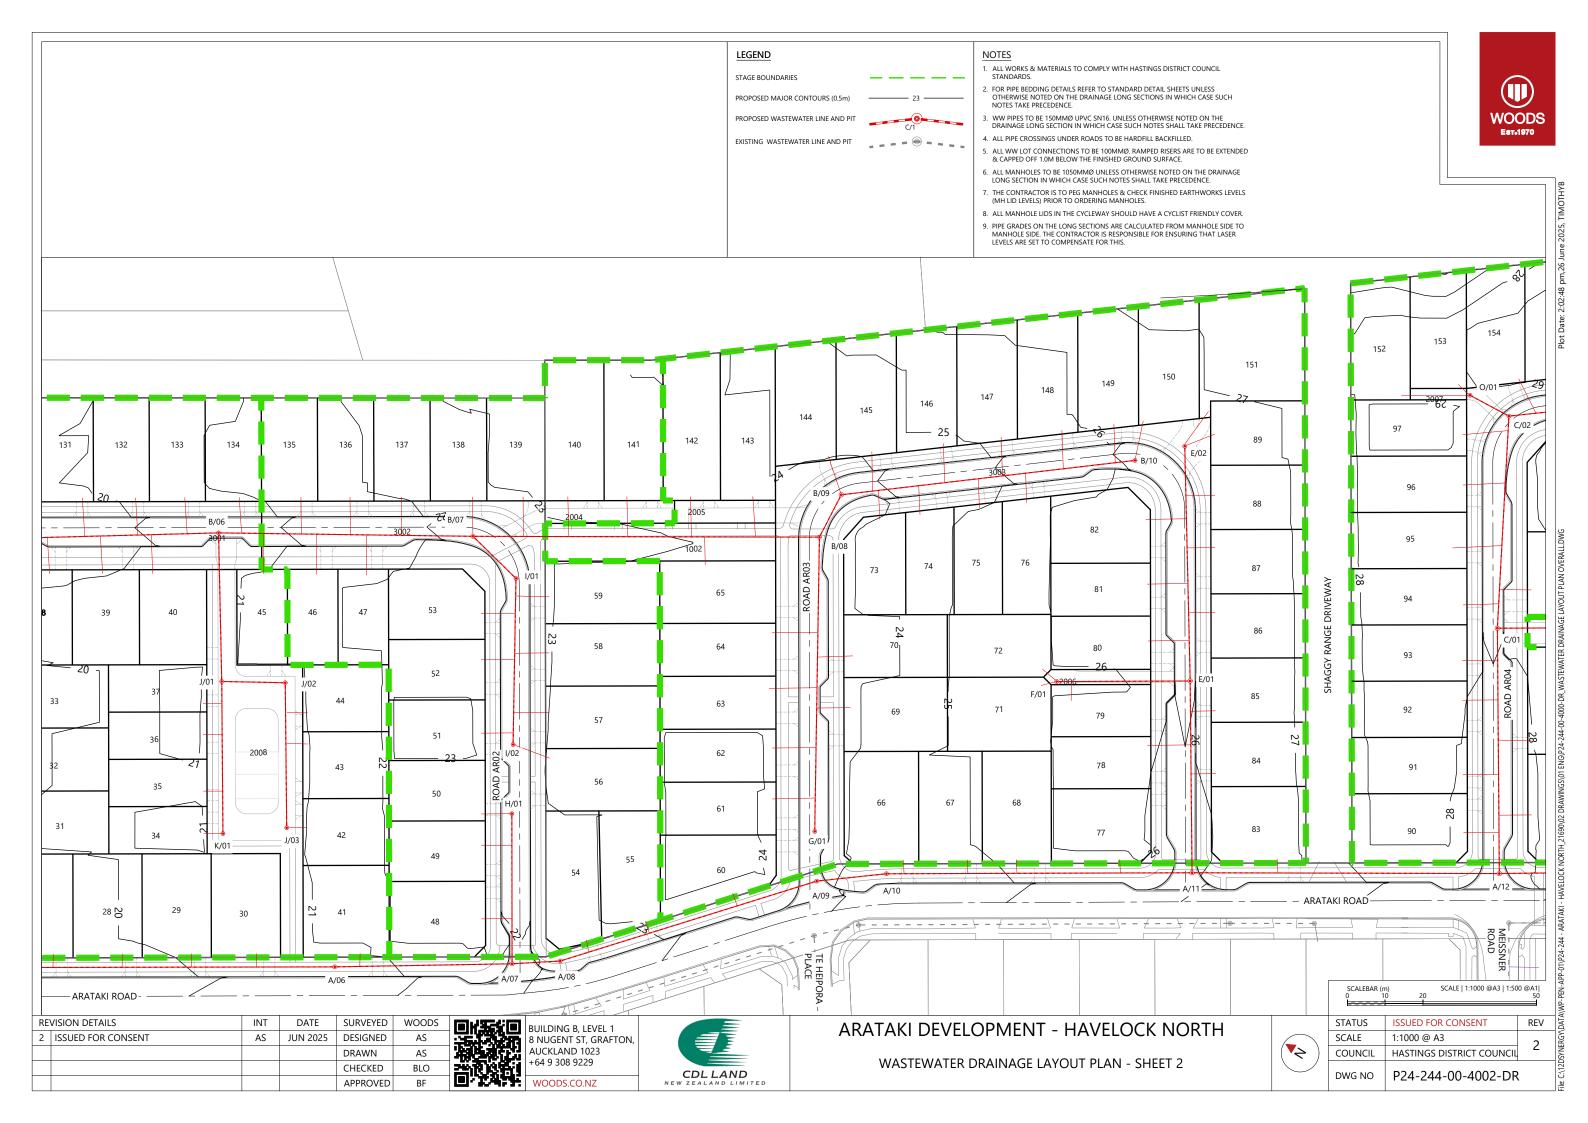

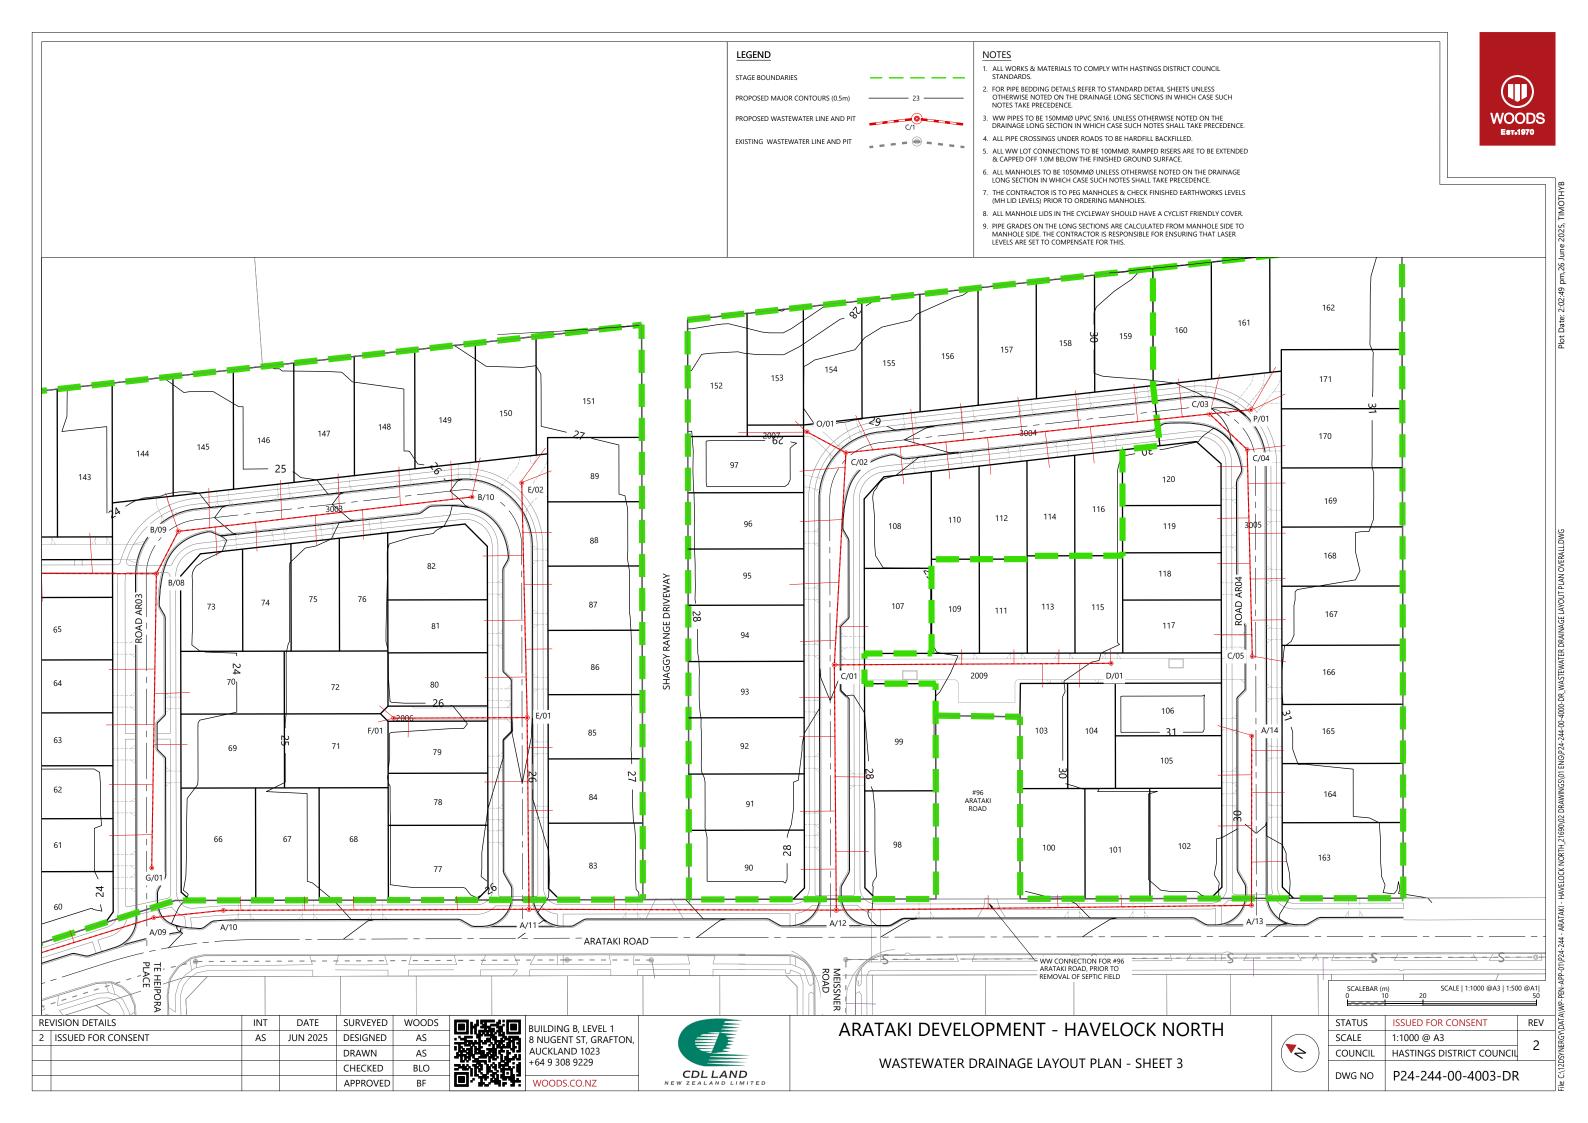

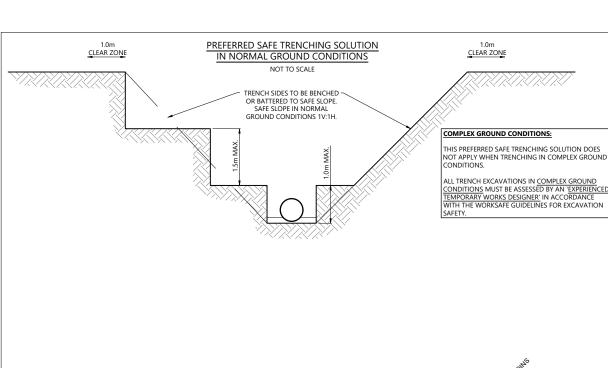

SAFE TRENCHING NOTES:

- $1. \ \ THIS \ DIAGRAM \ SHOWS \ THE \ PREFERRED \ SAFE \ TRENCHING \ SOLUTION \ IN \ NORMAL \ GROUND \ CONDITIONS.$
- 2. ALL TRENCH EXCAVATIONS MUST BE ASSESSED BY A 'COMPETENT PERSON' ON SITE IN ACCORDANCE WITH THE WORKSAFE GUIDELINES FOR EXCAVATION SAFETY.
- 3. IF THE PREFERRED TRENCHING SOLUTION IS NOT IMPLEMENTED THE CONTRACTOR MUST PROVIDE RECORDS OF THE SAFE TRENCHING ASSESSMENT COMPLETED BY THE <u>'COMPETENT PERSON'</u>.
- 4. TABLES 1 AND 2 OF THE WORKSAFE GUIDELINES SETOUT THE RECOMMENDED COMPETENCIES FOR THE 'COMPETENT PERSON'.
- 5. GROUND CONDITIONS AS DEFINED IN TABLES 1 AND 2 OF THE WORKSAFE GUIDELINES:

NORMAL GROUND CONDITIONS:
GENERALLY FLAT OPEN GROUND, WITH LITTLE OR NO SURCHARGE LOADING, FAVOURABLE GROUND CONDITIONS, OFF SET
FROM NEARBY STRUCTURES AND SENSITIVE INFRASTRUCTURE. GROUNDWATER CAN BE CONTROLLED WITH SIMPLE METHODS,
SUCH AS A SUMP PUMP PARANGEMENT.

COMPLEX GROUND CONDITIONS:
THE GROUND CONDITIONS INCLUDE VERY WEAK OR SENSITIVE SOILS, GROUNDWATER THAT REQUIRES SPECIALIST DEWATERING, OR LOCATIONS NEAR STRUCTURES AND SENSITIVE INFRASTRUCTURE. THESE CONDITIONS WOULD RESULT IN AN ELEVATED RISK WHEN CONSTRUCTING THE EXCAVATION.



| EXMH 4000252 | 03 450mm IL 12.86 A/02 (MH10500) (MH10500) (MH10500) #160 ARATAKI ROAD | | NHIP BOOM INTERNAL DROPPER | A/04 (MH1050Ø) | | A/05 (MH1050Ø) | | A/06 ((MH10500) | HIW) |
|-------------------------|---|-------------------|----------------------------|--------------------------|-------------------|---|-------------------|--------------------|-----------|
| PIPE DIAMETER PIPE TYPE | 150Ø UPVC SN16 | 150Ø UPVC SN16 | 150Ø UPVC SN10 | 6 | 150Ø UPVC SN16 | | 150Ø UPVC SN16 | 150Ø UPVC SN | V16 |
| PIPE GRADE | 1.00% | 0.86% | 1.72% | | 2.32% | | 1.97% | 1.84% | |
| DEPTH TO INVERT \$ | 7.00 2.00 2.00 2.00 2.00 2.00 2.00 2.00 | | 34 8 | 45 | | 1.44 | | 4 4 | 47 |
| | 12.38 1.70 12.38 1.70 12.46 12.53 1.65 12.57 1.61 | | 13.29 2.64 14.59 1.34 | 15.32 1.45 15.35 1.45 | | 1732 1.735 1. | | 1922 1.44 | |
| MANHOLE LID LEVEL | 12 4.08 12 12 12 12 12 4.18 12 | | 13.93 14 | 92 | | 71 77 77 | | .65 19 | 20 20 |
| CHAINAGE/ LENGTH | 0 7, 14.94 4, 4, 4, 4, 4, 4, 4, | 83.59 | 55 65 86 42.14 | 140.67 16. | 84.86 | 225.53 18 | 94.88 | 27 24 26.92 | 367.33 21 |
| | Α | | | | | | | | |

| SCAL | EBAR (m) | | SCALE 1:1000 @A3 1:500 @A1 | D-QQ |
|--------|----------|----|--------------------------------|------|
| HOR. 0 | 10 | 20 | 50 | ⊲ |
| ERT. | 2 | 4 | 10 | PEN |
| | | | SCALE 1:200 @A3 1:100 @A1 | ٩ |

| RE' | VISION DETAILS | INT | DATE | SURVEYED | WOODS |
|-----|-----------------------|-----|-----------|----------|-------|
| 1 | ISSUED FOR DISCUSSION | AS | APR 2025 | DESIGNED | AS |
| 2 | ISSUED FOR CONSENT | ТВ | JUNE 2025 | DRAWN | AS |
| | | | | CHECKED | BLO |
| | | | | APPROVED | BF |




BUILDING B, LEVEL 1
8 NUGENT ST, GRAFTC
AUCKLAND 1023
+64 9 308 9229
WOODS.CO.NZ 8 NUGENT ST, GRAFTON,



ARATAKI DEVELOPMENT - HAVELOCK NORTH WASTEWATER LONGSECTION SHEET 1

| STATUS | ISSUED FOR CONSENT | REV |
|---------|---------------------------|-----|
| SCALE | H 1:1000 V 1:200 @ A3 | 2 |
| COUNCIL | HASTINGS DISTRICT COUNCIL | |
| DWG NO | P24-244-00-4500-DR | |



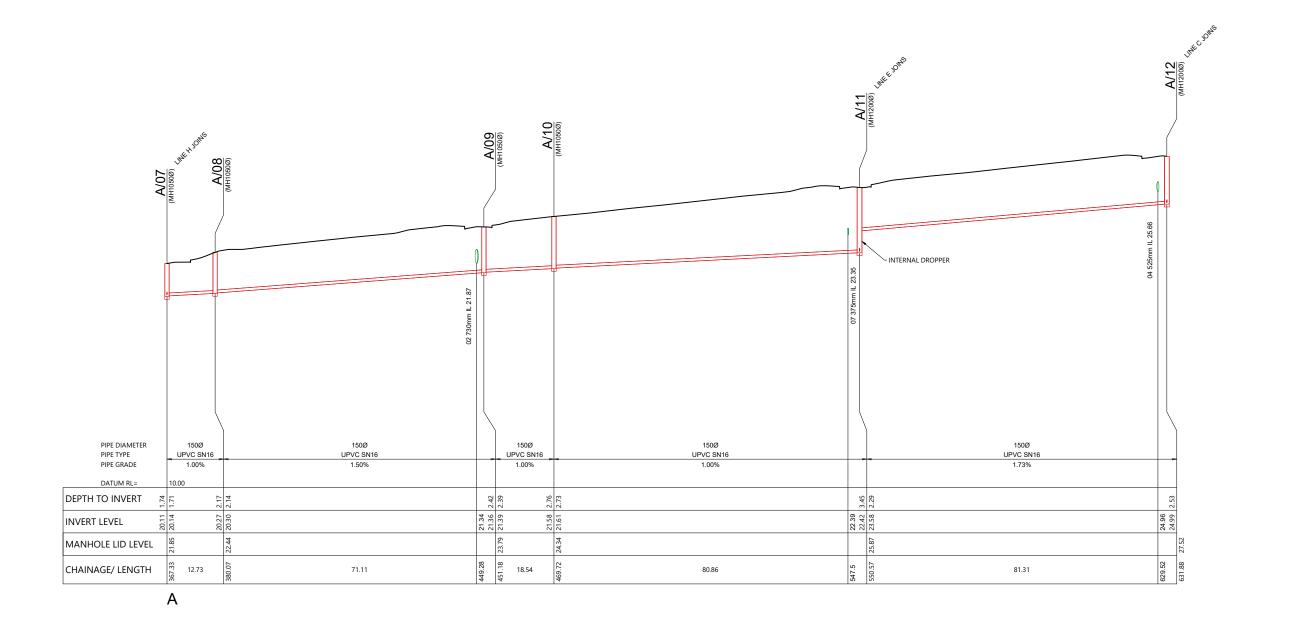

SCALEBAR (m) HOR. 0 10 SCALE | 1:1000 @A3 | 1:500 @A1| 50 SCALE | 1:200 @A3 | 1:100 @A1|

| REVISION DETAILS | | INT | DATE | SURVEYED | WOODS |
|------------------|-----------------------|-----|-----------|----------|-------|
| 1 | ISSUED FOR DISCUSSION | AS | APR 2025 | DESIGNED | AS |
| 2 | ISSUED FOR CONSENT | ТВ | JUNE 2025 | DRAWN | AS |
| | | | | CHECKED | BLO |
| | | | | APPROVED | BF |






| ARATAKI DEVELOPMENT - HAVELOCK NORTH |
|--------------------------------------|
| WASTEWATER LONGSECTION |
| SHEET 2 |

| STATUS | ISSUED FOR CONSENT | REV |
|---------|---------------------------|-----|
| SCALE | H 1:1000 V 1:200 @ A3 | 2 |
| COUNCIL | HASTINGS DISTRICT COUNCIL | |
| DWG NO | P24-244-00-4501-DR | |



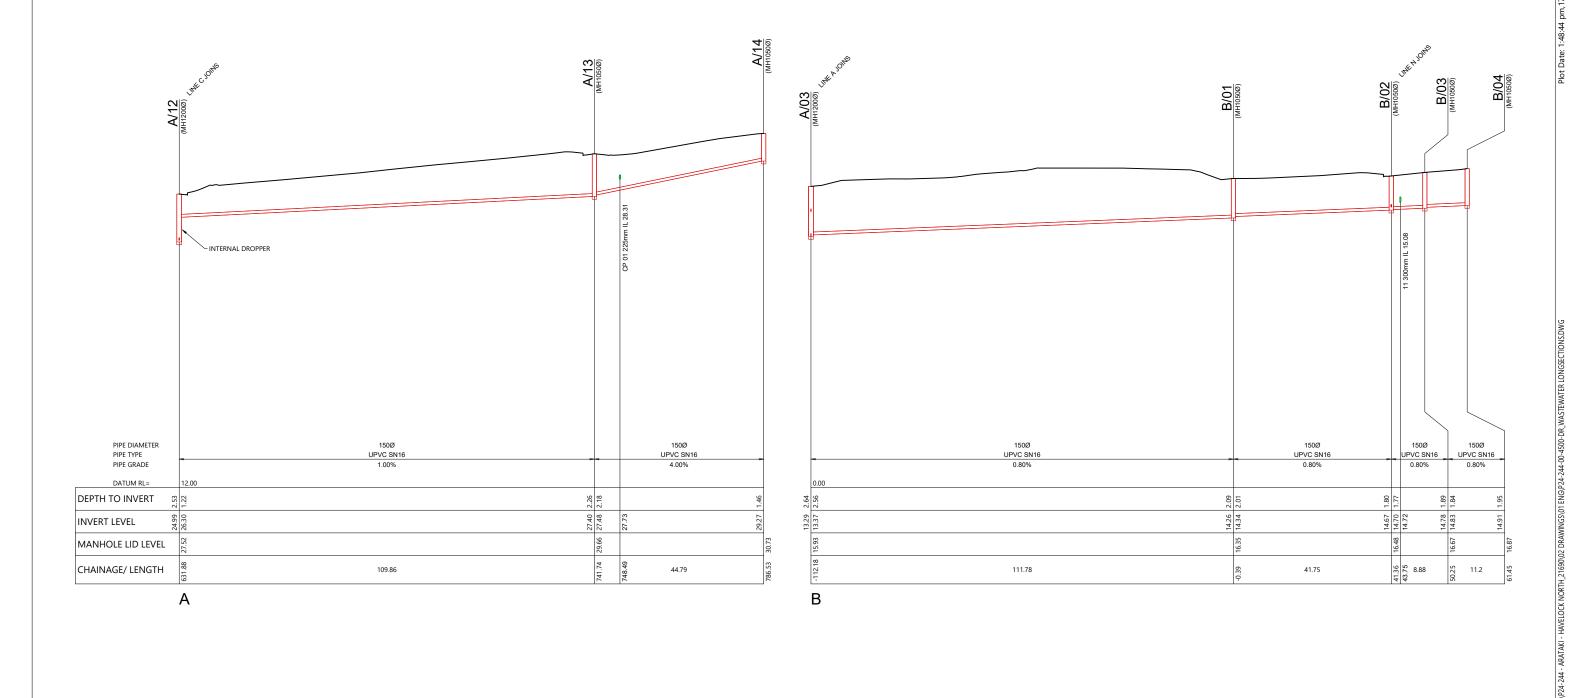

| SCALI | EBAR (m) | | SCALE 1:1000 @A3 1:500 @A1 | |
|--------|----------|----|-------------------------------------|--|
| HOR. 0 | 10 | 20 | 50 | |
| VERT. | 2 | 4 | 10 SCALE 1:200 @A3 1:100 @A1 | |

| RE' | REVISION DETAILS | | DATE | SURVEYED | WOODS |
|-----|-----------------------|----|-----------|----------|-------|
| 1 | ISSUED FOR DISCUSSION | AS | APR 2025 | DESIGNED | AS |
| 2 | ISSUED FOR CONSENT | ТВ | JUNE 2025 | DRAWN | AS |
| | | | | CHECKED | BLO |
| | | | | APPROVED | BF |






| ARATAKI DEVELOPMENT - HAVELOCK NORTH |
|--------------------------------------|
| WASTEWATER LONGSECTION |
| SHEET 3 |

| STATUS | ISSUED FOR CONSENT | REV |
|---------|---------------------------|-----|
| SCALE | H 1:1000 V 1:200 @ A3 | 2 |
| COUNCIL | HASTINGS DISTRICT COUNCIL | 2 |
| DWG NO | P24-244-00-4502-DR | |



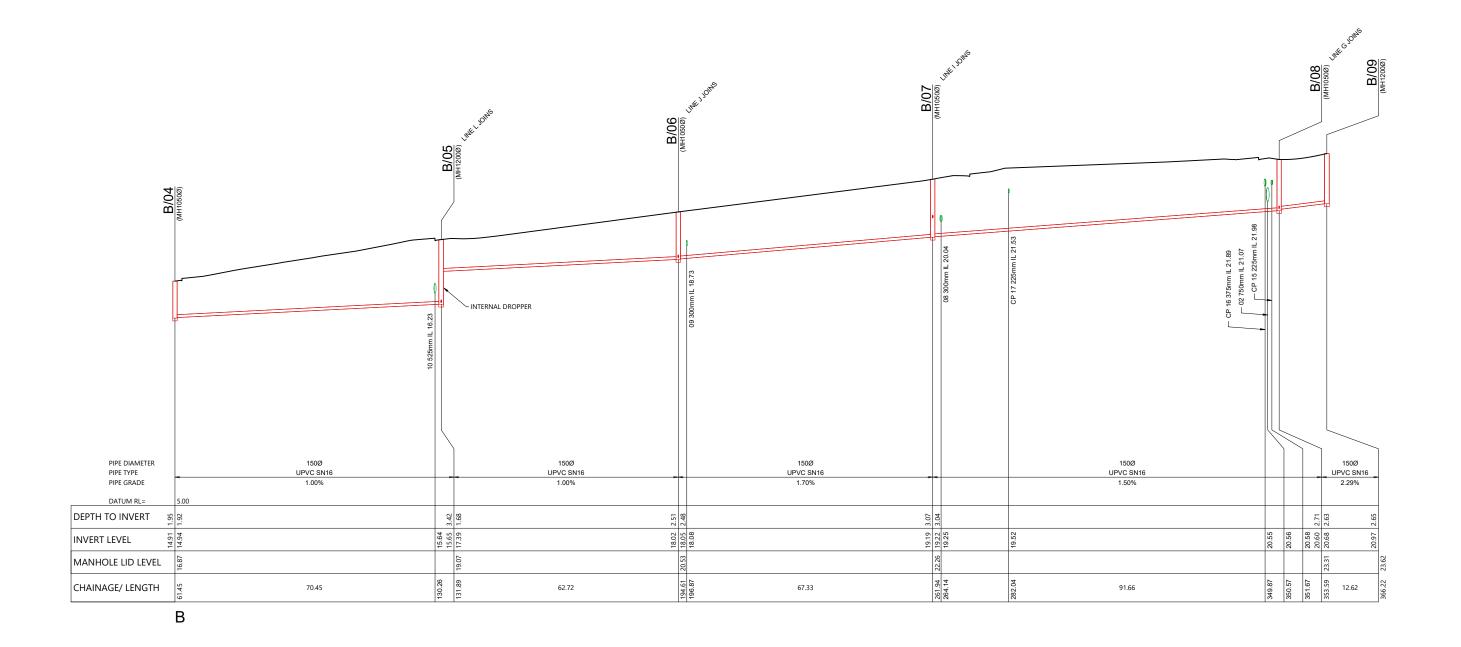

| SCAL | EBAR (m) | | SCALE 1:1000 @A3 1:500 @A1 |
|--------|----------|----|-------------------------------------|
| HOR. 0 | 10 | 20 | 50 |
| VERT. | 2 | 4 | 10 SCALE 1:200 @A3 1:100 @A1 |

| RE | REVISION DETAILS | | DATE | SURVEYED | WOODS |
|----|-----------------------|----|-----------|----------|-------|
| 1 | ISSUED FOR DISCUSSION | AS | APR 2025 | DESIGNED | AS |
| 2 | ISSUED FOR CONSENT | ТВ | JUNE 2025 | DRAWN | AS |
| | | | | CHECKED | BLO |
| | | | | APPROVED | BF |






| ARATAKI DEVELOPMENT - HAVELOCK NORTH | | | | | |
|--------------------------------------|--|--|--|--|--|
| WASTEWATER LONGSECTION | | | | | |
| SHEET 4 | | | | | |

| | STATUS | ISSUED FOR CONSENT | REV |
|---------------------------|---------|---------------------------|-----|
| | SCALE | H 1:1000 V 1:200 @ A3 | 2 |
| | COUNCIL | HASTINGS DISTRICT COUNCIL | 2 |
| DWG NO P24-244-00-4503-DF | | | |



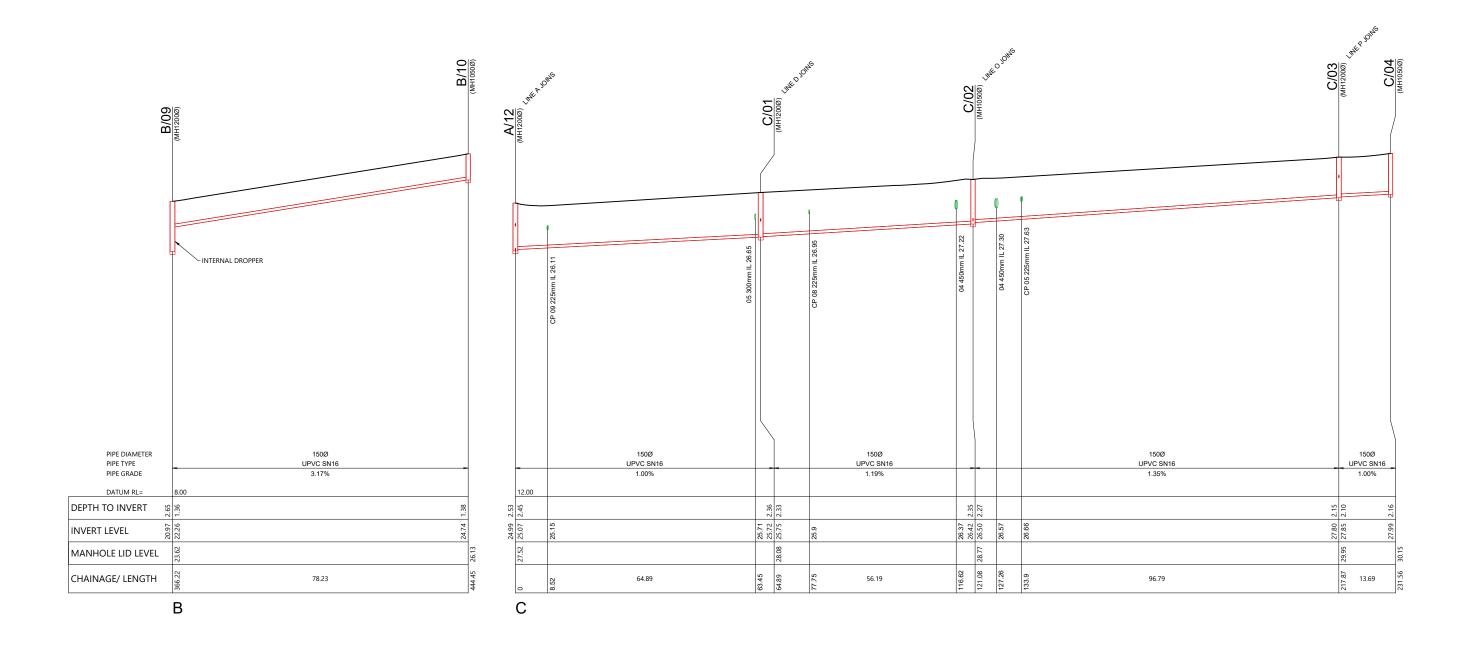

| | U | 150Ø PVC SN1 1.00% | 6 | | A\WP-PEN-APP-01\P24-244 - ARATAKI - HAVELOCK NORTH_21690\02 DRAWINGS\01 ENG\P24-244-00-4500-DR_WASTEWATER LONGSECTIONS.DWG |
|--|--------|--------------------------|-------|-------------------------------------|--|
| 2.15 | 2.10 | | 2.16 | | 1 ENG/P |
| 27.80 2.15 | 27.85 | | 27.99 | | /INGS/0 |
| | 29.95 | | | 30.15 | 2 DRAV |
| | 217.87 | 13.69 | | 231.56 | H_21690\0 |
| | | | | | ARATAKI - HAVELOCK NORTI |
| SCALEBAR (m HOR. 0 11 L=================================== | | 20 | | CALE 1:1000 @A3 1:500 @A1 50 | EN-APP-01\P24-244 - |
| VEINI. Z | | 4 | 9 | 10 SCALE 1:200 @A3 1:100 @A1 | 4/WP-P |

| RE | REVISION DETAILS | | DATE | SURVEYED | WOODS |
|----|-----------------------|----|-----------|----------|-------|
| 1 | ISSUED FOR DISCUSSION | AS | APR 2025 | DESIGNED | AS |
| 2 | ISSUED FOR CONSENT | ТВ | JUNE 2025 | DRAWN | AS |
| | | | | CHECKED | BLO |
| | | | | APPROVED | BF |






| ARATAKI DEVELOPMENT - HAVELOCK NORTH |
|--------------------------------------|
| WASTEWATER LONGSECTION |
| SHEET 5 |

| STATUS | ISSUED FOR CONSENT | REV |
|---------------------------|---------------------------|-----|
| SCALE | H 1:1000 V 1:200 @ A3 | 2 |
| COUNCIL | HASTINGS DISTRICT COUNCIL | 2 |
| DWG NO P24-244-00-4504-DR | | |



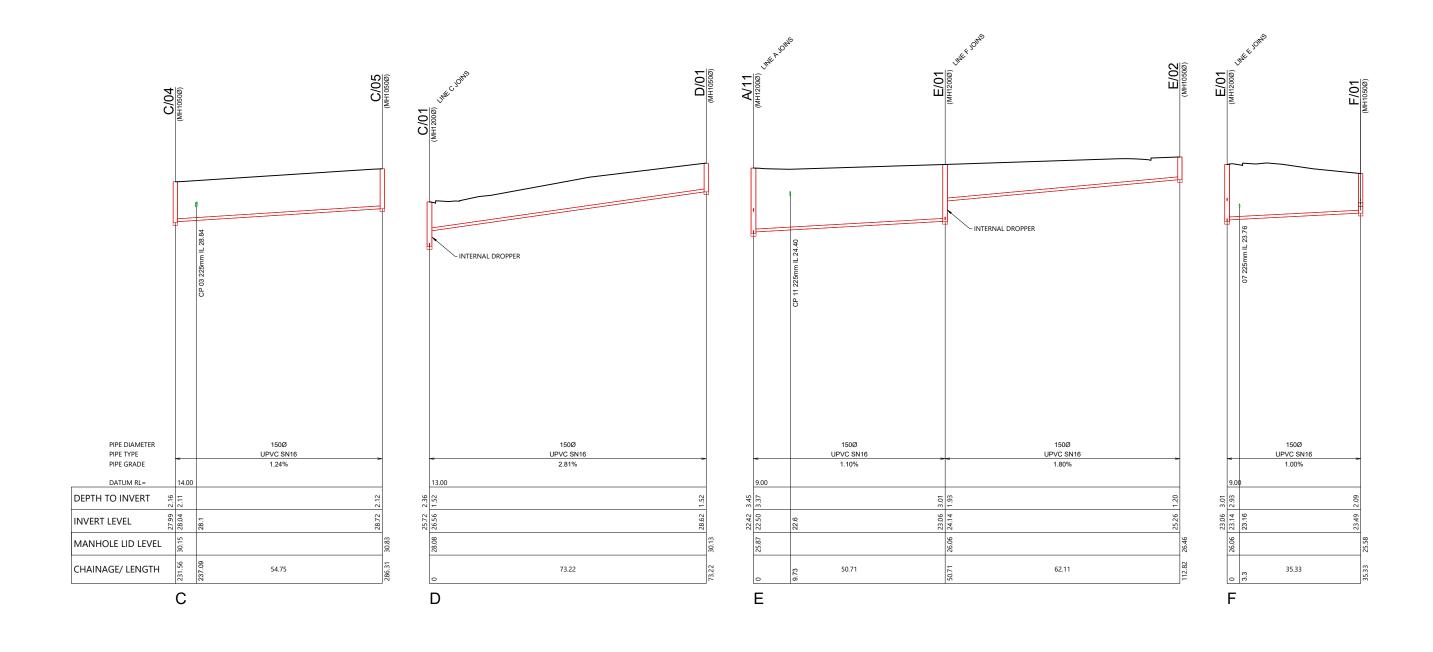

| SCAL | EBAR (m) | | SCALE 1:1000 @A3 1:500 @A1 |
|--------|----------|----|-------------------------------------|
| HOR. 0 | 10 | 20 | 50 |
| VERT. | 2 | 4 | 10 SCALE 1:200 @A3 1:100 @A1 |

| RE | VISION DETAILS | INT | DATE | SURVEYED | WOODS |
|----|-----------------------|-----|-----------|----------|-------|
| 1 | ISSUED FOR DISCUSSION | AS | APR 2025 | DESIGNED | AS |
| 2 | ISSUED FOR CONSENT | ТВ | JUNE 2025 | DRAWN | AS |
| | | | | CHECKED | BLO |
| | | | | APPROVED | BF |






| ARATAKI DEVELOPMENT - HAVELOCK NORTH |
|--------------------------------------|
| WASTEWATER LONGSECTION |
| SHEET 6 |

| STATUS | ISSUED FOR CONSENT | REV |
|---------------------------|---------------------------|-----|
| SCALE | H 1:1000 V 1:200 @ A3 | 2 |
| COUNCIL | HASTINGS DISTRICT COUNCIL | |
| DWG NO P24-244-00-4505-DR | | |



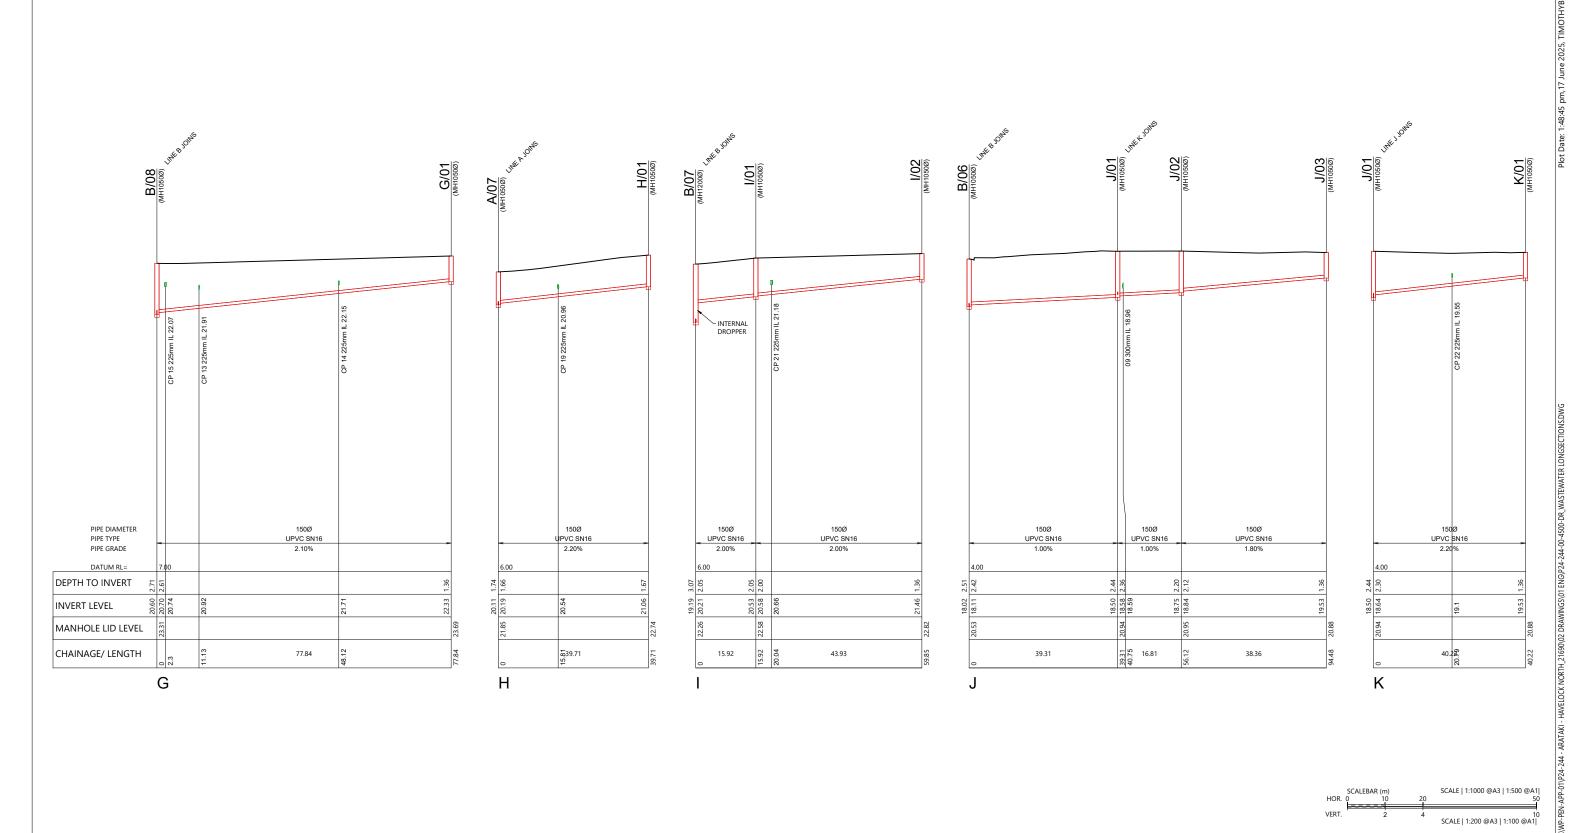

| SCAL | EBAR (m) | | SCALE 1:1000 @A3 1:500 @A1 |
|--------|----------|----|-------------------------------------|
| HOR. 0 | 10 | 20 | 50 |
| VERT. | 2 | 4 | 10 SCALE 1:200 @A3 1:100 @A1 |

| RE' | VISION DETAILS | INT | DATE | SURVEYED | WOODS |
|-----|-----------------------|-----|-----------|----------|-------|
| 1 | ISSUED FOR DISCUSSION | AS | APR 2025 | DESIGNED | AS |
| 2 | ISSUED FOR CONSENT | ТВ | JUNE 2025 | DRAWN | AS |
| | | | | CHECKED | BLO |
| | | | | APPROVED | BF |






| ARATAKI DEVELOPMENT - HAVELOCK NORTH |
|--------------------------------------|
| WASTEWATER LONGSECTION |
| SHEET 7 |

| | STATUS | ISSUED FOR CONSENT | REV |
|---------------------------|---------|---------------------------|-----|
| | SCALE | H 1:1000 V 1:200 @ A3 | 2 |
| | COUNCIL | HASTINGS DISTRICT COUNCIL | 2 |
| DWG NO P24-244-00-4506-DR | | | |



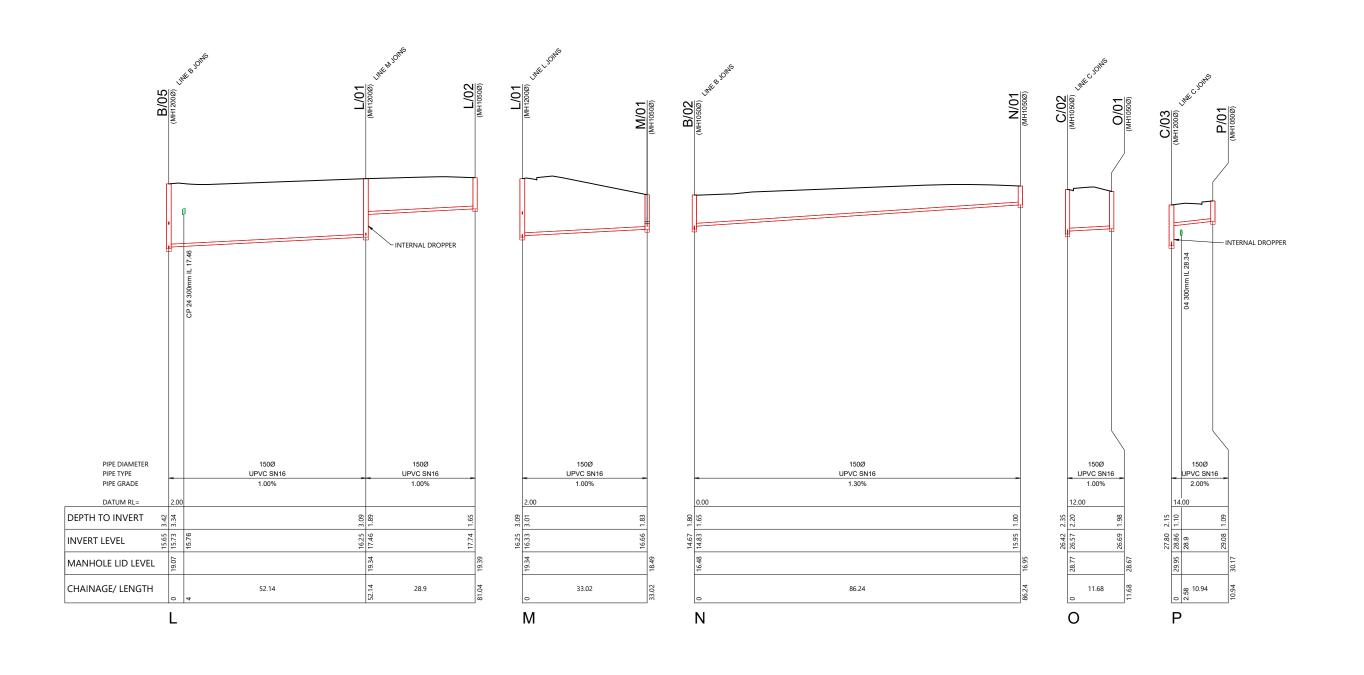

| SCAL | EBAR (m) | | SCALE 1:1000 @A3 1:500 @A1 |
|--------|----------|----|-------------------------------------|
| HOR. 0 | 10 | 20 | 50 |
| VERT. | 2 | 4 | 10 SCALE 1:200 @A3 1:100 @A1 |

| RE | VISION DETAILS | INT | DATE | SURVEYED | WOODS |
|----|-----------------------|-----|-----------|----------|-------|
| 1 | ISSUED FOR DISCUSSION | AS | APR 2025 | DESIGNED | AS |
| 2 | ISSUED FOR CONSENT | ТВ | JUNE 2025 | DRAWN | AS |
| | | | | CHECKED | BLO |
| | | | | APPROVED | BF |





| ARATAKI DEVELOPMENT - HAVELOCK NORTH |
|--------------------------------------|
| WASTEWATER LONGSECTION |
| SHEET 8 |

| STATUS | ISSUED FOR CONSENT | REV |
|---------|---------------------------|-----|
| SCALE | H 1:1000 V 1:200 @ A3 | 2 |
| COUNCIL | HASTINGS DISTRICT COUNCIL | ۷ |
| DWG NO | P24-244-00-4507-DR | |

